



GROWTH MANAGEMENT DEPARTMENT STAFF REPORT
PONTE VEDRA OVERLAY DISTRICT
May 1, 2024 Special Public Meeting
ARC 2024-04 Golf Club Patio Renovation (Ponte Vedra Inn & Club)

To: Architectural Review Committee
Staff: Amanda Rose, Senior Planner | Brandon Tirado, Planner
Date: April 22, 2024

Applicant: Mark Klone
ELM
mklone@elmplan.com

Location: 35 Pablo Road
FLUM: Residential B (RES-B)
Zoning: PUD, within the Ponte Vedra Resort PUD [Ordinance 2023-50](#)

Applicable Standards: Ordinance 2023-50 & Ponte Vedra Zoning District Regulations (PVZDR)

Summary of Request: Applicant is requesting design approval to remove an existing wooden pergola and renovate the exterior of the Golf Club Patio. Proposed changes include 1,200 square feet of concrete pavers and other impervious surfaces, construction of an outdoor fireplace, renovations to the existing wood deck, and installation of new landscaping, irrigation, and one (1) new exterior door, located at 35 Pablo Dr. within the Ponte Vedra Inn and Club. Lighting updates are also proposed. The applicant is also requesting approval for a potential canopy fabric replacement (e.g. “add alternate”). The applicant has confirmed they will be providing physical color/material samples for the Board to review at the hearing.

Project Location: The subject site is located within the Ponte Vedra Inn and Club property, on the south side of Pablo Road, approximately 0.16 miles west of the intersection of Pablo Road and Ponte Vedra Blvd. The proposed Golf Club Patio renovations will occupy an existing outdoor space that currently contains landscaping and a wooden deck with pergola.



Figure 1: General Location of the proposed renovations, as provided by the applicant.

Staff Review—Planning Division: Please refer to the submitted Site Plan, Existing Conditions Photographs, Materials, Landscape Plan, and Photometric Plan, provided below within Figures 2, 3A-B, 4A-C, 5A-B, 6A-B, 7A-B, and 8, along with corresponding staff comments.


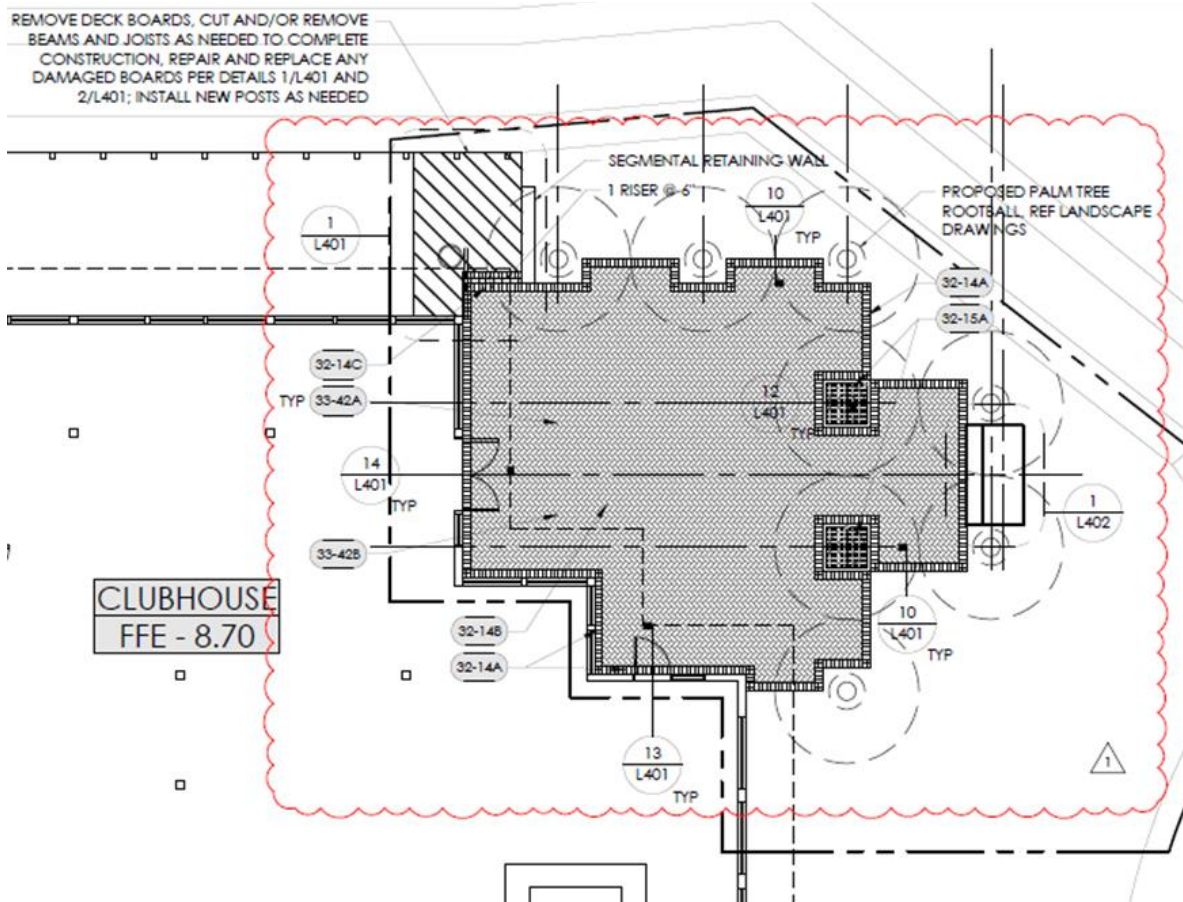


Figure 2: Site Plan, as provided by the applicant.



Figures 3A-B: Existing Conditions—Staff Photographs of Existing Conditions, taken April 11, 2024.

***Fireplace (See Figures 4A-C)**—The applicant proposes to paint the outdoor fireplace white to match the existing columns at the golf drop-off (see Figure 4C), and it is also noted that all paint colors used for the building, doors, and modifications to the wood deck will match the existing colors. The colors and materials of the proposed fireplace appear to be consistent with Section VIII.Q.5(d) Architectural Design Standards and Section VIII.Q.5(e). Design Elements and Materials of the PVZDR. The proposed design and color appear subdued and compatible with the existing Golf Club elements as well as with the overall expectations of the Ponte Vedra Overlay District.

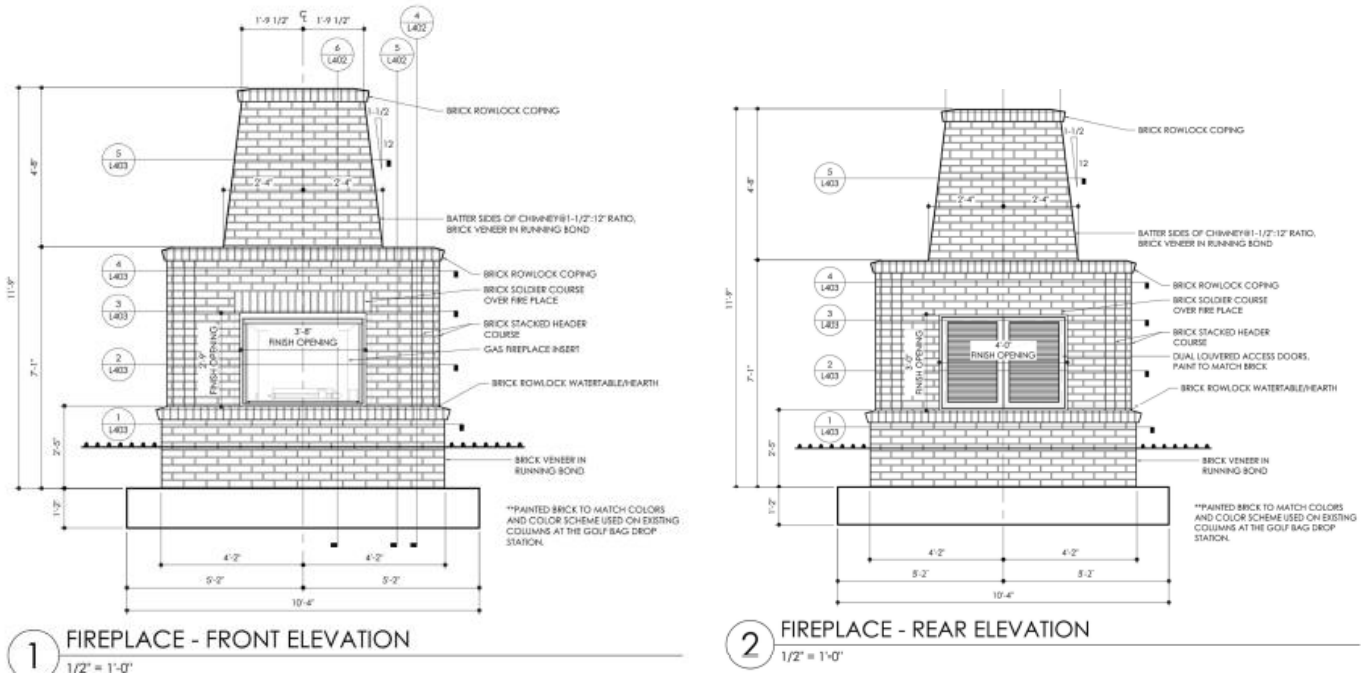

FIREPLACE PAINT TO MATCH EXISTING PAINT COLOR SCHEME FOR GOLF BAG DROP COLUMNS. CURRENTLY WHITE OR OFF-WHITE. COLOR TO BE MATCHED BY CONTRACTOR AT TIME OF PAINTING.

Figures 4A-C: Fireplace Elevations and Materials, as provided by the applicant.

***Patio Pavers (see Figures 5A-B)**—The colors and material of the proposed paver area appear to be consistent with PVZDR Section VIII.Q.5(e). Design Elements and Materials of the PVZDR. The proposed design and color appear subdued and in harmony with other locations within the Ponte Vedra Overlay District. The applicant notes that the proposed paver pattern and style matches that used at the Ocean Golf Course near the first tee.



4" X 8" CONCRETE PAVER
 HERRINGBONE PATTERN
 COLOR: HERITAGE (PRIMARY COLOR) 2%-5% RANDOM
 MIX OF CHARCOAL AND TAN BY TREMOR (OR SIMILAR)
 MATCH EXISTING PAVER PATTERNS AND MIX USED FOR
 OTHER PATIO AREAS



PAVER AREA BEHIND PONTE VEDRA HISTORIC INN, NEAR THE 1ST TEE FOR THE OCEAN GOLF COURSE

Figures 5A-B: Patio Paver Design, as provided by the applicant.

***Landscape Plan (see Figures 6A-B)**—The proposed Landscape Plan appears to be consistent with PVZDR Section VIII.Q.5(e). Design Elements and Materials of the PVZDR. Per PVZDR Section VIII.Q.5.e(8), the ARC may require utilization of particular landscape and plant species where a pattern of vegetation has been established or where such species are determined to be desired.

PLANT SCHEDULE								
SYMBOL	CODE	QTY	BOTANICAL NAME	COMMON NAME	NATIVE	SHADE	CANOPY	REMARKS
TREES								
	SFS	8	SABAL PALMETO	SABAL PALM	YES	NO	11'	16" C.T. HEIGHT, ALL TRUNKS TO BE STRAIGHT, MATCHED HEADS
SHRUBS								
	CPR	2	CORONILLA FRUTICOSA	T PLANT	YES		42" o.c.	30" HEIGHT, 18" - 24" SPREAD, 7 GAL, 42" OC
	GR	6	LOMANERA LONGIFOLIA 'ROMA 13'	PLATYUM BEAUTY VARRIATED HAT BUSH	NO		36" o.c.	18" - 21" HEIGHT AND SPREAD, 3 GAL, 36" OC
	ISS	4	LOLITRUM SIBIENSE 'SUNSHINE'	SUNSHINE CHINESE PRIVET	NO		36" o.c.	18" - 24" HEIGHT AND SPREAD, 3 GAL, 36" OC
	PHA	23	PODOCARPUS MAJORIVILLIS	JAPANESE PODOCARPUS	A.S.		36" o.c.	30" - 36" HEIGHT, 24" SPREAD MIN, 7 GAL, 36" OC
	ROR	34	RHOODOENDRON X 'BOULE'	AUTUMN STARBURST ENCORE AZALEA	YES		30" o.c.	18" X 18" HEIGHT AND SPREAD, 3 GAL, 30" OC, DRAWUP VARIETY OF REBLOOMING AZALEA, MATURE SIZE 3 - 4' HEIGHT AND SPREAD
GROUND COVERS								
	DIV	23	DIANELLA TASMANICA 'VARIEGATA'	FLAX LILY	NO		12" o.c.	14" - 16" HEIGHT, FULL PLANT, 1 GAL, 12" OC
	EG8	28	EVOLYLLUS GLOMERATUS 'BLISS DAZE'	BRAZILIAN DWARF MORNING GLORY	NO		9" o.c.	4" - 6" HEIGHT AND SPREAD, UNDER 9" OC
TURF GRASS								
	SCDA	274 SF	STENOCYPHELLUM SECUNDIFOLIUM 'FLORIFLUM'	FLORITAM ST. AUGUSTINE SOO	0			SOO - SEE SPEC

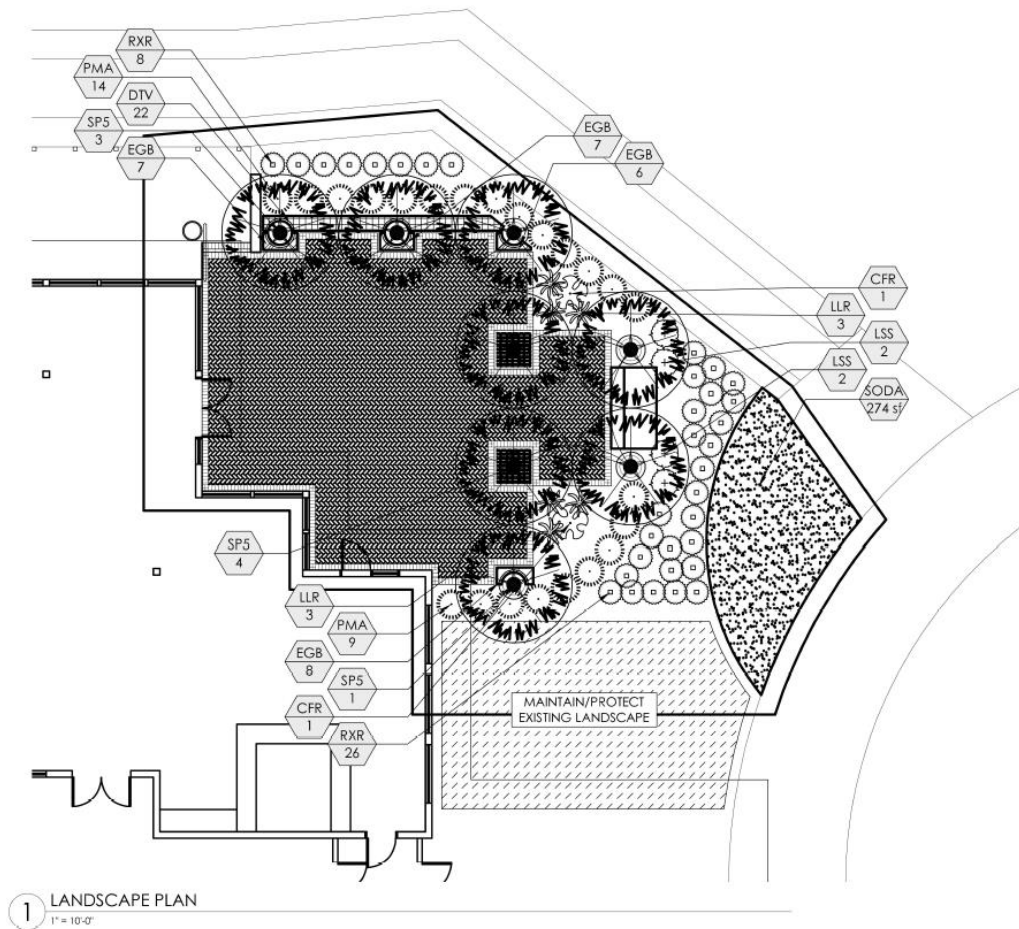


Figure 6A-B: Landscape Plan + Plant Schedule, as provided by the applicant.

***Photometric Plan (see Figures 7A-B)**—Per PVZDR Section VIII.Q.5.e(9), architectural lighting shall be recessed under roof overhangs or generated from a concealed light source or low-level light fixtures. Site lighting shall be of low intensity, shall be white light which does not distort colors and shall not spill over into adjoining properties, roadways, or in any way interfere with the vision of oncoming traffic.

The applicant notes that the proposed fixtures are designed to focus light onto the patio and to reduce glare from neighboring properties. The applicant states that the photometric plan shows lighting levels as high as 10 foot-candles but that the fixture selected allows for either a manual adjustment to lower output or to utilize a dimmer switch. Please also note that the applicant has indicated to Staff that festoon lighting has been removed from the proposal.

Staff has concerns about the Photometric Plan, as it does not demonstrate fully how the proposed lighting affects the adjacent right-of-way, specifically at the roadway. Staff has asked that the applicant provide additional information on the photometric levels near the property lines, as well as information about the light color/s.



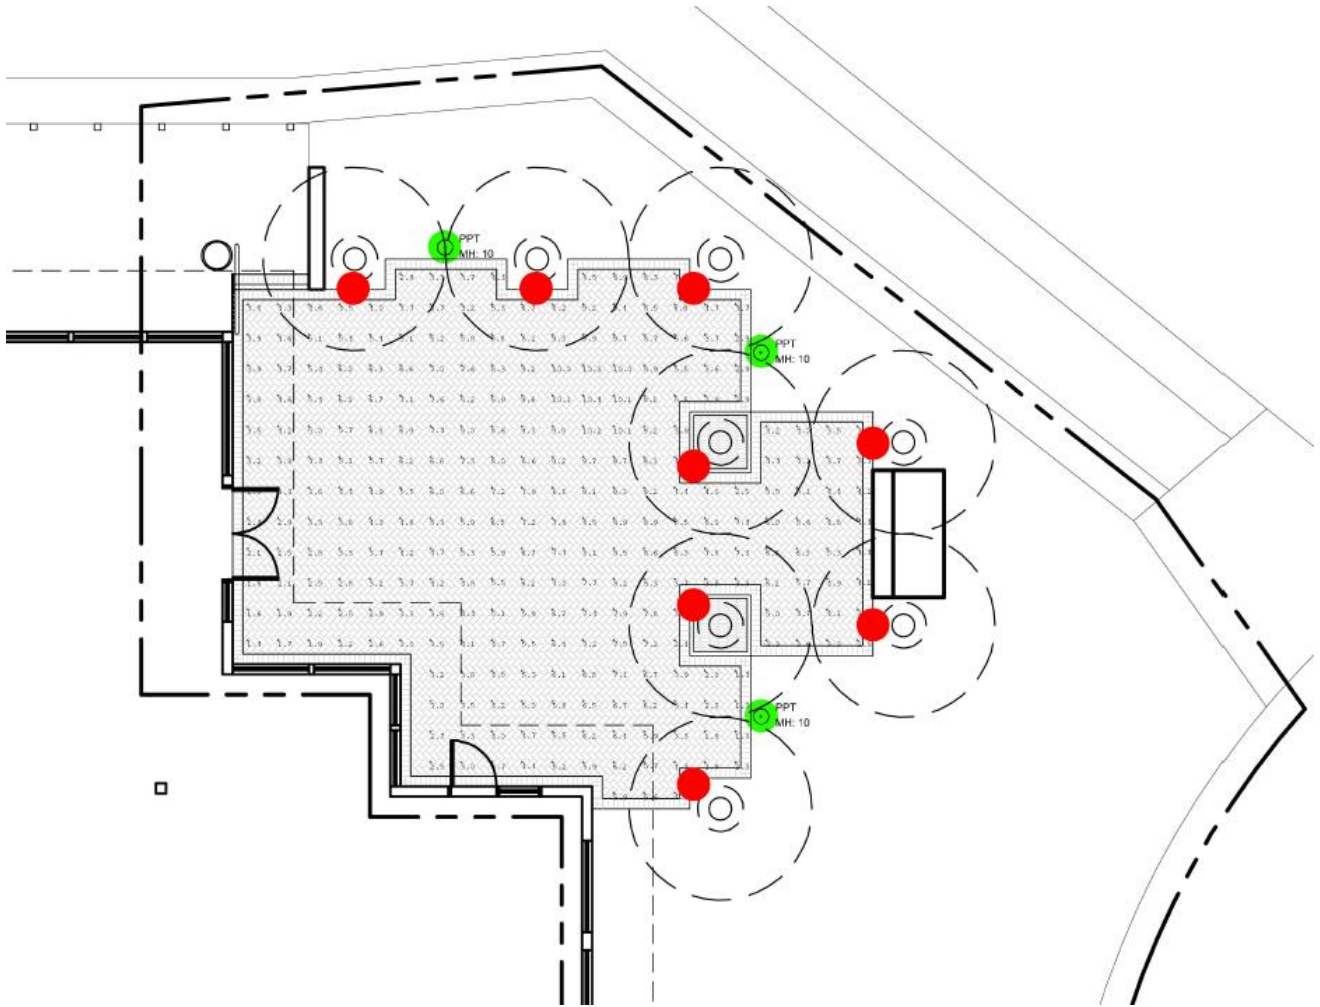


Figure 7A-B: Electrical Fixture Plan + Proposed Light Fixtures, as provided by applicant.



ADD ALTERNATE PATIO AWNING REPLACEMENT.

Canopy Fabric Replacement (see Figure 8)—The colors and material of the add alternate canopy fabric replacement appear to be consistent with PVZDR Section VIII.Q.5(e). Design Elements and Materials of the PVZDR, as the tones are subdued and the material is compatible with existing site conditions.

Figure 8: Canopy Fabric Replacement (Add Alternate), as proposed by the applicant.

Applicable Standards:

PVZDR Section Q.5.a. Development Standards.

- (1) Flat roof lines, or the appearance of flat roof lines are not permitted.
- (2) Work areas or storage doors and open bays shall not open toward, face or otherwise be visible from an Overlay District Delineated Roadway.
- (3) Building Heights shall be limited to two (2) Stories and thirty-five (35) feet, except that the maximum Building Height shall be twenty-five (25) feet where a Building is located less than one hundred and fifty (150) feet from a residentially zoned property, and no greater than one Story when located less than fifty (50) feet from residentially zoned property. A mechanical room and/or a non-habitable storage room shall be allowed in the Attic. A mezzanine or loft shall be considered a Story.
- (4) Heating, ventilation and air conditioning equipment, duct work, air compressors, and other fixed operating machinery shall be either screened from view with Fencing or vegetation, or located so that such items are not visible from any Overlay District Delineated Roadway, adjacent residential properties or intersecting Streets. Trash receptacles, dumpsters, utility meters, above-ground tanks, satellite dishes, Antennae, and other such Structures shall be similarly treated.
- (5) Satellite dishes shall be subject to Section VIII.J of these Regulations.
- (6) No temporary Structures shall be permitted, except for those used in conjunction with construction projects and special community events, and for which, applicable permits have been obtained. Office type mobile units when used as such temporary facilities shall be equipped with rigid skirting on all sides. Any towing gear shall be removed, and if not removable, shall be screened with landscaping.
- (7) Chain link, barbed wire and similar Fencing shall not be permitted in any required Front Yard, and where such Fencing can be viewed from any roadway. Landscaping and/or berm shall be provided to prohibit visibility from any Overlay District Delineated Roadway.
- (8) Exterior lighting for safety and security shall be kept to a minimum consistent with reasonable safety requirements of the particular business or Structure. Safety and security lights, other than low-wattage lights or ground-area lights, shall not be visible from adjacent residential properties.
- (9) The maximum amount of impervious surface coverage of any site proposed for development, excluding any jurisdictional wetlands and pervious parking areas, shall not exceed sixty-five (65) percent.
- (10) Commercial uses shall have a maximum Gross Floor Area (GFA) of ten thousand (10,000) square feet per acre, excluding any jurisdictional wetlands.
- (11) The maximum length of Buildings parallel, or within 45 degrees of parallel to any Overlay District Delineated Roadway shall be one hundred twenty (120) feet.

PVZDR Section Q.5.d Architectural Design Standards

The pleasing and compatible relationship of architecture along Roads in the Overlay District is of important public concern. The architectural design of Structures and their materials and colors must be visually harmonious with the overall appearance, history and cultural heritage of Ponte Vedra, and also with natural Land forms and existing vegetation. Compatibility with existing adjacent Structures and other approved development plans must also be considered.

The intent of these standards is not to restrain diversity or innovative architecture, but to reduce incompatible and adverse impacts, and to insure an aesthetically pleasing environment. To accomplish this, the following standards shall apply to the review of proposed Buildings, renovations and related site improvements.

- (1) Proposed development shall be located and configured in a visually complementary manner with the existing terrain and vegetation of the parcel and surrounding parcels. Structures shall obstruct as little as reasonably practical scenic views from the main Road or from existing Structures and the natural environment. Structures shall not dominate, in an incompatible manner, any general development or adjacent Building which is substantially in compliance with this Ordinance. This may be accomplished by the use of architectural features and/or siting of proposed Structures to reduce the appearance of excessive and inappropriate height or mass of proposed Structures.

- (2) The proposed Building or Structure shall be of such design that is contributes to the image of the Ponte Vedra Coastal Corridor as a place of beauty, spaciousness and high quality.
- (3) The proposed Building or Structure shall not, in its exterior design and appearance, be of inferior quality such as to cause the nature of the local environment to materially depreciate in appearance or value.
- (4) Where a single Building, or group of related Buildings contains more than one (1) store or business front, all Wall Signs shall be of similar style and shall be compatible and uniform in terms of size, color and any lighting. Any back-lighting or appearance of lighting shall be white in color.
- (5) The color and materials of Signs shall be compatible with the architectural style, color and materials of the related commercial or multi-Family Building.
- (6) New Ground Signs and alterations to existing Ground Signs requiring an ARC review shall be externally illuminated

PVZDR Section Q.5.e Design Elements and Materials

The following specific design criteria shall apply to development regulated under the conditions of the Overlay District.

- (1) Flat roofs, or the appearance of flat roofs, shall not be permitted. Pitched roofs, or the appearance of pitched roofs are required.
- (2) Long monotonous façade designs including, but not limited to, those characterized by unrelieved repetition of shape or form or design elements, or by unbroken extension of line shall be avoided.
- (3) Architectural grade shingles, metal standing seam, tile or other non-reflective roof materials with similar nature-blending texture and appearance shall be considered appropriate.
- (4) Stucco, tabby, wood siding or wood shingle siding, brick or other materials with similar texture and appearance shall be considered appropriate.
- (5) Exterior colors of paints and stains shall be Earth Tones with no more than three colors per Building, excluding roof color. Semi-transparent stains are recommended for application on natural wood finishes. All exterior color hues shall be subdued, consistent and compatible with those on existing adjacent properties as well as those throughout the Ponte Vedra Coastal Corridor.
- (6) Roof and exterior Wall surfaces, with the exception of glass doors and windows shall be non-reflective. Any glass coating shall not reflect outward and shall be limited in color to gray or green. No more than forty (40) percent of the façade facing an Overlay District Delineated Roadway shall be glass or reflective material.
- (7) The location and dimensions of Wall Signs shall maintain compatibility with architectural materials, finishes and features of the Building. Wall signs shall be directly mounted on the surface of the building and shall not be mounted on raceways or other such protrusions from the surface of the building.
- (8) The Architectural Review Committee may require utilization of particular landscape and plant species where a pattern of vegetation has been established or where such species are determined to be desirable.
- (9) Architectural lighting shall be recessed under roof overhangs or generated from a concealed light source or low-level light fixtures. Site lighting shall be of low intensity, shall be of white light which does not distort colors and shall not spill over into adjoining properties, roadways or in any way interfere with the vision of oncoming motorists.

Staff review shows there are no open comments on this application at the time of writing this staff report. A Pre-application Meeting was not held with the Planning Division.

Attached for consideration are:

- Application
- Owners Authorization
- Site Plan
- Applicant Presentation with Renderings/Colors, Lighting, Landscaping, and Materials Details

CORRESPONDENCE

Staff has not received any phone calls or letters regarding the proposal as of the writing of this Staff Report.

SUGGESTED ACTION TO APPROVE

The Architectural Review Committee may consider a motion to approve **ARC 2024-04 Golf Club Patio Renovation (Ponte Vedra Inn & Club)**, as described within the application, provided:

1. The request complies with the Ponte Vedra Zoning District Regulations relating to design standards and is consistent with the intent and purpose of the Ponte Vedra Zoning and Overlay Regulations.

SUGGESTED ACTION TO DENY

The Architectural Review Committee may consider a motion to deny **ARC 2024-04 Golf Club Patio Renovation (Ponte Vedra Inn & Club)**, provided:

1. The request does not comply with the Ponte Vedra Zoning District Regulations of the Ponte Vedra Zoning and Overlay Regulations.



Application for Overlay District Review
 Growth Management Department
 Planning and Zoning Division
 4040 Lewis Speedway, St. Augustine, FL 32084
 Phone: (904) 209-0675; Fax: (904) 209-0576

Date **02.28.2024** Overlay District **Ponte Vedra Overlay District** Property ID No (Strap) **0509100000**

Applicant **Ponte Vedra Corp / Ponte Vedra Inn** Phone Number **904.273.7798**

Address **200 Ponte Vedra Blvd** Fax Number

City **Ponte Vedra Beach** State **FL** Zip Code **32082** E-mail **mgordon@pvresorts.com**

Project Name **Ponte Vedra Inn and Club, Golf Club Patio Renovation**

Project Address & Location **#35 Pablo Road, Ponte Vedra Beach, FL, Section 15, Township 3 South, Range 29 East**

Type of Review Commercial Use Multi-family Use Other: **Private Golf Club**
Check all that apply

The Project Involves New Building Changes to an existing Building Exterior Repainting Signage (Individual)
Check all that apply
 Unified Sign Plan Fences / Walls Parking / Lighting Landscaping / Buffers
 Other: **Outdoor fireplace and hardscape renovations**

Describe Project and work proposed to be done (Provide additional information by attachment as needed)

- Removal of existing outdoor, concrete patio (approx. 660 sf) and pergola structure with associated columns. Removal of a portion of existing wood deck (approx. 80 sf). Removal of existing landscape and irrigation.
 - Installation of approx. 1200 sf of concrete pavers and other impervious surfaces (approx. 540 sf new impervious surface). Construction of outdoor fireplace. Structure is approx 4.5' deep x 8.5' wide x 10.5' height constructed of CMU and painted brick. Repair and/or renovations to existing wood deck where the existing deck is removed or damaged due to construction activity. Landscape and irrigation installation. Install 1 new exterior door to clubhouse, exiting to renovated patio.

I HEREBY CERTIFY THAT ALL INFORMATION IS CORRECT:
 Signature of owner or person authorized to represent this application:

Signed By

Printed or typed name(s) **Mark Klone, PLA, ASLA**

Contact Information of person to receive all correspondence if different than applicant:

Phone Number **904.296.8066** Fax Number E-mail **mklone@elmpln.com**

Postal Address **1301 Riverplace Blvd, Suite 1818** Name **ELM - Mark Klone, PLA, ASLA**

City **Jacksonville** State **FL** Zip Code **32207**

Please notify the Planning and Zoning Division at (904) 209-0675 if you need any special assistance or accommodations to attend the meeting or if you have any questions concerning this application.

Please list any applications currently under review or recently approved which may assist in the review of this application including the name of the PUD/PRD: **Ponte Vedra Resort PUD - PUD2023000002**



Owner's Authorization Form

ELM - Mark Klone, PLA, ASLA

is hereby authorized TO ACT ON BEHALF OF

Ponte Vedra Corp / Ponte Vedra Inn

the owners(s) of those lands described within

the attached application, and as described in the attached deed or other such proof of ownership as may be required, in applying to St. Johns County, Florida, for an application related to a development Permit or other action pursuant to a: application for:

Ponte Vedra Inn and Club, Golf Club Patio Renovation

By signing, I affirm that all legal owners(s), as listed on the Recorded Warranty Deed on file with the St. Johns County Clerk of Courts or otherwise stated (_____), have been notified of the _____

(Identify what document)

I further understand incomplete or false information provided on this form may lead to revocation of permits, termination of development activity.

Signature of Owner

[Handwritten Signature]

Print Name

Michael Gordon VP

Signature of Owner

Print Name


Telephone Number

904-285-1111

STATE OF FLORIDA

COUNTY OF St. Johns

The foregoing instrument was acknowledged before me by means of [X] physical presence or [] online notarization, this 11th day of March, 2024, by Michael Gordon as V.P. General Manager for Ponte Vedra Club/Ponte Vedra Inn.

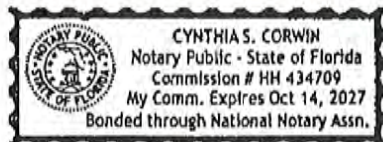

[Handwritten Signature]
Notary Public, State of Florida
Name: Cynthia S. Corwin
My Commission Expires:
My Commission Number is:

Personally Known [X] OR Produced Identification _____

Type of Identification Produced _____

GOLF CLUB PATIO RENOVATION

PONTE VEDRA BEACH, FL
CONSTRUCTION DOCUMENTS




planning
architecture
landscape architecture
urban design
visual communication

Jacksonville
ELM Studio
1301 Riverplace Boulevard
Suite 1818
Jacksonville, FL 32207
t 904.296.8066

elmpln.com


AA26000004 - LC26000209

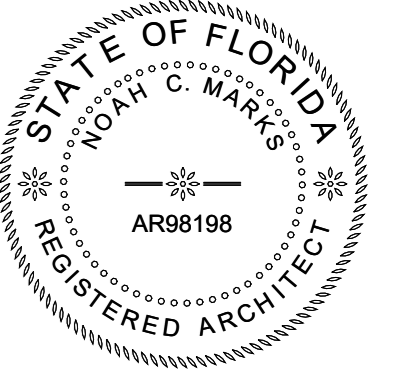

NOAH C. MARKS
AR98198

PONTE VEDRA INN & CLUB
 GOLF CLUB PATIO RENOVATION
 PONTE VEDRA BEACH, FL

VICINITY MAP

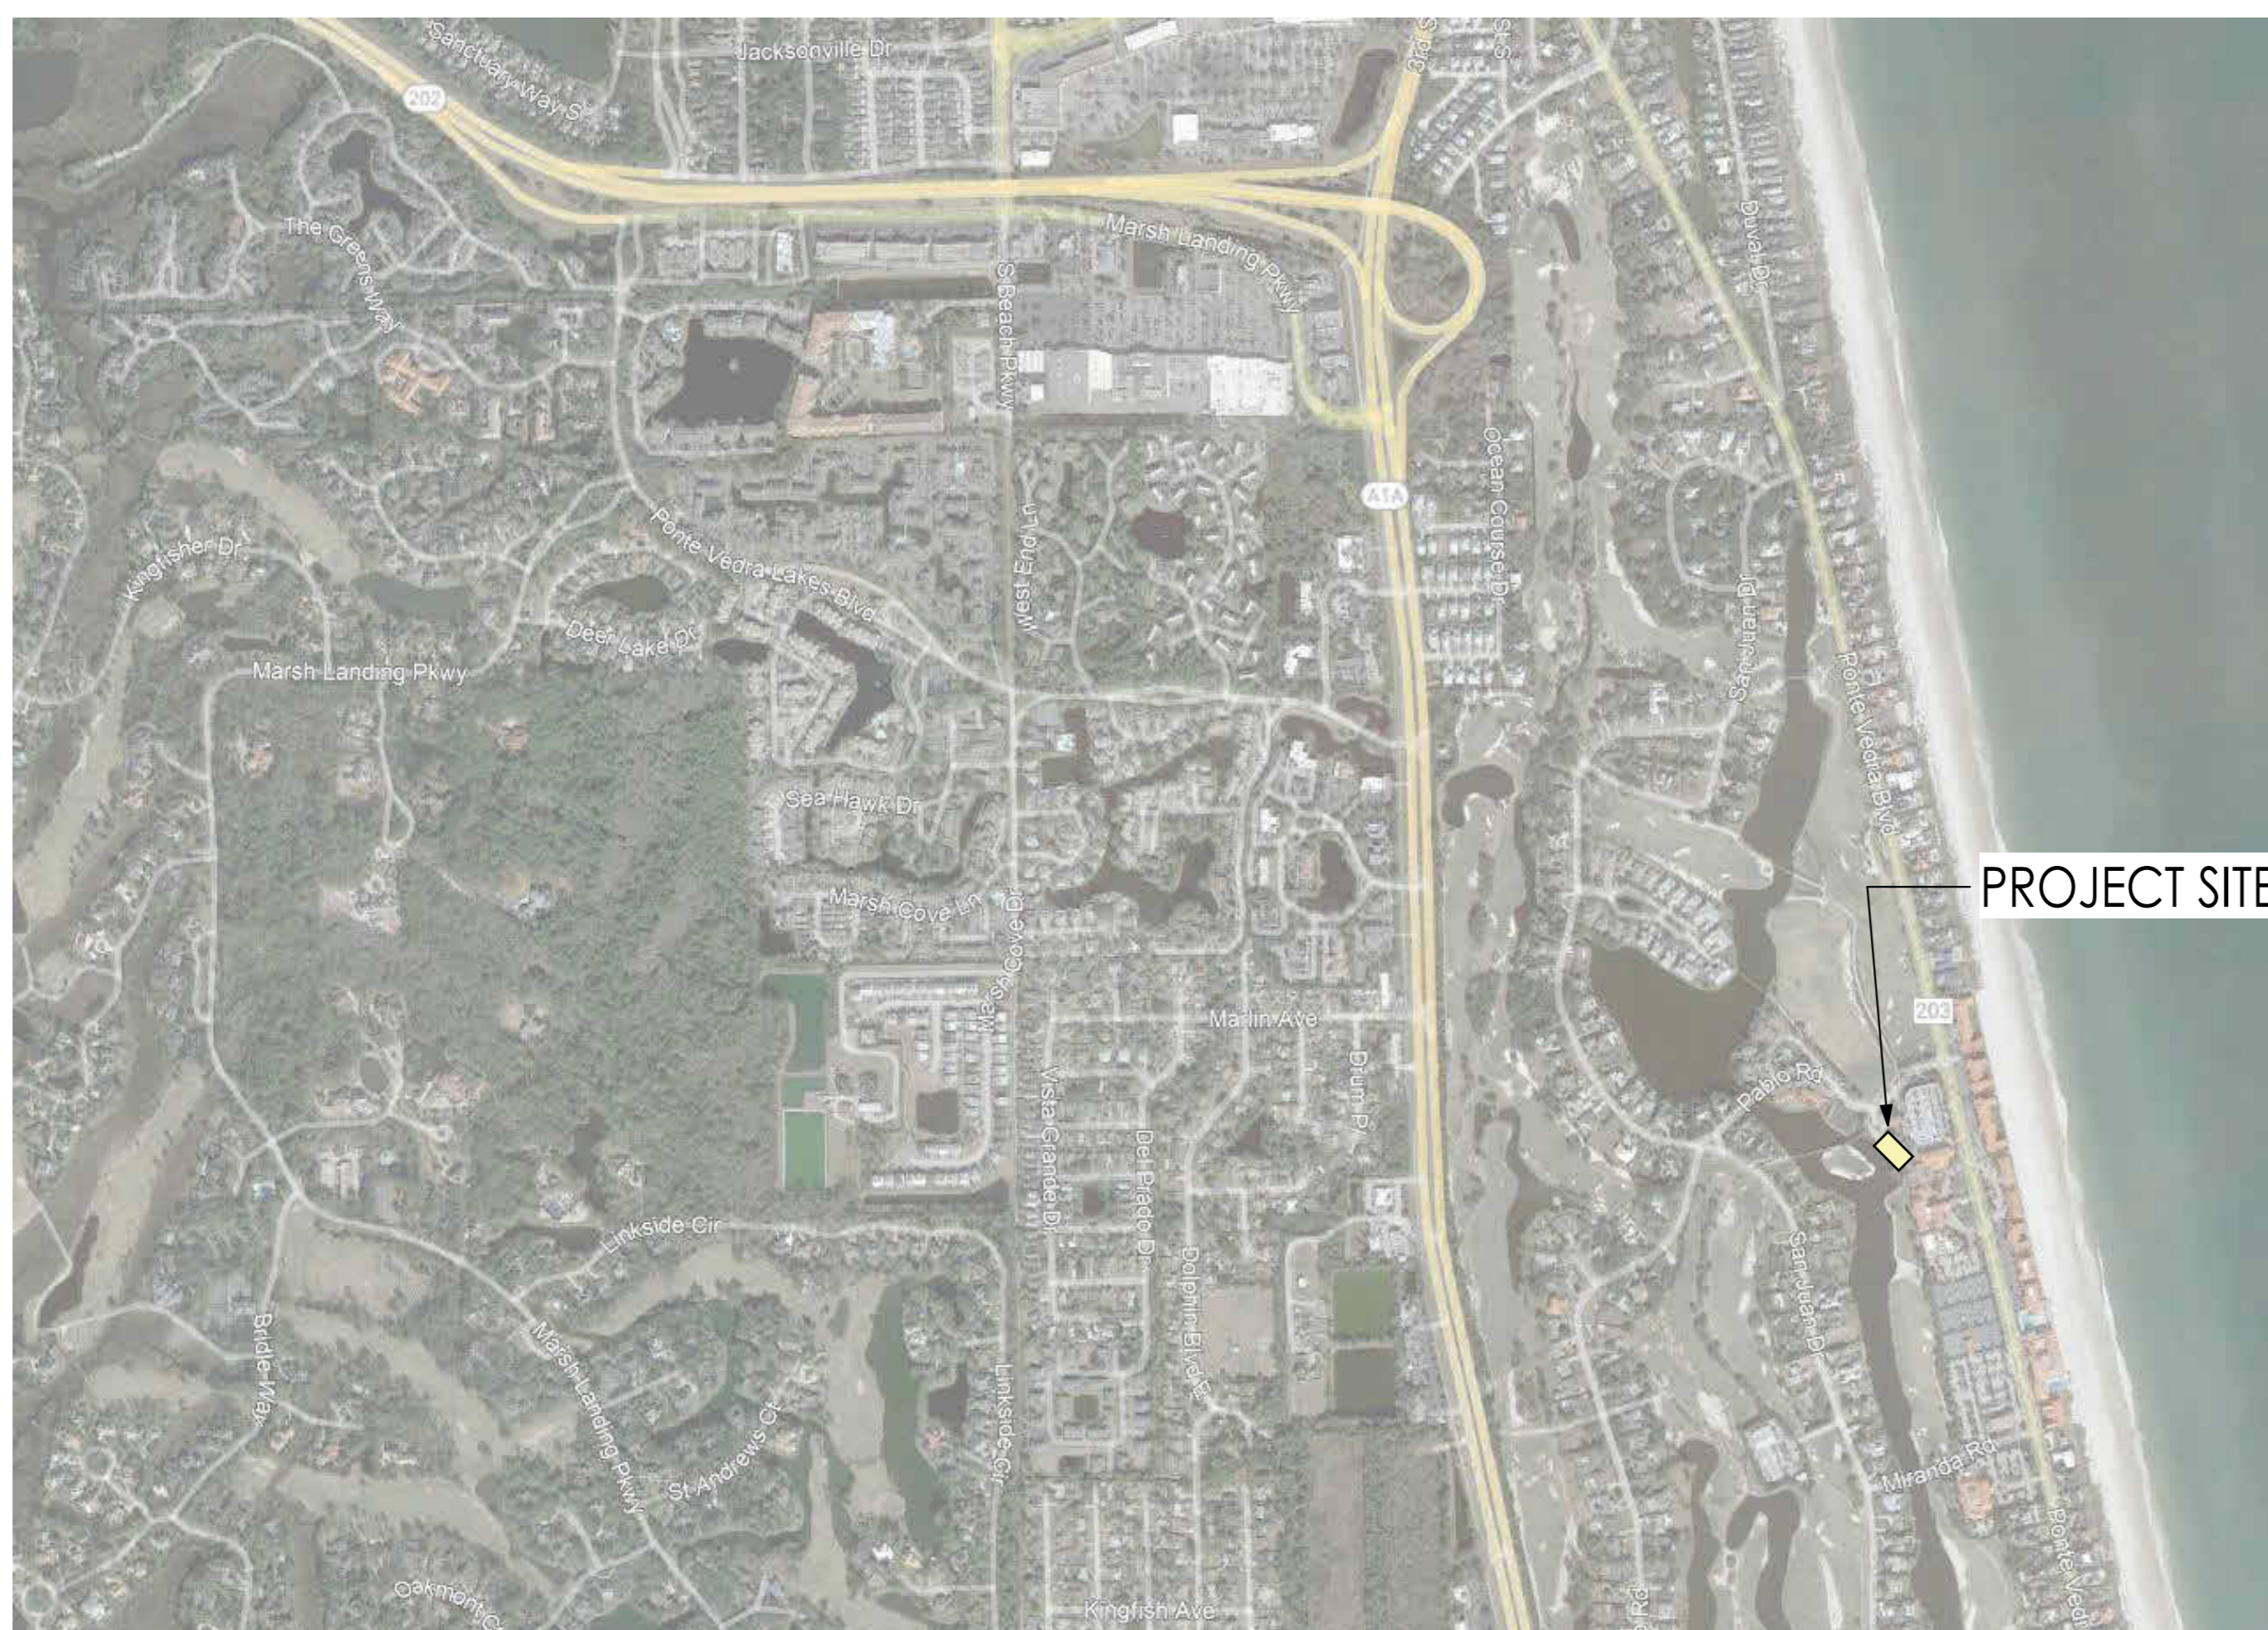

PROJECT TEAM

ARCHITECTS, LANDSCAPE ARCHITECTS
ERVIN LOVETT & MILLER
 1035 KINGS AVENUE
 JACKSONVILLE, FLORIDA 32207
 904.296.8066

STRUCTURAL ENGINEERING
KIESTER WEBB STRUCTURAL ENGINEERS LLC
 6501 ARLINGTON EXPRESSWAY
 BLDG B, SUITE 156
 JACKSONVILLE, FLORIDA 32211
 904.619.2333

ELECTRICAL, PLUMBING ENGINEERING
POWELL & HINKLE ENG.
 1409 KINGSLEY AVE # 12A,
 ORANGE PARK, FL 32073
 904.264.5570

OWNER
PONTE VEDRA LODGE, INC.
 9540 SAN JOSE BLVD.
 JACKSONVILLE, FL 32257
 904-737-7220

DRAWING INDEX

SHEET	NAME
GENERAL	
G000	COVER
G100	CODE INFO, ABBREY., SYMBOLS, NOTES
G101	LIFE SAFETY PLAN
LANDSCAPE	
L001	GENERAL NOTES & SPECIFICATIONS
L101	SITE LAYOUT & GRADING PLANS
L401	HARDSCAPE DETAILS
L402	HARDSCAPE DETAILS
L403	HARDSCAPE DETAILS
L501	LANDSCAPE PLANS, PLANT SCHEDULE, & NOTES
L601	LANDSCAPE SPECIFICATIONS
L602	LANDSCAPE SPECIFICATIONS
L603	LANDSCAPE SPECIFICATIONS
L604	LANDSCAPE SPECIFICATIONS
ARCHITECTURAL	
A100	SITE PLAN
A101	DEMOL & NEW PLAN
A102	DETAILS
PLUMBING	
P101	PLUMBING SITE PLAN
P201	LEGEND, SCHEDULE & MISC. DETAILS
ELECTRICAL	
E101	PART SITE PLAN - ELECTRICAL LEGEND & NOTES
E102	POWER RISER PANEL SCH. SPECIFICATIONS AND DETAILS

GENERAL NOTES

1. THE CONTRACTOR SHALL VISIT THE SITE, COMPARE THE DRAWINGS AND SPECIFICATIONS AND INFORM THEMSELVES OF ALL CONDITIONS IN ORDER TO COMPLETE THE PROJECT IN ACCORDANCE WITH THE INTENT OF THE CONTRACT DOCUMENTS.
2. THE CONTRACTOR SHALL FIELD VERIFY ALL EXISTING CONDITIONS AND DIMENSIONS. THE CONTRACTOR SHALL NOTIFY THE PROJECT COORDINATOR OF ANY DISCREPANCIES PRIOR TO CONSTRUCTION AND FABRICATION. CONTRACTOR TO VERIFY ALL SIZES TYPES AND QUANTITIES.
3. ALL DIMENSIONS SHOWN ARE SUBJECT TO VERIFICATION IN THE FIELD BY THE CONTRACTOR, AND THEY SHALL MAKE ALL CORRECTIONS AND ADJUSTMENTS AS REQUIRED PRIOR TO ORDERING, FABRICATION AND/OR INSTALLATION.
4. ALL WORK SHALL CONFORM TO THE CURRENT APPLICABLE BUILDING CODES.
5. THE CONTRACTOR SHALL PROTECT FROM DAMAGE EXISTING SITE AND BUILDING ADJACENT TO AREAS OF IMPROVEMENT. IF DAMAGE OCCURS, RESTORE TO ORIGINAL CONDITION AT NO COST TO THE OWNER. THE CONTRACTOR IS ALSO RESPONSIBLE TO RESTORE THE CONDITIONS, REPLACE ANY DISRUPTED IRRIGATION LINES & SPRINKLER HEADS, REPLACE AND/OR REPAIR DAMAGED CONCRETE WALKWAYS.
6. THE CONTRACTOR SHALL BE RESPONSIBLE FOR MAINTAINING THE BUILDING AND SITE CLEANING, AND PROVIDE ANY AND ALL SAFETY PROVISIONS TO ENSURE CURRENT EMPLOYEES AND PUBLIC SAFETY DURING THE CONSTRUCTION PERIOD OF THIS PROJECT.
7. ALL MATERIALS FURNISHED BY THE CONTRACTOR SHALL BE NEW AND FREE FROM DEFECTS.
8. EXCEPT FOR MATERIAL TO BE TURNED OVER TO THE OWNER, THE CONTRACTOR SHALL REMOVE AND DISPOSE OF ALL DEBRIS, RUBBISH, AND OTHER MATERIAL RESULTING FROM DEMOLITION OPERATIONS. DISPOSAL WILL BE IN ACCORDANCE WITH ALL LOCAL, STATE AND/OR FEDERAL REGULATIONS GOVERNING SUCH OPERATIONS.
9. CONTRACTOR SHALL COMPARE ALL CONTRACT DOCUMENTS WITH EACH OTHER AND REPORT IN WRITING TO THE PROJECT COORDINATOR ALL INCONSISTENCIES AND OMISSIONS. IN CASE OF CONFLICTS BETWEEN THE QUANTITY OF MATERIAL SCHEDULED ON THE DRAWINGS, CONTRACTOR SHALL PROVIDE GREATER QUANTITY REQUIRED.
10. THE CONTRACTOR SHALL BE RESPONSIBLE FOR COORDINATING ALL WORK OF ALL TRADES REQUIRED FOR PROJECT COMPLETION AND CONFORMANCE.
11. THE CONTRACTOR SHALL BE RESPONSIBLE FOR METHODS OF CONSTRUCTION, WORKMANSHIP, AND JOB SAFETY. THE CONTRACTOR SHALL PROVIDE TEMPORARY SHORING AND BRACING AS REQUIRED FOR THE STABILITY OF STRUCTURAL MEMBERS AND SYSTEMS.
12. THE CONTRACTOR SHALL CLEAN AND PREPARE ALL NEW AND EXISTING SURFACES AS REQUIRED TO RECEIVE NEW WORK OR AS OTHERWISE REQUIRED FOR A NEAT AND FINISHED APPEARANCE.
13. CONTRACTOR SHALL PATCH, SMOOTH, AND FINISH TO MATCH ADJACENT SURFACES DAMAGED FROM REMOVAL OR DEMOLITION WORK. AREAS, SUCH AS WALLS FOR PLUMBING AND ELECTRICAL WORK, THAT ARE REQUIRED TO BE REMOVED AND/OR DEMOLISHED TO PERFORM THE WORK INDICATED IN THE DRAWINGS AND SPECIFICATIONS AND SHALL BE REPAIRED AND/OR REPLACED TO MATCH EXISTING CONDITIONS.
14. IF ANY MATERIALS EXISTING TO REMAIN WITHIN THE SCOPE OF WORK ARE DAMAGED DURING DEMOLITION OR DURING CONSTRUCTION, THE CONTRACTOR SHALL REPLACE THE TRIM, FINISHES OR SUBSTRATES WITH NEW TO MATCH EXISTING.
15. THE GENERAL CONTRACTOR IS RESPONSIBLE TO COORDINATE WITH THE OWNER AND PROJECT COORDINATOR FOR DISCONNECTION, RECONNECTING, AND REINSTALLATION OF THE EXISTING ELECTRICAL SYSTEMS REQUIRED TO COMPLETE THE WORK. ASSURE CONTINUITY OF ALL ELECTRICAL SERVICES, INCLUDING COMMUNICATIONS AND SECURITY SYSTEMS TO PARTS OF THE FACILITY TO REMAIN IN SERVICE.
16. BEFORE ANY SERVICE IS DISCONNECTED OR INTERRUPTED, THE CONTRACTOR SHALL VERIFY USAGE AND ASSURE THAT REQUIRED SERVICES ARE NOT DISCONNECTED OR INTERRUPTED. ANY REQUIRED SERVICE DISCONNECTED OR INTERRUPTED SHALL BE RESTORED IMMEDIATELY BY THE CONTRACTOR AT NO ADDITIONAL COST TO THE OWNER.
17. PAINT FINISH ALL EXPOSED EXISTING MATERIAL AFFECTED BY THE WORK AND ALL NEW WORK. CONTRACTOR SHALL SEAL ALL PENETRATIONS AROUND NEW AND EXISTING CONDUITS, ALL PENETRATIONS AND CUT OPENINGS THROUGH WALLS PRIOR TO PAINTING WORK.

REVISION DATES

NO.	DESCRIPTION	DATE


THIS DRAWING IS AN INSTRUMENT OF SERVICE AND THE PROPERTY OF ELM, INC. AND SHALL REMAIN THEIR PROPERTY. THE USE OF THIS DRAWING SHALL BE RESTRICTED TO THE ORIGINAL SITE FOR WHICH IT IS PREPARED, AND PUBLICATION THEREOF IS EXPRESSLY LIMITED TO SUCH USE.

PROJ. #: 22-44
 DATE: 12.22.2023
 DRAWN BY: AIW
 CHECKED BY:
 SCALE: AS NOTED


COVER

SHEET NUMBER
G000
 CONSTRUCTION DOCUMENTS

12/13/2023 1:37:29 PM

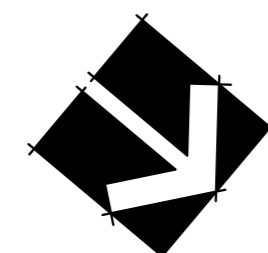

LIFE SAFETY PLAN - EXISTING GOLF CLUB
1/8" = 1'-0"

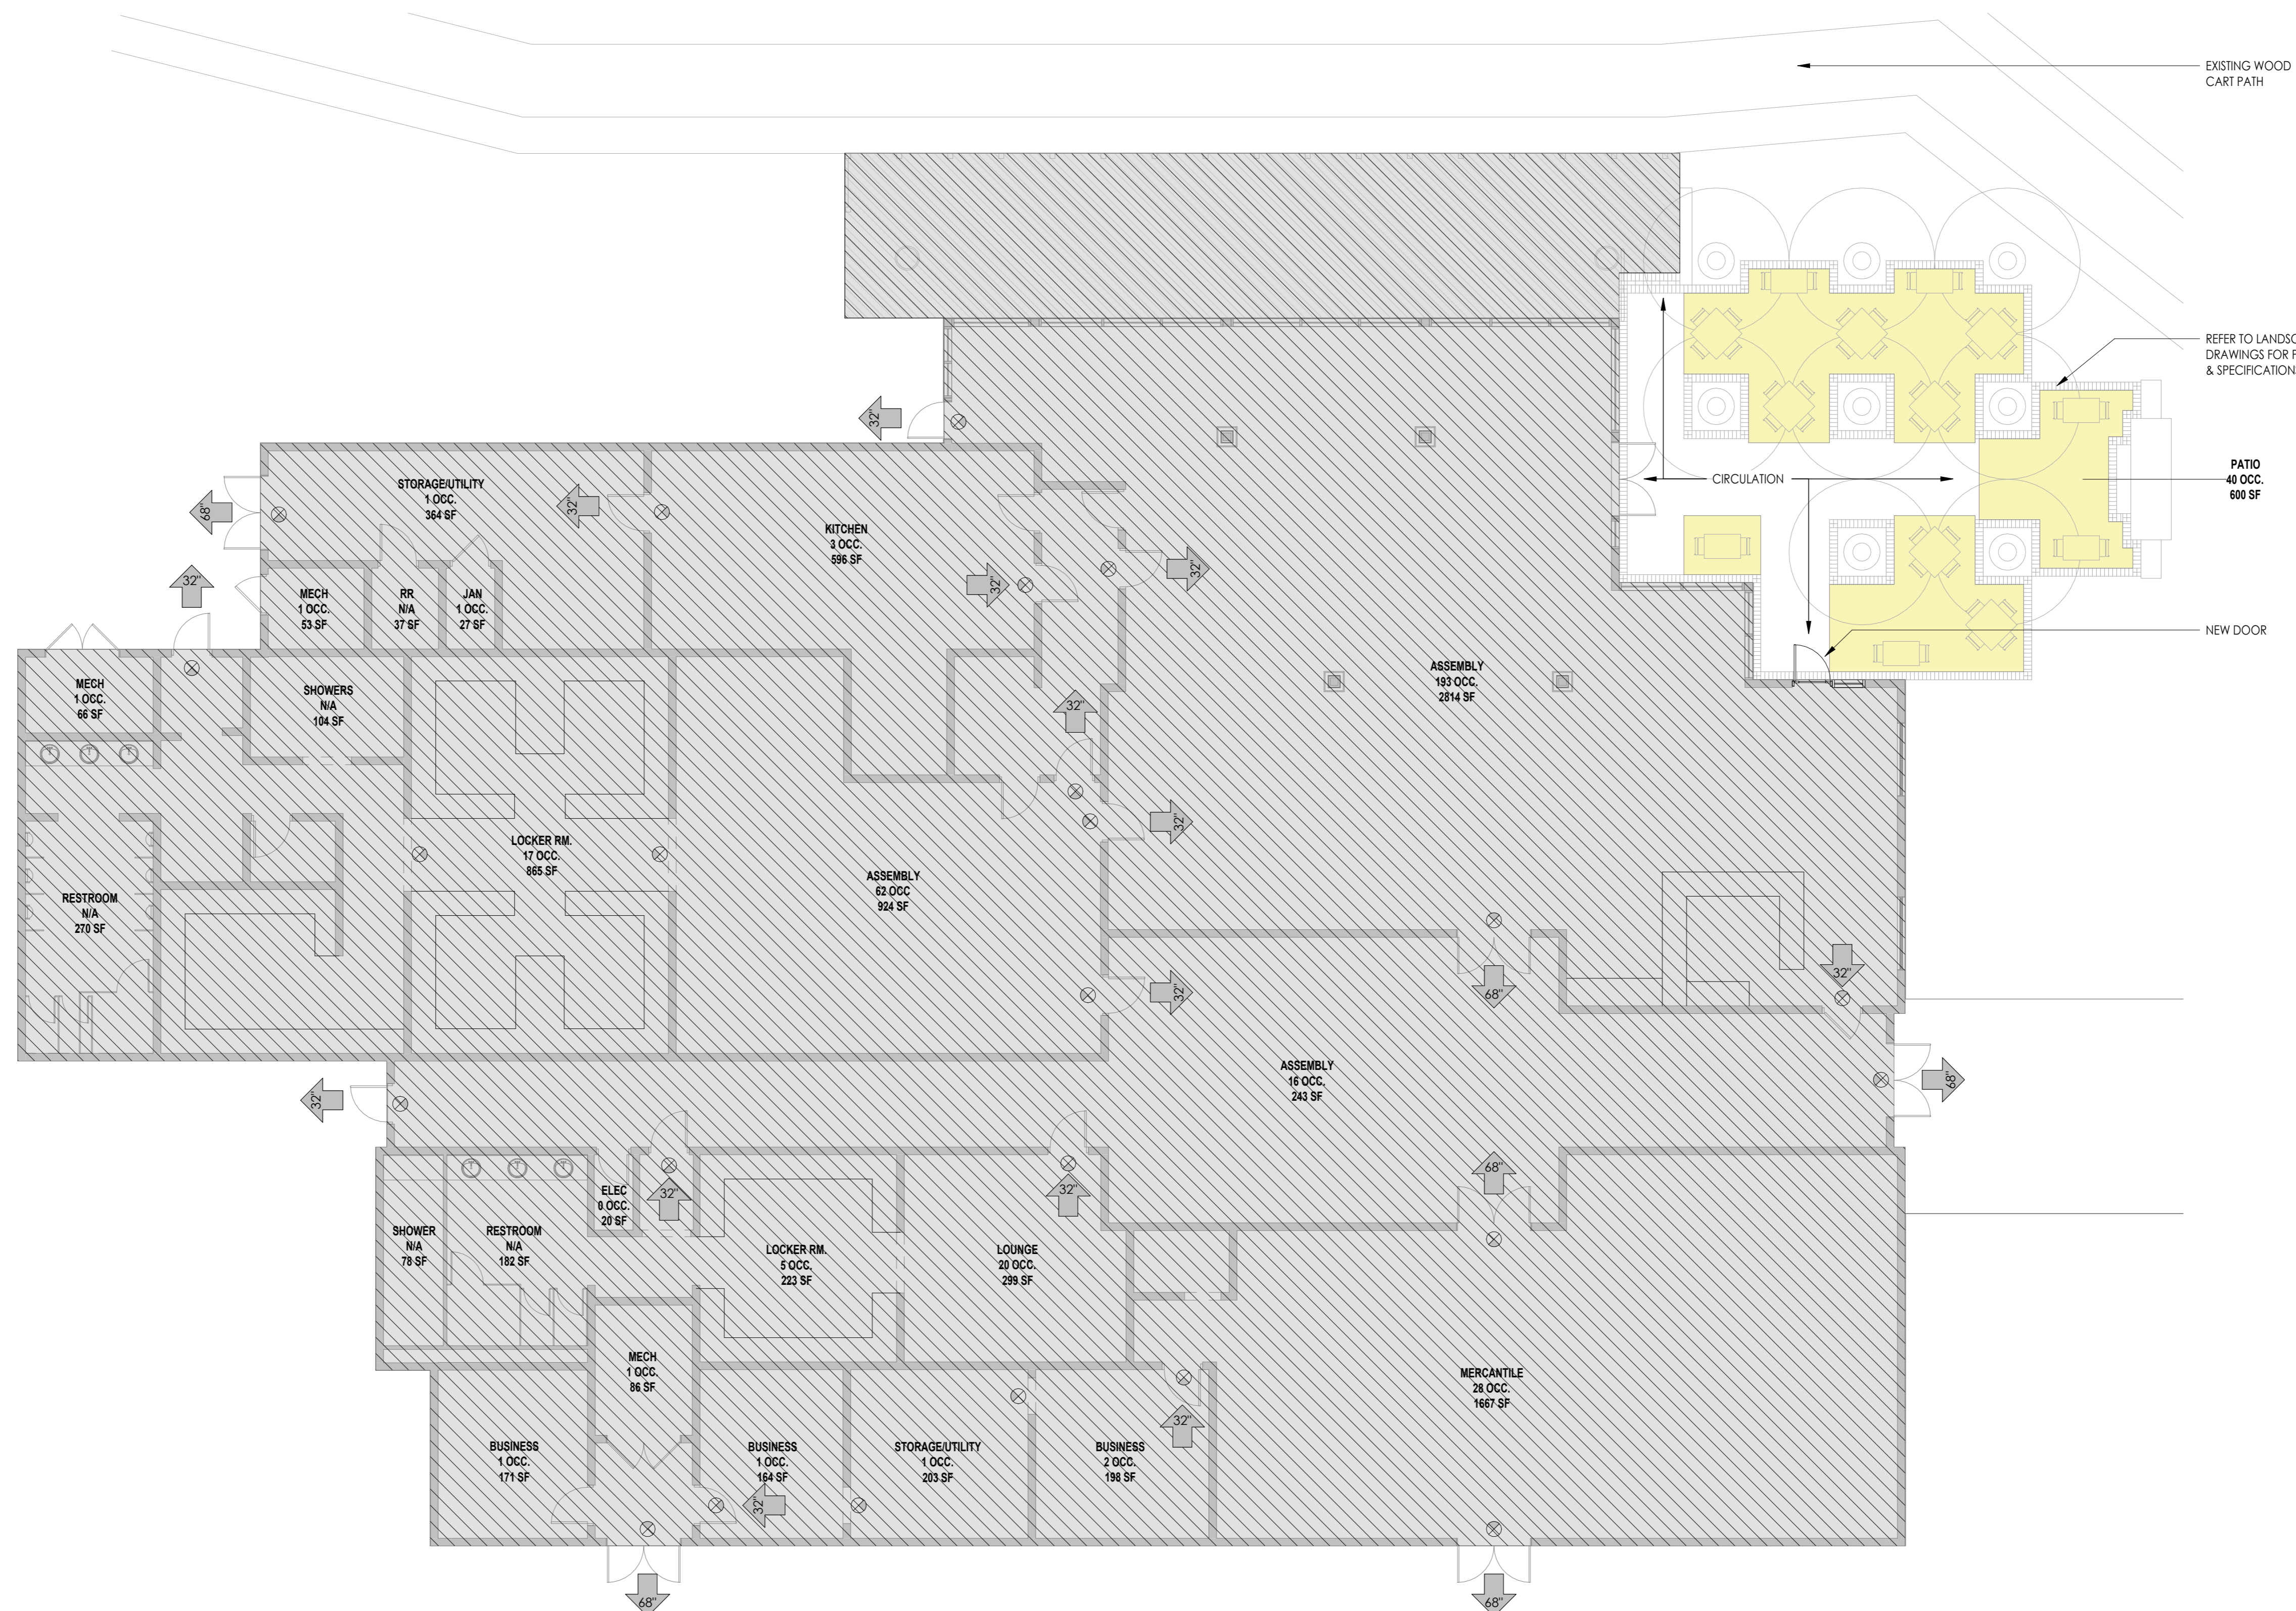

OCCUPANCY TYPE	AREA	OCCUPANCY LOAD FACTOR	OCCUPANCY LOAD
ASSEMBLY	2814 SF	15	193 OCC.
ASSEMBLY	924 SF	15	62 OCC.
ASSEMBLY	243 SF	15	16 OCC.
BUSINESS	171 SF	150	1 OCC.
BUSINESS	184 SF	150	1 OCC.
BUSINESS	178 SF	150	2 OCC.
ELEC	20 SF	300	0 OCC.
JAN	27 SF	300	1 OCC.
KITCHEN	596 SF	200	3 OCC.
LOCKER RM.	223 SF	50	5 OCC.
LOCKER RM.	865 SF	50	17 OCC.
LOUNGE	299 SF	15	20 OCC.
MECH	53 SF	300	1 OCC.
MECH	66 SF	300	1 OCC.
MECH	86 SF	300	1 OCC.
MERCANTILE	1667 SF	60	28 OCC.
PATIO	600 SF	15	40 OCC.
RESTROOM	270 SF		N/A
RESTROOM	182 SF		N/A
RR	37 SF		N/A
SHOWER	78 SF		N/A
SHOWERS	104 SF		N/A
STORAGE/UTILITY	203 SF	300	1 OCC.
STORAGE/UTILITY	344 SF	300	1 OCC.
INTERIOR OCCUPANT LOAD			354
EXTERIOR OCCUPANT LOAD			40
TOTAL OCCUPANT LOAD			394

LIFE SAFETY PLAN LEGEND

- REQUIRED EGRESS AND EXIT WIDTH
- REQUIRED ACCESSIBLE PUBLIC ENTRANCE
- FIRE EXTINGUISHER
- FIRE EXTINGUISHER CABINET
- EXIT SIGN
- EXIT SIGN w/ DIRECTION
- EXIT SIGN w/ EMERGENCY LIGHTS
- TACTILE EXIT SIGN
- FIRE DEPT. BUILDING ACCESS BOX
- EMERGENCY EXIT LIGHT
- STARTING LOCATION
- MAX. TRAVEL DISTANCE
- COMMON TRAVEL DISTANCE
- FIRE EXTINGUISHER TRAVEL DISTANCE

LIFE SAFETY GENERAL NOTES


- ALL DOOR HARDWARE N.I.S. EXISTING TO REMAIN. NEW DOOR HARDWARE INCLUDING CLOSER, HANDLES, PULLS, LATCHES, LOCKS, THRESHOLDS TO BE ADA COMPLIANT.
- EXISTING PORTABLE FIRE EXTINGUISHERS ARE EXISTING TO REMAIN.
- PROVIDE TACTILE EXIT SIGNAGE EXISTING TO REMAIN.
- PROVIDE EMERGENCY LIGHTING EXISTING TO REMAIN.
- EXIT DISCHARGE AT 3'-0" DOOR IS RECOGNIZED AS 3'-0" CLEAR w/ 1/2" MIN. THRESHOLD.
- EXIT DISCHARGE AT 6'-0" DOOR IS RECOGNIZED AS 6'-0" CLEAR w/ 1/2" MIN. THRESHOLD.
- MAIN EXIT DOORS AT FRONT EXIT TO DEDICATED PATH OF TRAVEL/ACCESSIBLE ROUTE TO PUBLIC TRANSPORTATION STOPS, ACCESSIBLE PARKING, AND PASSENGER LOADING ZONES. EXISTING TO REMAIN.



planning
architecture
landscape architecture
urban design
visual communication

Jacksonville
ELM Studio
1301 Riverplace Boulevard
Suite 1818
Jacksonville, FL 32207
t 904.296.8066

elmpln.com

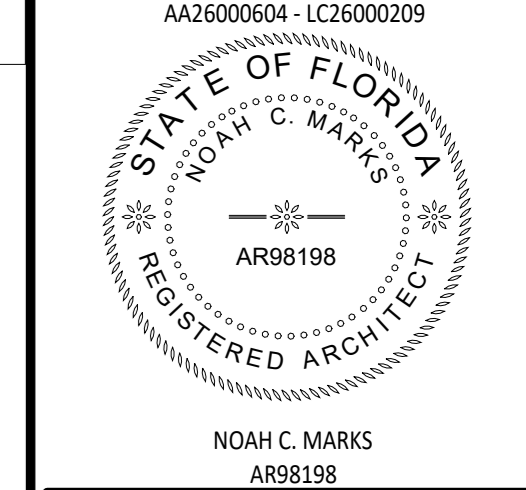

GOLF CLUB PATIO RENOVATION
PONTE VEDRA INN & CLUB
PONTE VEDRA BEACH, FL

ISSUE DATES		
NO.	DESCRIPTION	DATE

THIS DRAWING IS AN INSTRUMENT OF SERVICE AND THE PROPERTY OF ELM, INC. AND SHALL REMAIN THEIR PROPERTY. THE USE OF THIS DRAWING SHALL BE RESTRICTED TO THE ORIGINAL SITE FOR WHICH IT IS PREPARED, AND PUBLICATION THEREOF IS EXPRESSLY LIMITED TO SUCH USE.

PROJ. #: 22-44
DATE: 12.22.2023
DRAWN BY: AJW
CHECKED BY:
SCALE: AS NOTED

LIFE SAFETY PLAN
SHEET NUMBER
G101
CONSTRUCTION DOCUMENTS

DESIGN CRITERIA

Design per 2023 Florida Building Code 8th Edition, unless otherwise noted

Wind loads: Wind Exposure Category C
Wind speed: (130 mph)

Concrete (Design per current edition ACI 318)
Compressive strength: $f_c = 3000 \text{ psi}$

All reinforcing steel ASTM A615 Grade 60

All welded wire fabric ASTM A185

Concrete masonry (Design per current edition ACI 530)
Compressive strength: $f_m = 1500 \text{ PSI}$

Soil bearing (design maximum): 2000 psf (assumed)

40, 14 Deformed bar reinforcement shall conform to ASTM A615, Grade 60. Provide bar spacers as required to properly locate reinforcing. Lap splices shall be as follows:

	8" CMU		Doubly Reinforced	
	Singly Reinforced	f _m 1500	f _m 1500	f _m 2000
#3 (#10)	19	16	19	16
#4 (#13)	25	21	26	24
#5 (#16)	31	27	43	37
#6 (#19)	52	45	87	75

All load bearing walls and exterior walls shall be composed of ASTM C90, Type II Hollow Concrete Masonry Units with ASTM C270 Type "S" mortar. Grout shall conform to the requirements of ASTM C476 and have a compressive strength of 3000 psi.

Masonry work shall be inspected in accordance with ACI 530.1.

If footing elevations shown occur in a disturbed, unstable, or unsuitable soil, the architect shall be notified.


Concrete work shall conform to the requirements of ACI 301, "Specifications for Structural Concrete for Buildings" (latest edition), except as modified by the requirements of the contract documents.

Masonry construction and materials shall conform to the requirements of "Specifications for Masonry Structures (ACI 530.1) ASCE 6" (latest edition), except as modified by requirements of the contract documents.

GENERAL NOTES

- Contractor is responsible for reviewing site conditions prior to bidding and construction. Any discrepancies between these plans and actual site conditions shall be brought to the immediate attention of the Owner's Engineer and Landscape Architect prior to final bid and/or construction.
- Contractor is responsible for a thorough understanding of all engineering and hardscape design drawings. Discrepancies between these drawings shall be immediately identified and brought to the attention of the Owner's Engineer and Landscape Architect prior to final bid and/or construction.
- The extent of the contractor's work is as indicated in the plans and details. The contractor is responsible to understand the extent of work described herein. Discrepancies in the defined work limits in these drawings shall be brought to the immediate attention of the Owner or Owner's Representative. Any misunderstandings regarding the extent of work are fully the responsibility of the contractor.
- In these drawings written dimensions shall take precedence over scaled dimensions. The contractor shall verify and be responsible for all dimensions and conditions on the job. ELM, Inc. must be notified of any variation from the dimensions and conditions shown in these drawings.
- Boundary, easement, topography, building location, and other survey information shown herein is taken from plans by ...
- All dimensions shown are to wall center unless otherwise noted. All spot elevations are to finished concrete work, unless otherwise noted.
- Contractor shall be responsible for confirming and verifying final grades, slopes, and swales with Civil Engineer's Grading and Drainage Plan and the Hardscape Plans. Any discrepancies between these plans shall be brought to the immediate attention of the Owner's Engineer and Landscape Architect prior to final bid and/or construction. Positive drainage shall be maintained in all areas. Area drains may need to be added where positive drainage can not occur.
- Contractor shall refer to the Landscape Plans for the locations of all major trees and plants to be planted on site. The General Contractor shall be responsible for installing markers, such as 4'-0" diameter sonotube, or approved equal to identify these areas. The General Contractor shall be responsible for coordinating with subs that these areas remain free of pipes, conduit, transformer, etc. Any re-locations or re-routing of site infrastructure shall be the responsibility of the contractor.

GENERAL LEGEND

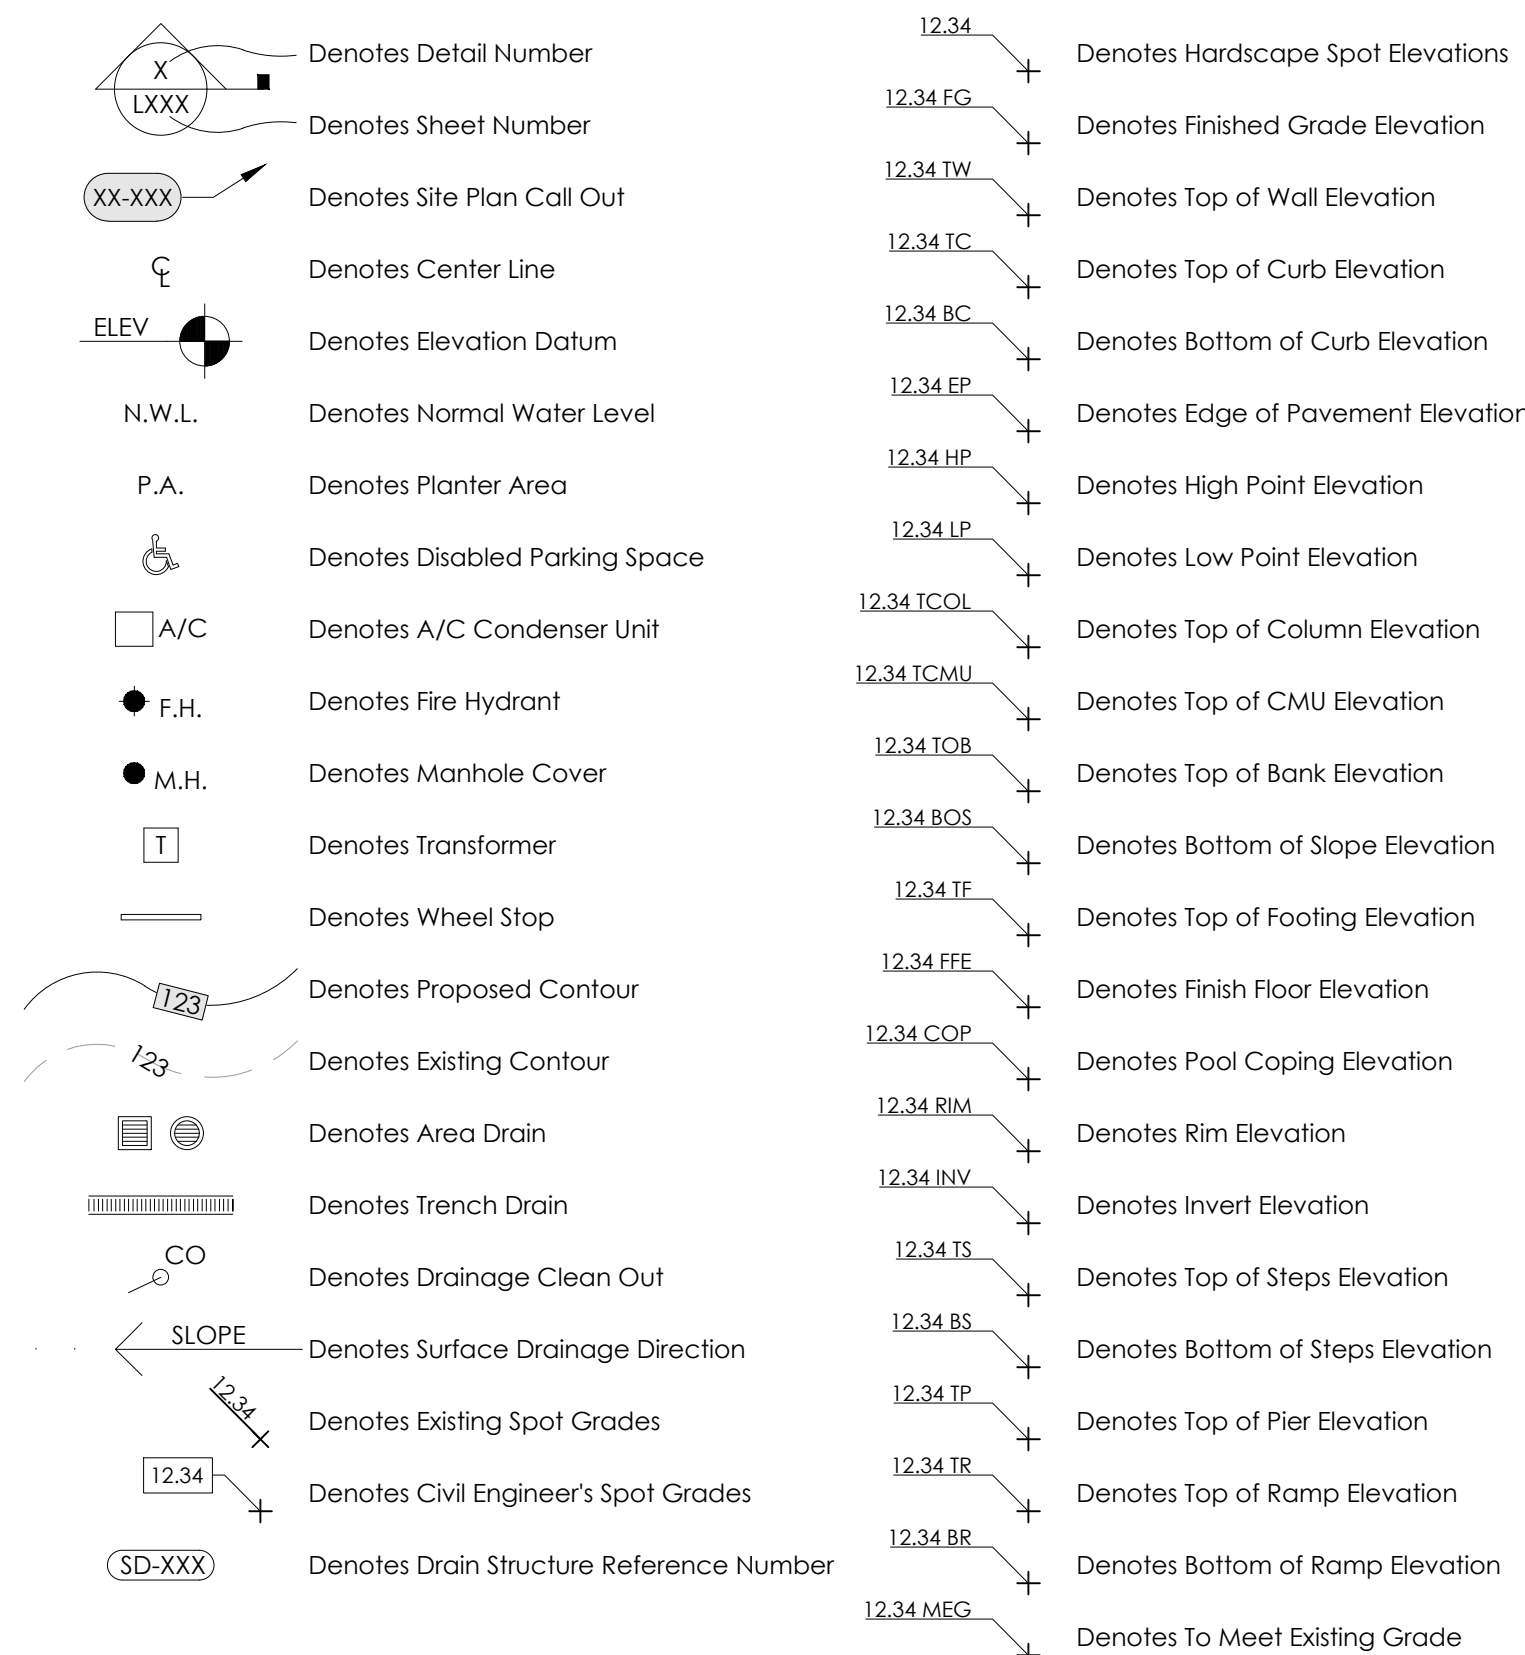

PRODUCTS AND MATERIALS SCHEDULE

CODE	DESCRIPTION	MANUFACTURER	PRODUCT NAME	PRODUCT NUMBER	PRIMARY COLOR	SIZE	INSTALLATION PATTERN	ADDITIONAL INFORMATION	DETAIL
EXTERIOR PAINTS									
09-91	EXTERIOR PAINT - BRICK SHALL BE PAINTED WITH AN EXTERIOR, MASONRY GRADE PAINT. - ALL PAINTED SURFACES SHALL BE PREPARED PER MANUFACTURER RECOMMENDATIONS. - COLOR AND SHEEN TO BE COORDINATED WITH FACILITY MAINTENANCE TEAM TO MATCH EXISTING COLORS AT GOLFBAG DROP SHELTER.								N/A
FIREPLACE SPECIALTIES									
10-32A	COURTYARD 42" FIREPLACE INSERT MANUFACTURER: OUTDOOR INSERT BY HEARTH & HOME TECHNOLOGIES; 888.427.3973 PRODUCT NUMBER: COURTYARD 42 PRODUCT OPTIONS: - STANDARD TRADITIONAL INTERIOR PANELS - STAINLESS STEEL GRATE WITH STANDARD LOG SET - WALL TIMER ON/OFF SWITCH SHALL BE LOCATED IN A DISCRETE LOCATION FOR OPERATION BY STAFF ONLY. INCLUDE REMOTE EMERGENCY SHUT-OFF FOR GAS SUPPLY DIMENSIONS: 42" WIDE X 34" HEIGHT X 20" DEPTH INSTALL PER MANUFACTURER REQUIREMENTS. INSTALLATION SHALL BE BY A LICENSED INSTALLER. NOTE: INSERT WAS RECENTLY REDESIGNED BY THE MANUFACTURER. VERIFY THE INSERT ORDERED FOR INSTALLATION IS THE CORRECT VERSION TO FIT THE PROVIDED ROUGH OPENING. ALTERNATE INSERTS SHALL BE APPROVED BY THE LANDSCAPE ARCHITECT AND/OR OWNER. ALTERNATES THAT DO NOT FIT THE ROUGH OPENING DESIGNED, SHALL BE APPROVED BY THE LANDSCAPE ARCHITECT AND/OR STRUCTURAL ENGINEER. ANY STRUCTURAL CHANGES OR FIREPLACE REDESIGN, DUE TO THE USE OF AN ALTERNATE INSERT, SHALL BE AT THE EXPENSE OF THE CONTRACTOR.								N/A
UNIT PAVING									
32-14	PAVER INSTALLATION: - REFER TO HARDSCAPE PLANS FOR LAYOUT - INSTALLATION / ATTACHMENT PER MANUFACTURER'S RECOMMENDATIONS FOR EACH APPLICATION. - CONTRACTOR SHALL SUBMIT PAVER SAMPLES OR CONSTRUCT A 6' X 6' SAMPLE PANEL FOR APPROVAL BY LANDSCAPE ARCHITECT OR OWNER. THE SAMPLE PANEL SHALL BE THE BASIS OF ACCEPTANCE OR REFUSAL OF FINISHED WORK. NO PORTION OF THE SAMPLE PANEL SHALL BE INCLUDED INTO THE FINISHED WORK. - INSIDE AND OUTSIDE CORNERS OF ALL PAVER HEADER BANDS SHALL BE (4) 4" X 4" PAVERS. ALTERNATIVELY, CORNERS MAY BE MITERED. ALL CORNERS SHALL BE CONSISTENT.								SHEET L401
32-14A	4" X 8" BRICK PAVEMENT COURSE	TREMIRON, MARK NORMINGTON: 904.359.5900	4 X 8 BRICK PAVEMENT	PV21040	TBD	4" W X 8" L X 2-3/8" D	INSTALL AS HEADER COURSE AROUND PERIMETER OF PAVER AREAS, AS SHOWN ON PLANS.	INSTALL PER MANUFACTURER'S RECOMMENDATION.	SHEET L401
32-14B	4" X 8" CONCRETE PAVEMENT FIELD	TREMIRON, MARK NORMINGTON: 904.359.5900	4 X 8 BRICK PAVEMENT	PV21040	TBD	4" X 8" X 3-1/8" THICKNESS	HERRINGBONE AT 45 DEGREES TO TO THE BUILDING.	INSTALL PER MANUFACTURER'S RECOMMENDATION FOR ROADWAY INSTALLATION.	SHEET L401
32-14C	4" X 9" REGULAR BULLNOSE COPING CONCRETE PAVEMENT	TREMIRON, MARK NORMINGTON: 904.359.5900	REG. BULLNOSE	8N2020	TBD	4" W X 9" L X 2-3/8" D	INSTALL AS HEADER COURSE AT STAIR TREADS, AS SHOWN ON PLANS.	MORTAR SET TO CONCRETE STAIR USING MANUFACTURER RECOMMENDED MORTAR.	SHEET L401
AGGREGATE SURFACE									
32-15A	CLEAN SHELL AND/OR SEASHELL MIX	N/A	CLEAN SHELL AND/OR SEASHELL	N/A	WHITE/CREAM/ORANGE	2" - 4" DIA		INSTALL AT 2-1/2" DEPTH OVER GEOTEXTILE FABRIC. MATERIAL TO BE CLEAN SEASHELL (2" 4" DIA). SHELLS TO BE WASHED. CONTRACTOR TO PROVIDE SAMPLE OF SHELLS IN QUART-SIZED ZIPLOCK FOR APPROVAL.	12/L401
FENCES AND GATES									
32-31A	RAINIER CABLE RAILING SYSTEMS	AGS STAINLESS: 1.888.842.7492	RAINIER CABLE RAILING SYSTEM					RAINIER CABLE RAILING SYSTEM TOP RAIL: FLAT TOP WITH REDUCED STEM INFILL: HORIZONTAL CABLE RAILING FINISH: BRUSHED STAINLESS STEEL MOUNT: TOP MOUNT WITH COVER PLATE HEIGHT: 42" TOP RAIL HEIGHT HANDRAIL: BRACKET MOUNTED, ADA COMPLIANT RAIL MANUFACTURER TO PROVIDE FULL SHOP DRAWINGS FOR REVIEW PRIOR TO FABRICATION AND INSTALLATION. INSTALL PER MANUFACTURER RECOMMENDATION.	6/L401
RETAINING WALLS									
32-32	SEGMENTAL WALL INSTALLATION: - REFER TO HARDSCAPE PLANS FOR LAYOUT. - INSTALLATION / ATTACHMENT PER MANUFACTURER'S RECOMMENDATIONS FOR EACH APPLICATION. - CONTRACTOR TO PROVIDE ENGINEERED SHOP DRAWINGS FROM MANUFACTURER FOR SEGMENTAL WALL. DRAWINGS TO SHOW WALL LAYOUTS, SECTIONS, STAIR DETAILS, LEVELING PAD DEPTH AND SIZING, LEVELING PAD MATERIAL AND COMPACTION, TIEBACKS, AND ANY OTHER PERTINENT INFORMATION. THESE SHOP DRAWINGS TO BE PROVIDED TO THE LANDSCAPE ARCHITECT FOR REVIEW AND APPROVAL PRIOR TO INSTALLATION. - WALLS BLOCKS SHALL BE INSTALLED IN A RANDOM PATTERN. NO VERTICAL JOINT SHOULD EXTEND MORE THAN TWO COURSES.								SHEET L401
32-32A	STONEGATE 6" CONTEMPORARY SEGMENTAL WALL	KEYSTONE RETAINING WALL SYSTEMS	STONEGATE	6" CONTEMPORARY	GRANITE	10" W X 6 7/4", 12 7/10", 16 7/14" L X 6" D		INSTALL WITH RANDOM PATTERN. VERTICAL JOINTS SHALL EXTEND NO MORE THAN 2 COURSES. INSTALL PER MANUFACTURER RECOMMENDATIONS, USING MANUFACTURER PINS.	SHEET L401
32-32B	STONEGATE 3" CONTEMPORARY SEGMENTAL WALL CAP	KEYSTONE RETAINING WALL SYSTEMS	STONEGATE	3" CONTEMPORARY	GRANITE	8" W X 12 1/4" S'D		INSTALL IN RUNNING BOND WITH EQUAL OVERHANG ON FRONT AND BACK OF WALL. INSTALL PER MANUFACTURER RECOMMENDATION, USE MANUFACTURER RECOMMENDED ADHESIVE.	SHEET L401
STORMWATER CONVEYANCE									
33-42A	4" ROUND ATRIUM GRATE (#78) - PIPE GRATE - COLOR: BLACK - MATERIAL: HDPE							NDS: 877.412.7467	N/A
33-42B	4" ROUND BRASS GRATE W/ PVC COLLAR (#9108) - USE WITH 3" OR 4" DRAIN PIPE - COLOR: SATIN BRASS - MATERIAL: BRASS							NDS: 877.412.7467	14/L401
33-42C	ADS SINGLE WALL PIPE - HDPE CORRUGATED PIPE - 3" - 24" DIAMETERS - ALL FITTINGS AND COUPLINGS SHALL MEET ASTM F667 - INSTALL PER MANUFACTURER RECOMMENDATIONS							ADS: 800.821.6710	N/A

PRODUCTS AND MATERIALS NOTES

- Contractor shall submit samples, shop drawings, and appropriate cut sheets for ALL materials. Additionally, submittals for items not represented on this list may be required. Contact the Landscape Architect if any discrepancies occur.
- For each type of paver and pattern, Contractor shall construct a 6' x 6' sample panel for approval by Landscape Architect and/or Owner. The sample panel shall be the basis of acceptance or refusal of finished work. No portion of the sample panel shall be included in the finished work. Alternatively, at the Owner's discretion, samples of the pavers may be submitted for review and acceptance, and a previously installed section of pavers, from the existing park phase, may be used as the basis of acceptance or refusal of finished work.
- Contact information for vendors is provided to demonstrate the desired specification. General Contractor may submit product alternatives, of an equal or greater quality, to the Landscape Architect and/or Owner for approval via shop drawings and samples.
- Contractor to verify and confirm all quantities.

2/28/2024 9:15:18 AM




planning
architecture
landscape architecture
urban design
visual communication

Jacksonville
ELM Studio
1301 Riverplace Boulevard
Suite 1818
Jacksonville, FL 32207
t. 904.296.8066

elmplanning.com

AA26000604 - LC26000209

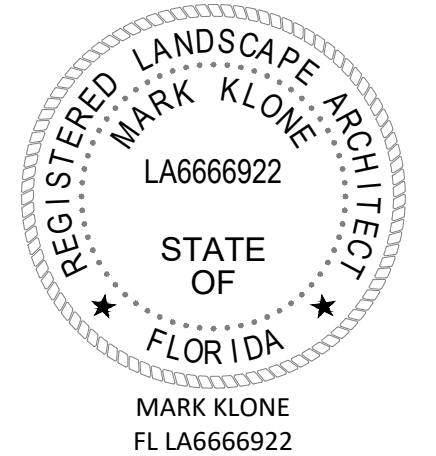

GOLF CLUB OUTDOOR BAR
PONTE VEDRA INN & CLUB
PONTE VEDRA BEACH, ST. JOHNS COUNTY, FLORIDA

ISSUE DATES

NO.	DESCRIPTION	DATE

THIS DRAWING IS AN INSTRUMENT OF SERVICE AND THE PROPERTY OF ELM, INC. AND SHALL REMAIN THEIR PROPERTY. THE USE OF THIS DRAWING SHALL BE RESTRICTED TO THE ORIGINAL SITE FOR WHICH IT IS PREPARED, AND PUBLICATION THEREOF IS EXPRESSLY LIMITED TO SUCH USE.

PROJ. #: 22-44
DATE: 12.22.2023
DRAWN BY: MCK
CHECKED BY: MCK
SCALE: AS NOTED

GENERAL NOTES & SPECIFICATIONS

SHEET NUMBER
L001
Project Status



planning
architecture
landscape architecture
urban design
visual communication

Jacksonville
ELM Studio
1301 Riverplace Boulevard
Suite 1818
Jacksonville, FL 32207
t 904 296 8066

elmplan.com



GOLF CLUB OUTDOOR BAR
PONTE VEDRA INN & CLUB
PONTE VEDRA BEACH, ST. JOHNS COUNTY, FLORIDA

ISSUE DATES

NO.	DESCRIPTION	DATE
1	AS NOTED	24.02.26

THIS DRAWING IS AN INSTRUMENT OF SERVICE AND THE PROPERTY OF ELM, INC. AND SHALL REMAIN THEIR PROPERTY. THE USE OF THIS DRAWING SHALL BE RESTRICTED TO THE ORIGINAL SITE FOR WHICH IT IS PREPARED, AND PUBLICATION THEREOF IS EXPRESSLY LIMITED TO SUCH USE.


PROJ. #: 22-44
DATE: 12.22.2023
DRAWN BY: MCK
CHECKED BY: MCK
SCALE: AS NOTED

SITE, LAYOUT, & GRADING PLANS


SHEET NUMBER

L101


Project Status

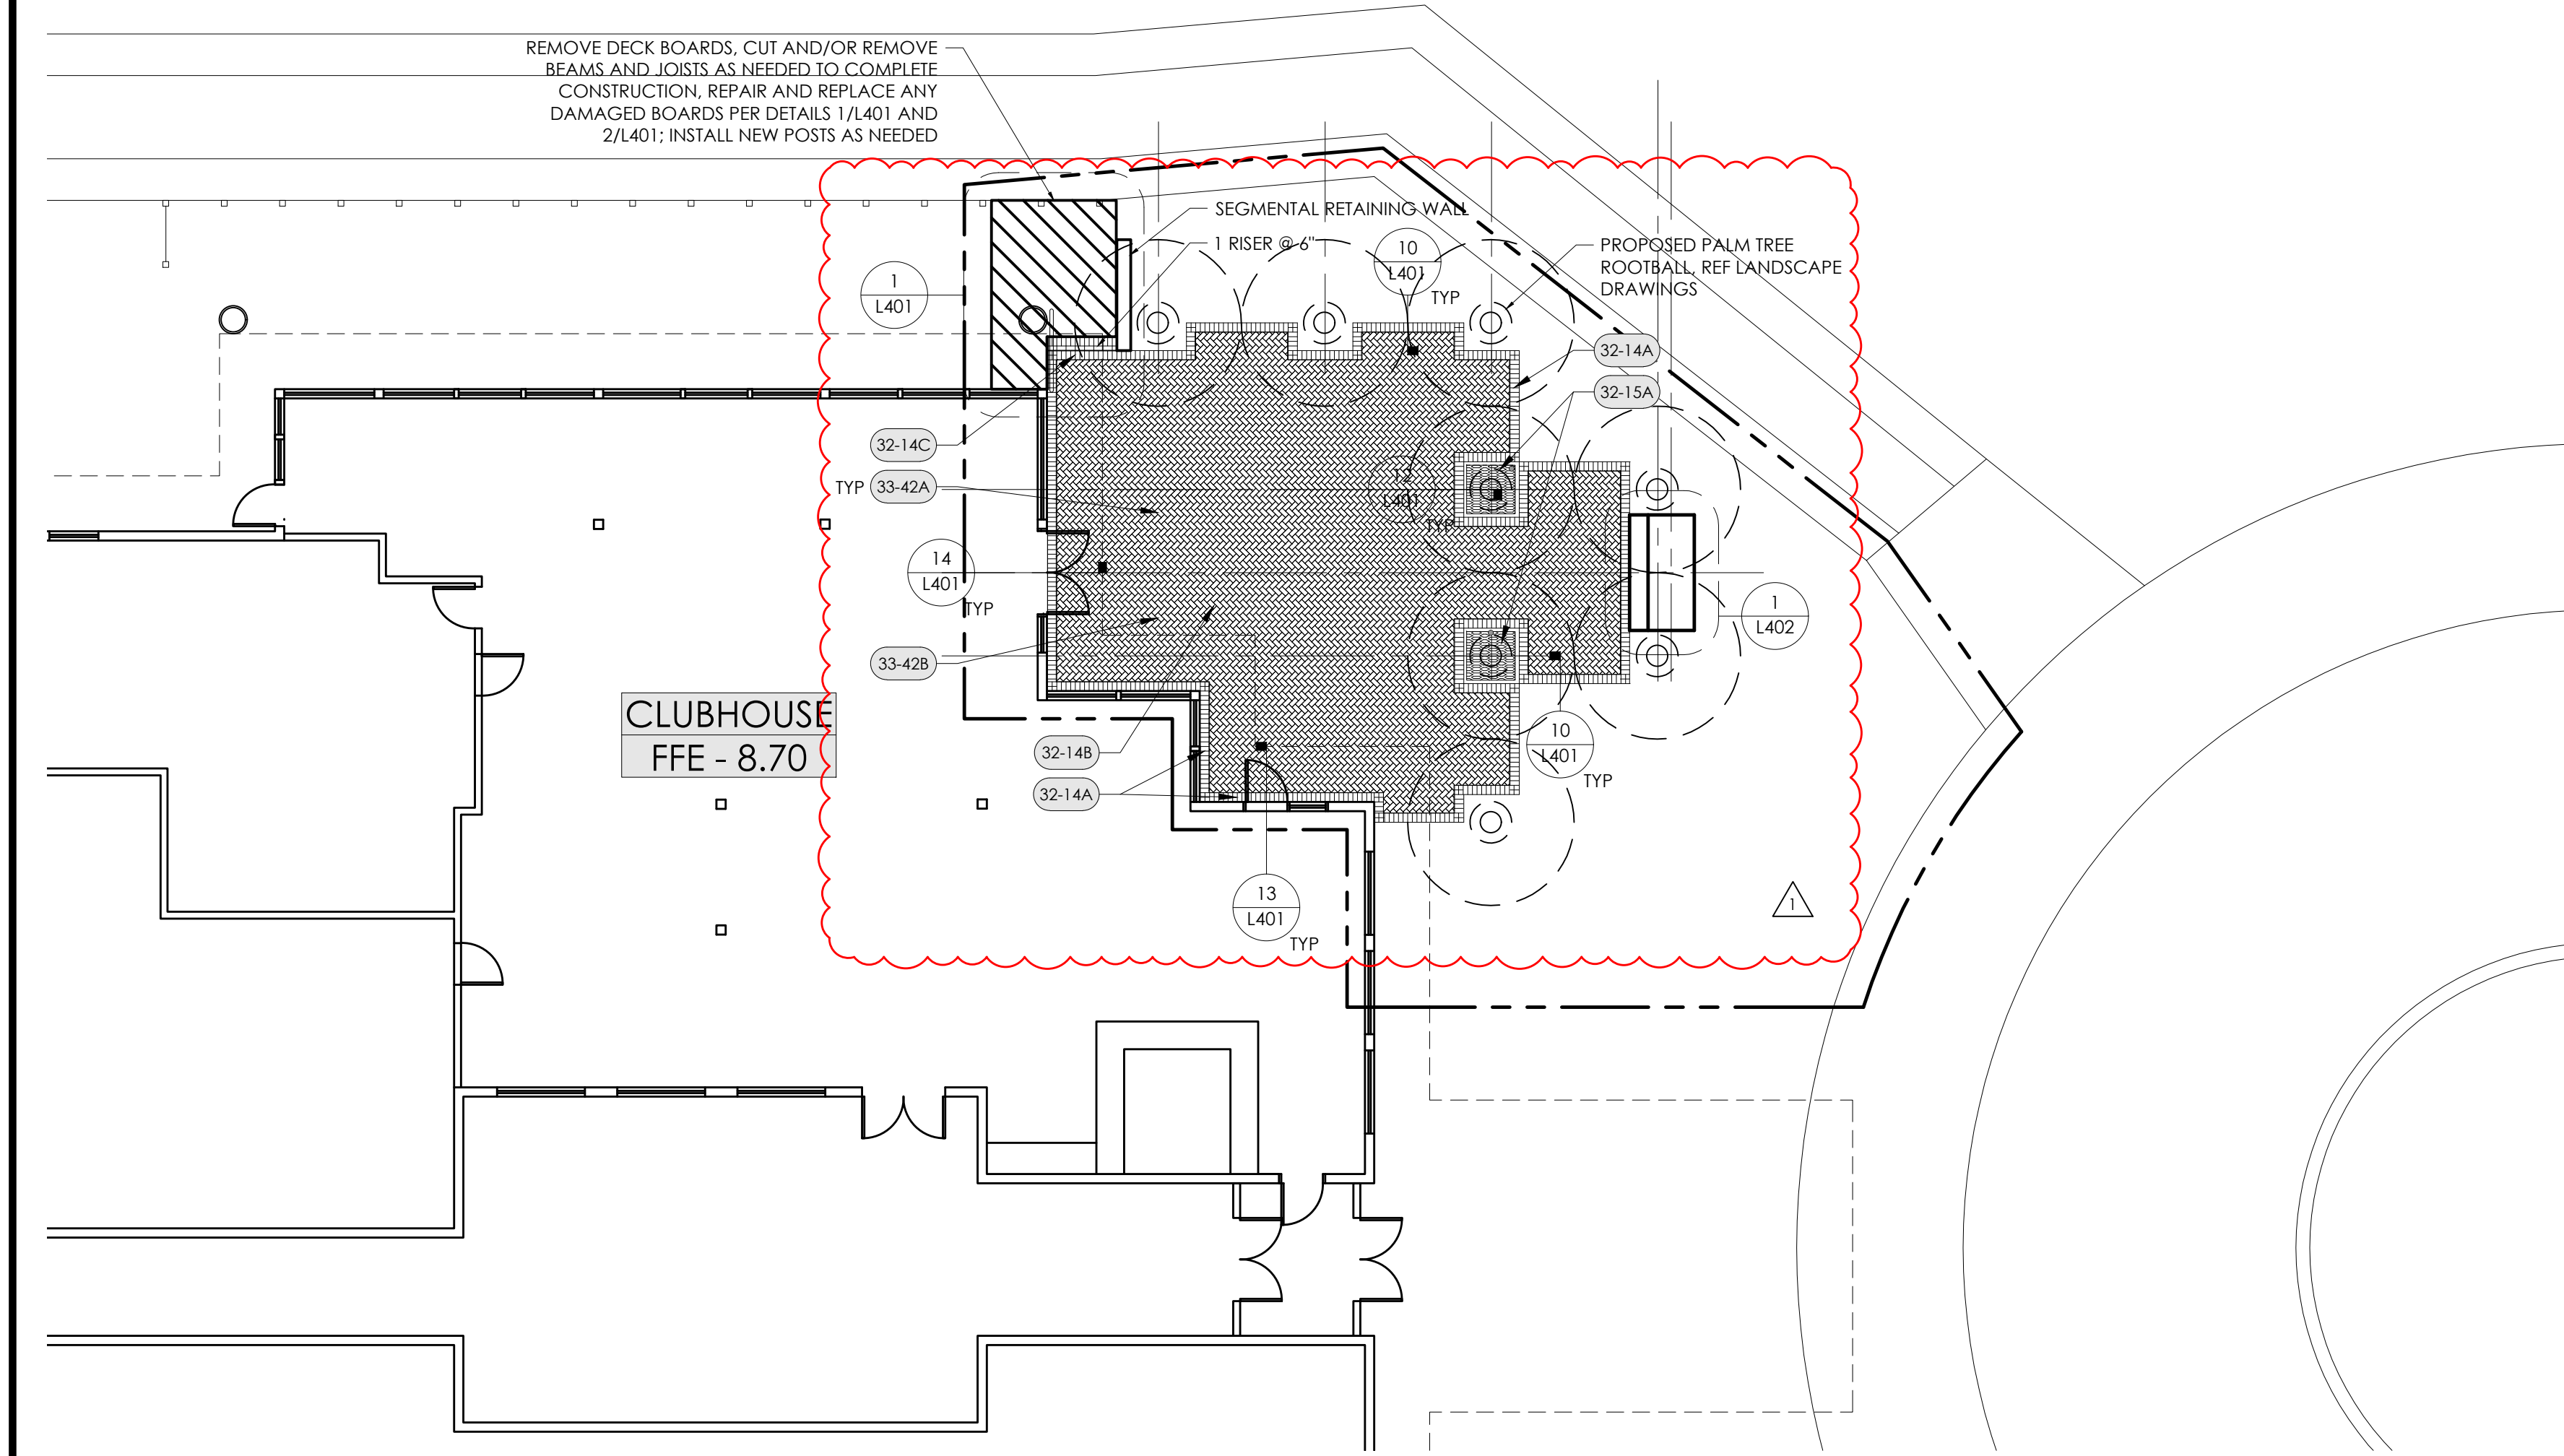

1 SITE PLAN
1" = 10'-0"

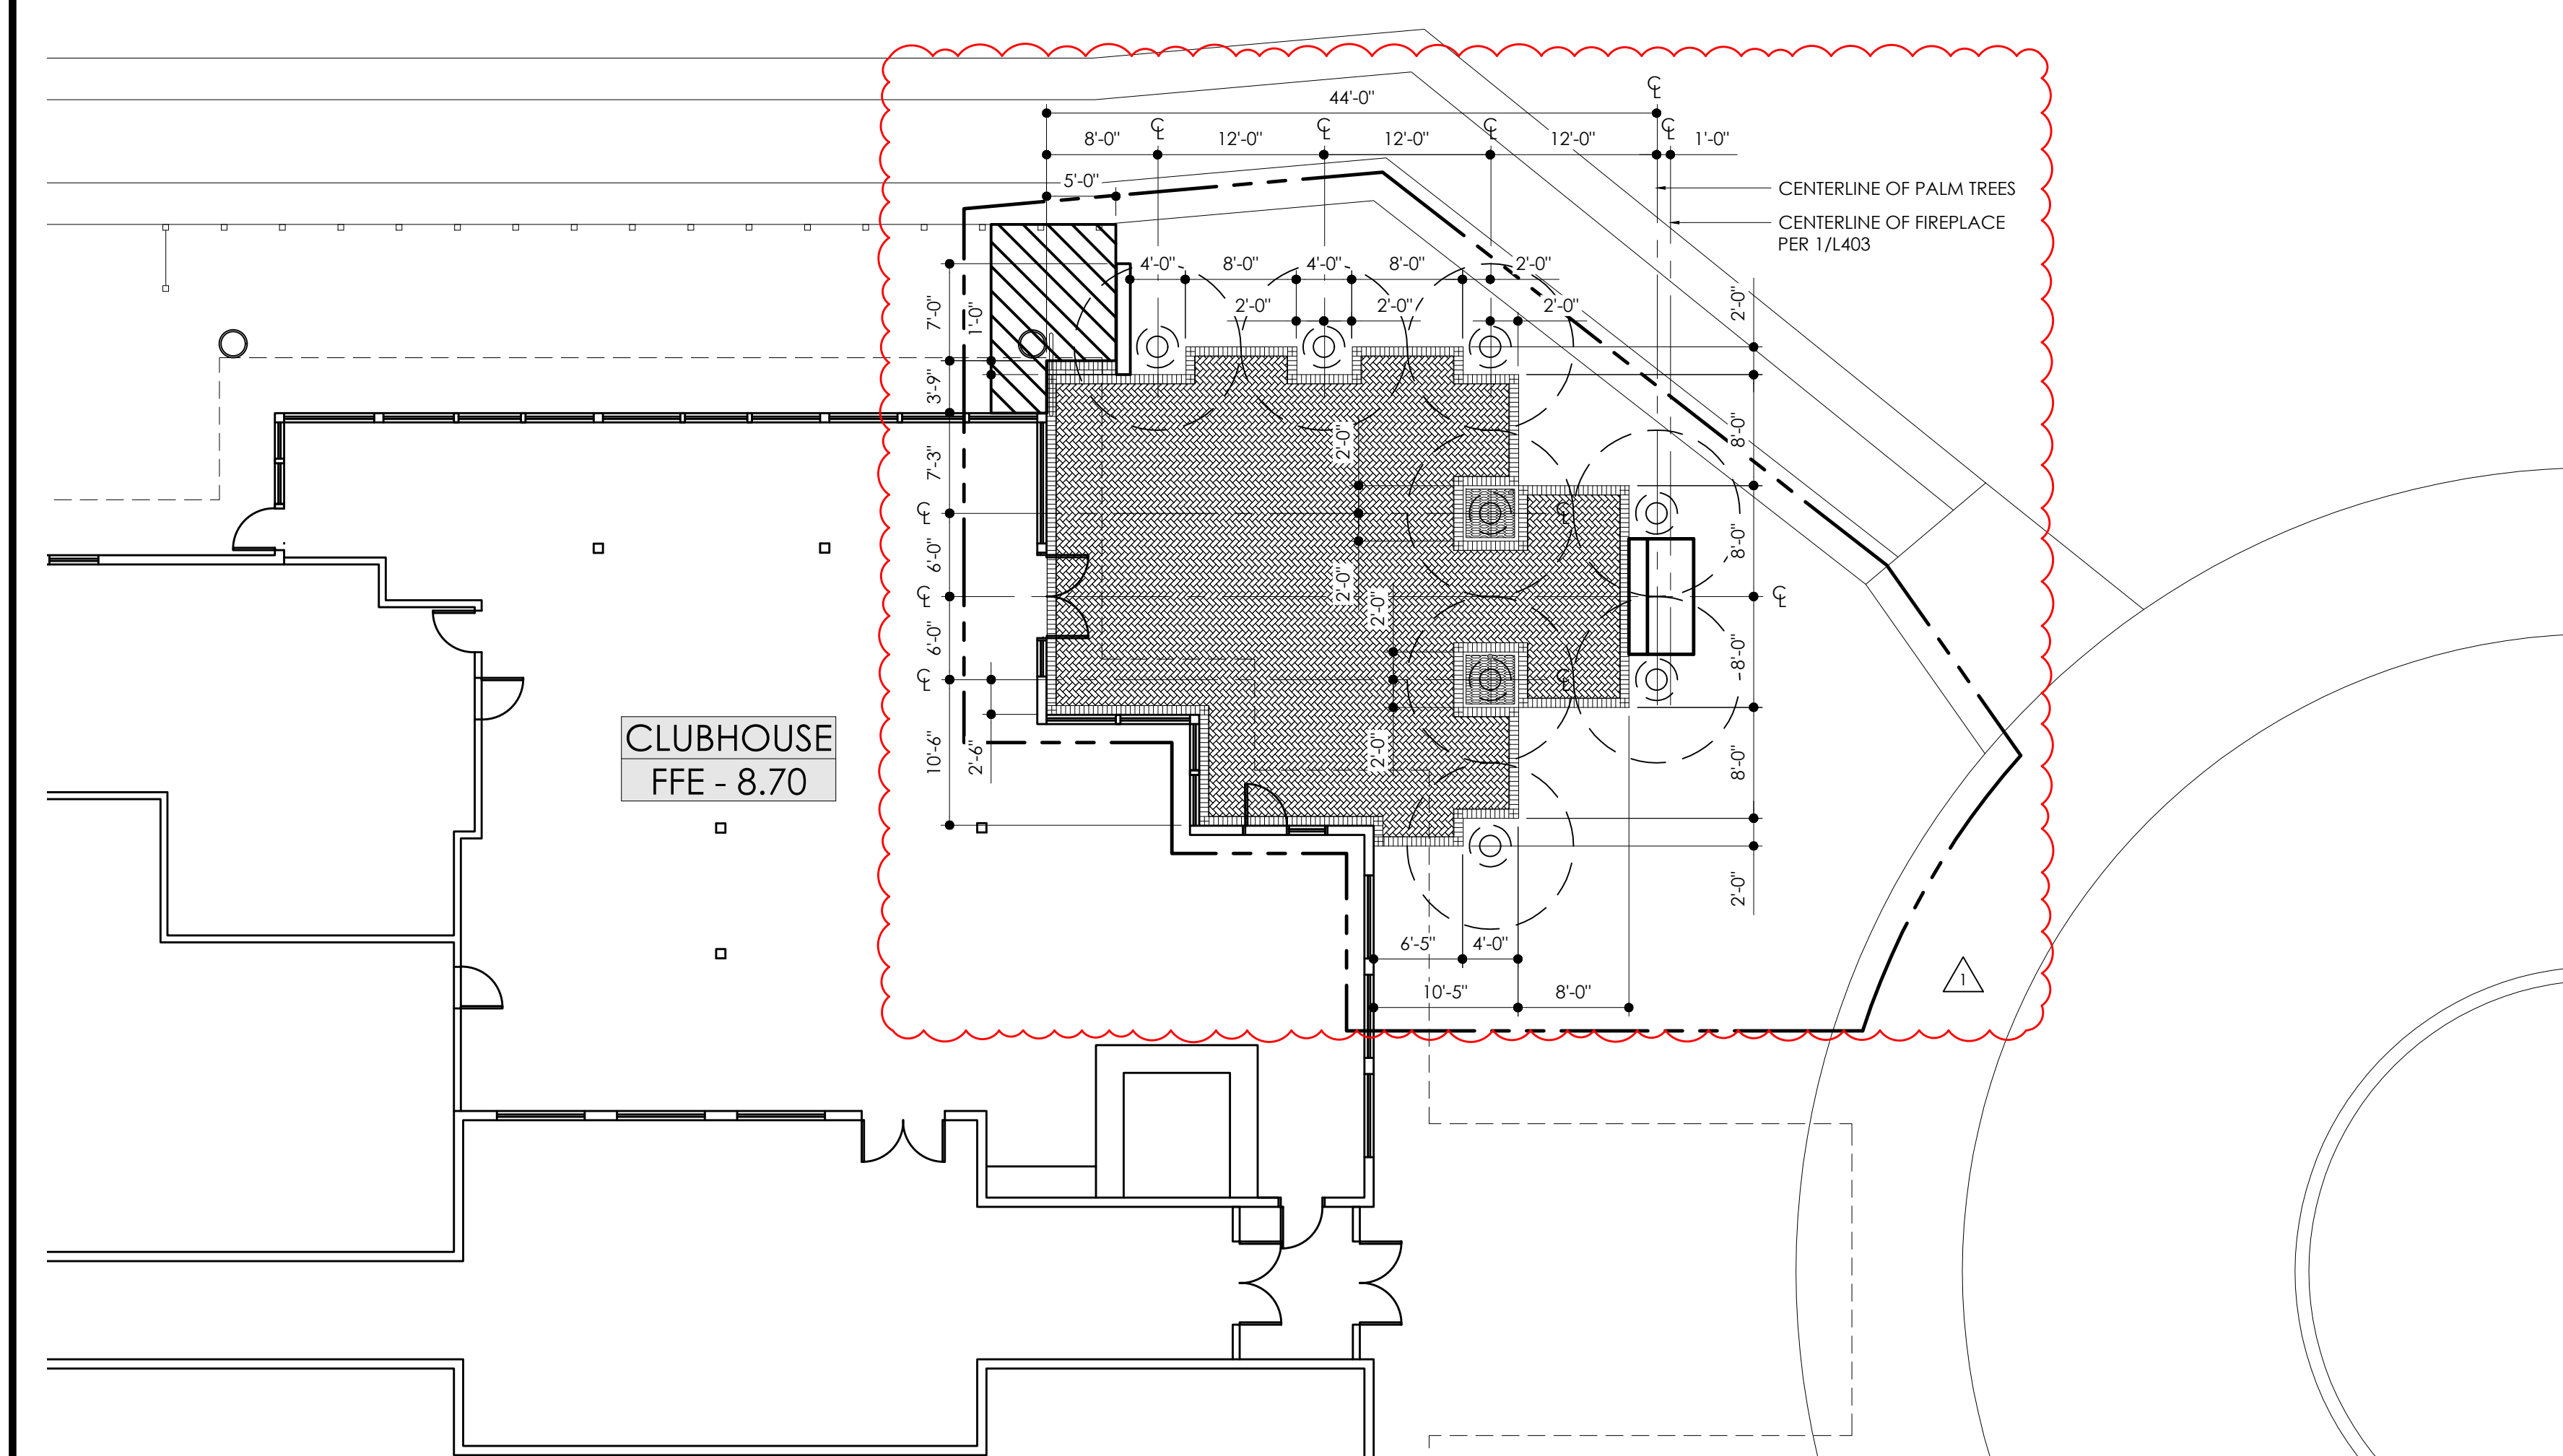


2 LAYOUT PLAN
1" = 10'-0"

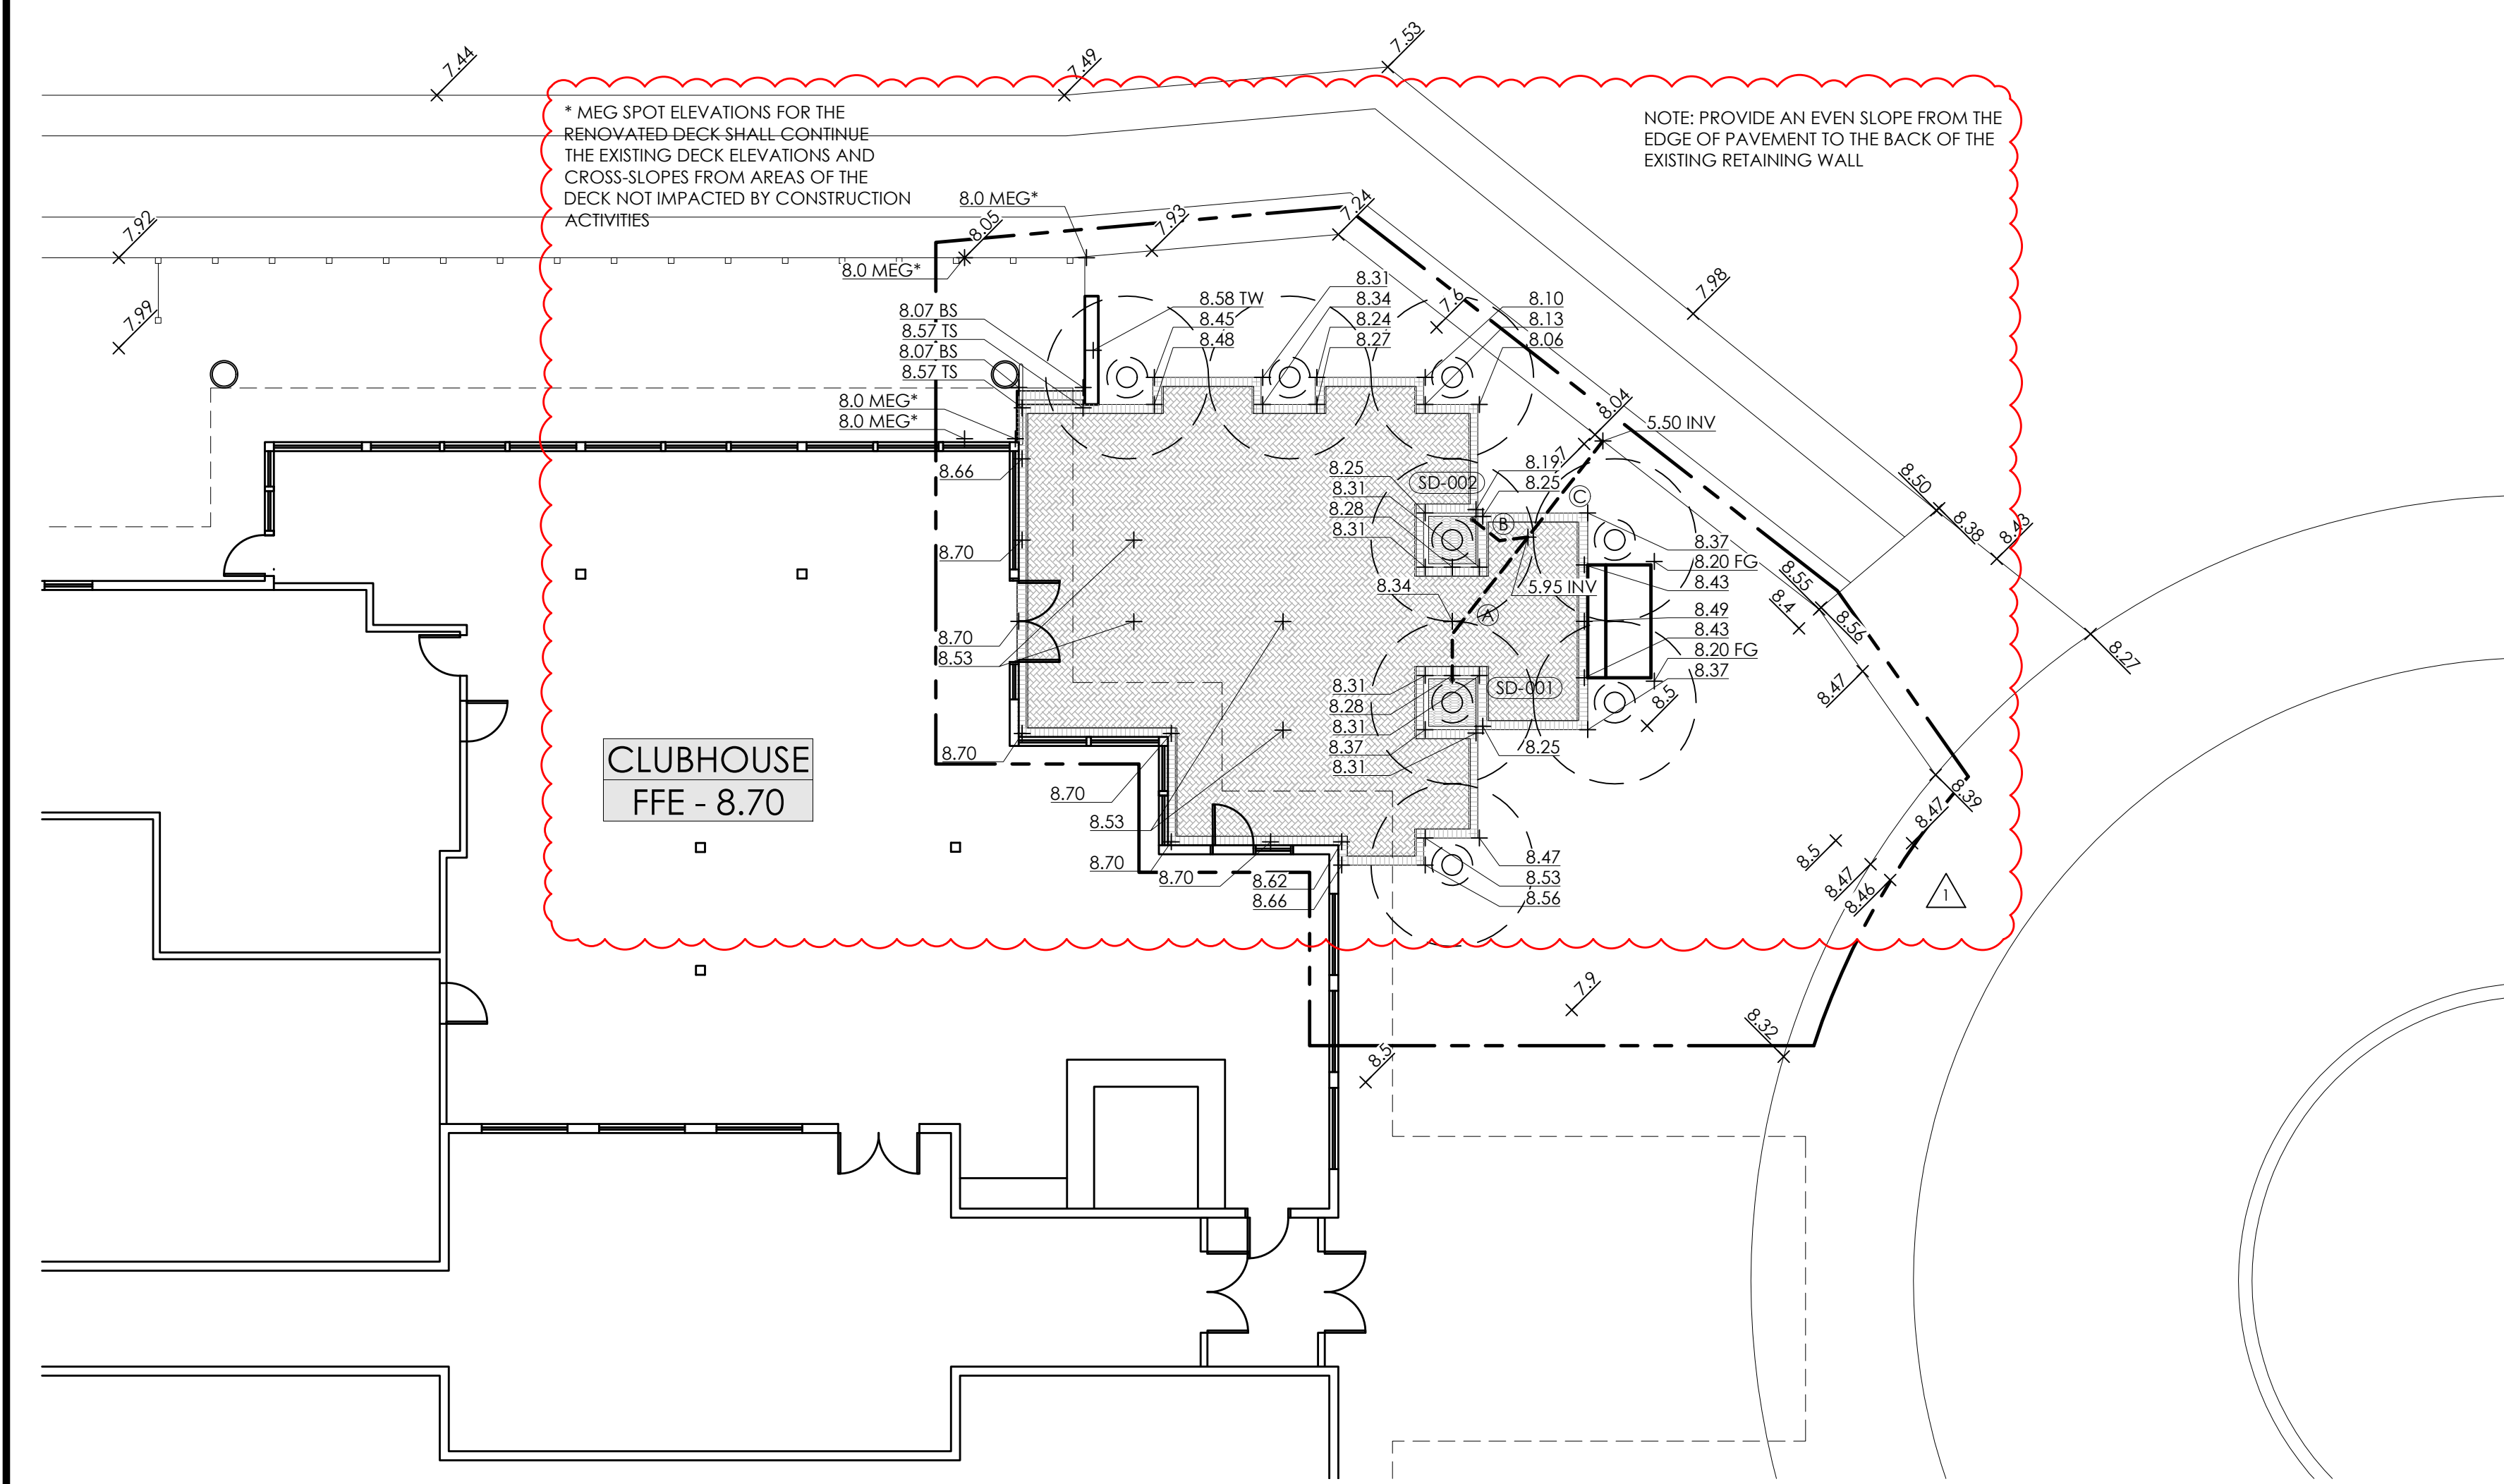

3 GRADING PLAN
1" = 10'-0"

DRAINAGE STRUCTURES								DRAINAGE PIPES				
STRUCTURE ID	TYPE	SIZE	MANUFACTURER	PART #	MATERIAL	COLOR	RIM ELEVATION	INVERT ELEVATION	PIPE ID	DIAMETER	LENGTH	SLOPE
SD-001	ROUND ATRIUM	4"	NDS	78	POLY-OLEFIN	BLACK	8.14	6.57	A	4"	13 LF	5%
SD-002	ROUND ATRIUM	4"	NDS	78	POLY-OLEFIN	BLACK	8.10	6.18	B	4"	5 LF	5%
SD-003									C	4"	9 LF	5%
SD-004												
SD-005												
SD-006												

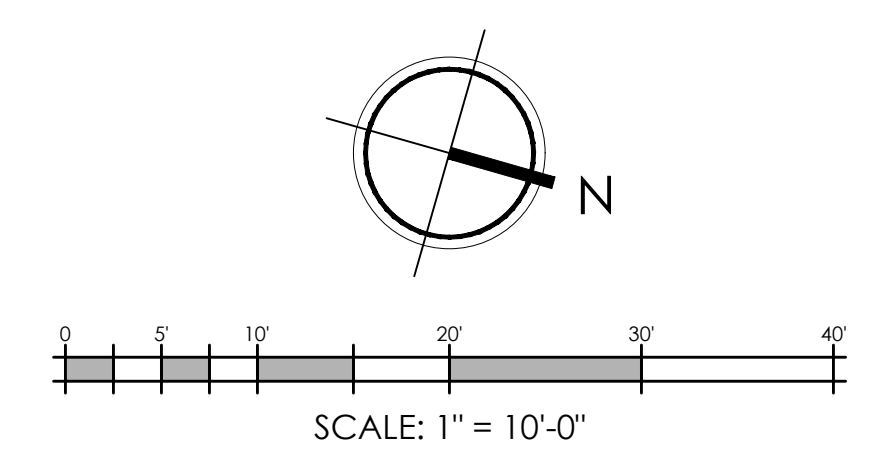

2/28/2024 9:15:19 AM

SEGMENTAL WALL NOTES:

CONTRACTOR TO PROVIDE ENGINEERED SHOP DRAWINGS FROM MANUFACTURER FOR SEGMENTAL WALL DRAWINGS TO SHOW WALL LAYOUTS, SECTIONS, STAIR DETAILS, LEVELING PAD DEPTH AND SIZING, LEVELING PAD MATERIAL AND COMPACTION, BACKFILL MATERIAL AND COMPACTION, TIEBACKS, AND ANY OTHER PERTINENT INFORMATION. THESE SHOP DRAWINGS TO BE PROVIDED TO LANDSCAPE ARCHITECT FOR REVIEW AND APPROVAL PRIOR TO INSTALLATION.


GRILLING STATION TO BE INSTALLED SIMILAR TO KEYSTONE COUNTRY MANOR 3-PIECE GRILL STATION V2 BUT MODIFIED AS SHOWN IN THESE DRAWINGS TO PROVIDE SPACE FOR A GAS GRILL AND BIG GREEN EGG SMOKER. CONTRACTOR IS RESPONSIBLE FOR ALL REQUIRED VENTING, GAS CONNECTIONS, AND OTHER OPERATIONAL NEEDS. OWNER TO SELECT AND/OR PROVIDE ALL GRILLING EQUIPMENT. BASE DESIGN SHOULD BE MODIFIED AS NEEDED TO FIT THE GRILL REQUIREMENTS. CONTRACTOR TO PROVIDE SHOP DRAWINGS FOR APPROVAL.

WALL MANUFACTURER: KEYSTONE RETAINING WALL SYSTEMS


WALL BLOCK STYLE: STONEGATE WALL
 WALL BLOCK SIZES: STANDARD MIX OF 16/14 UNITS, 12/10 UNITS, AND 6/4 UNITS
 WALL BLOCK FINISH: CONTEMPORARY
 WALL BLOCK COLOR: GRANITE
 INSTALL IN RANDOM PATTERN. NO VERTICAL JOINT SHOULD EXTEND MORE THAN 2 COURSES.

WALL CAP STYLE: STONEGATE WALL
 WALL CAP SIZE: 12/10 UNIT
 WALL CAP STYLE: CONTEMPORARY
 WALL CAP COLOR: GRANITE


11 RETAINING WALL NOTES
 NTS

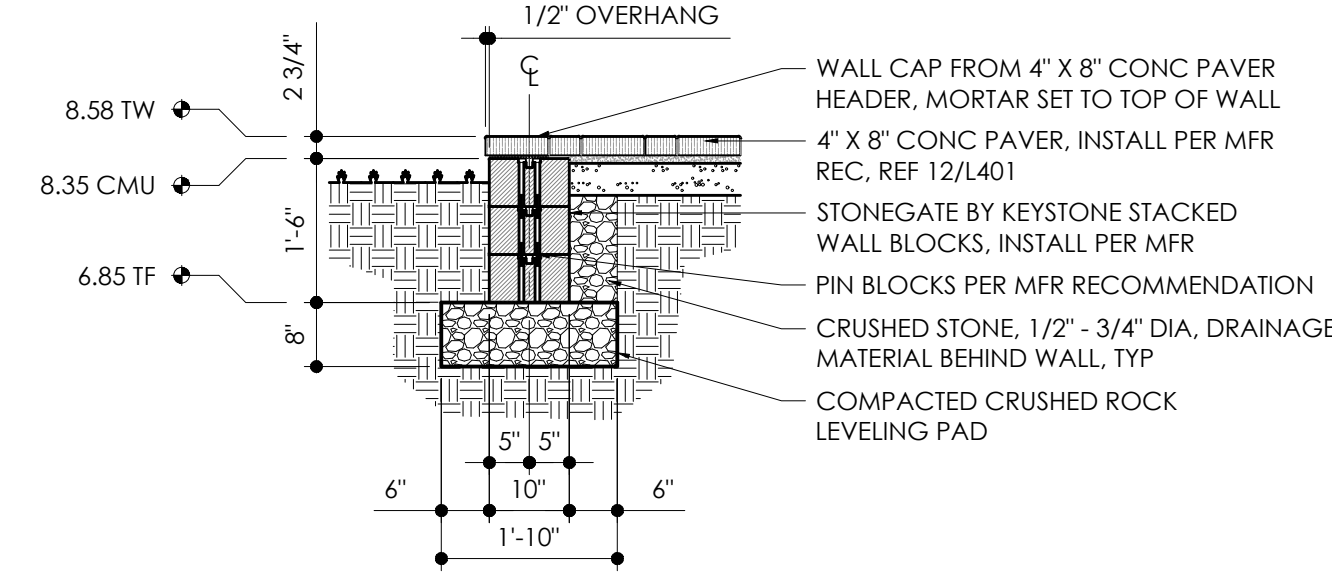


7 RETAINING WALL SECTION
 1/2" = 1'-0"

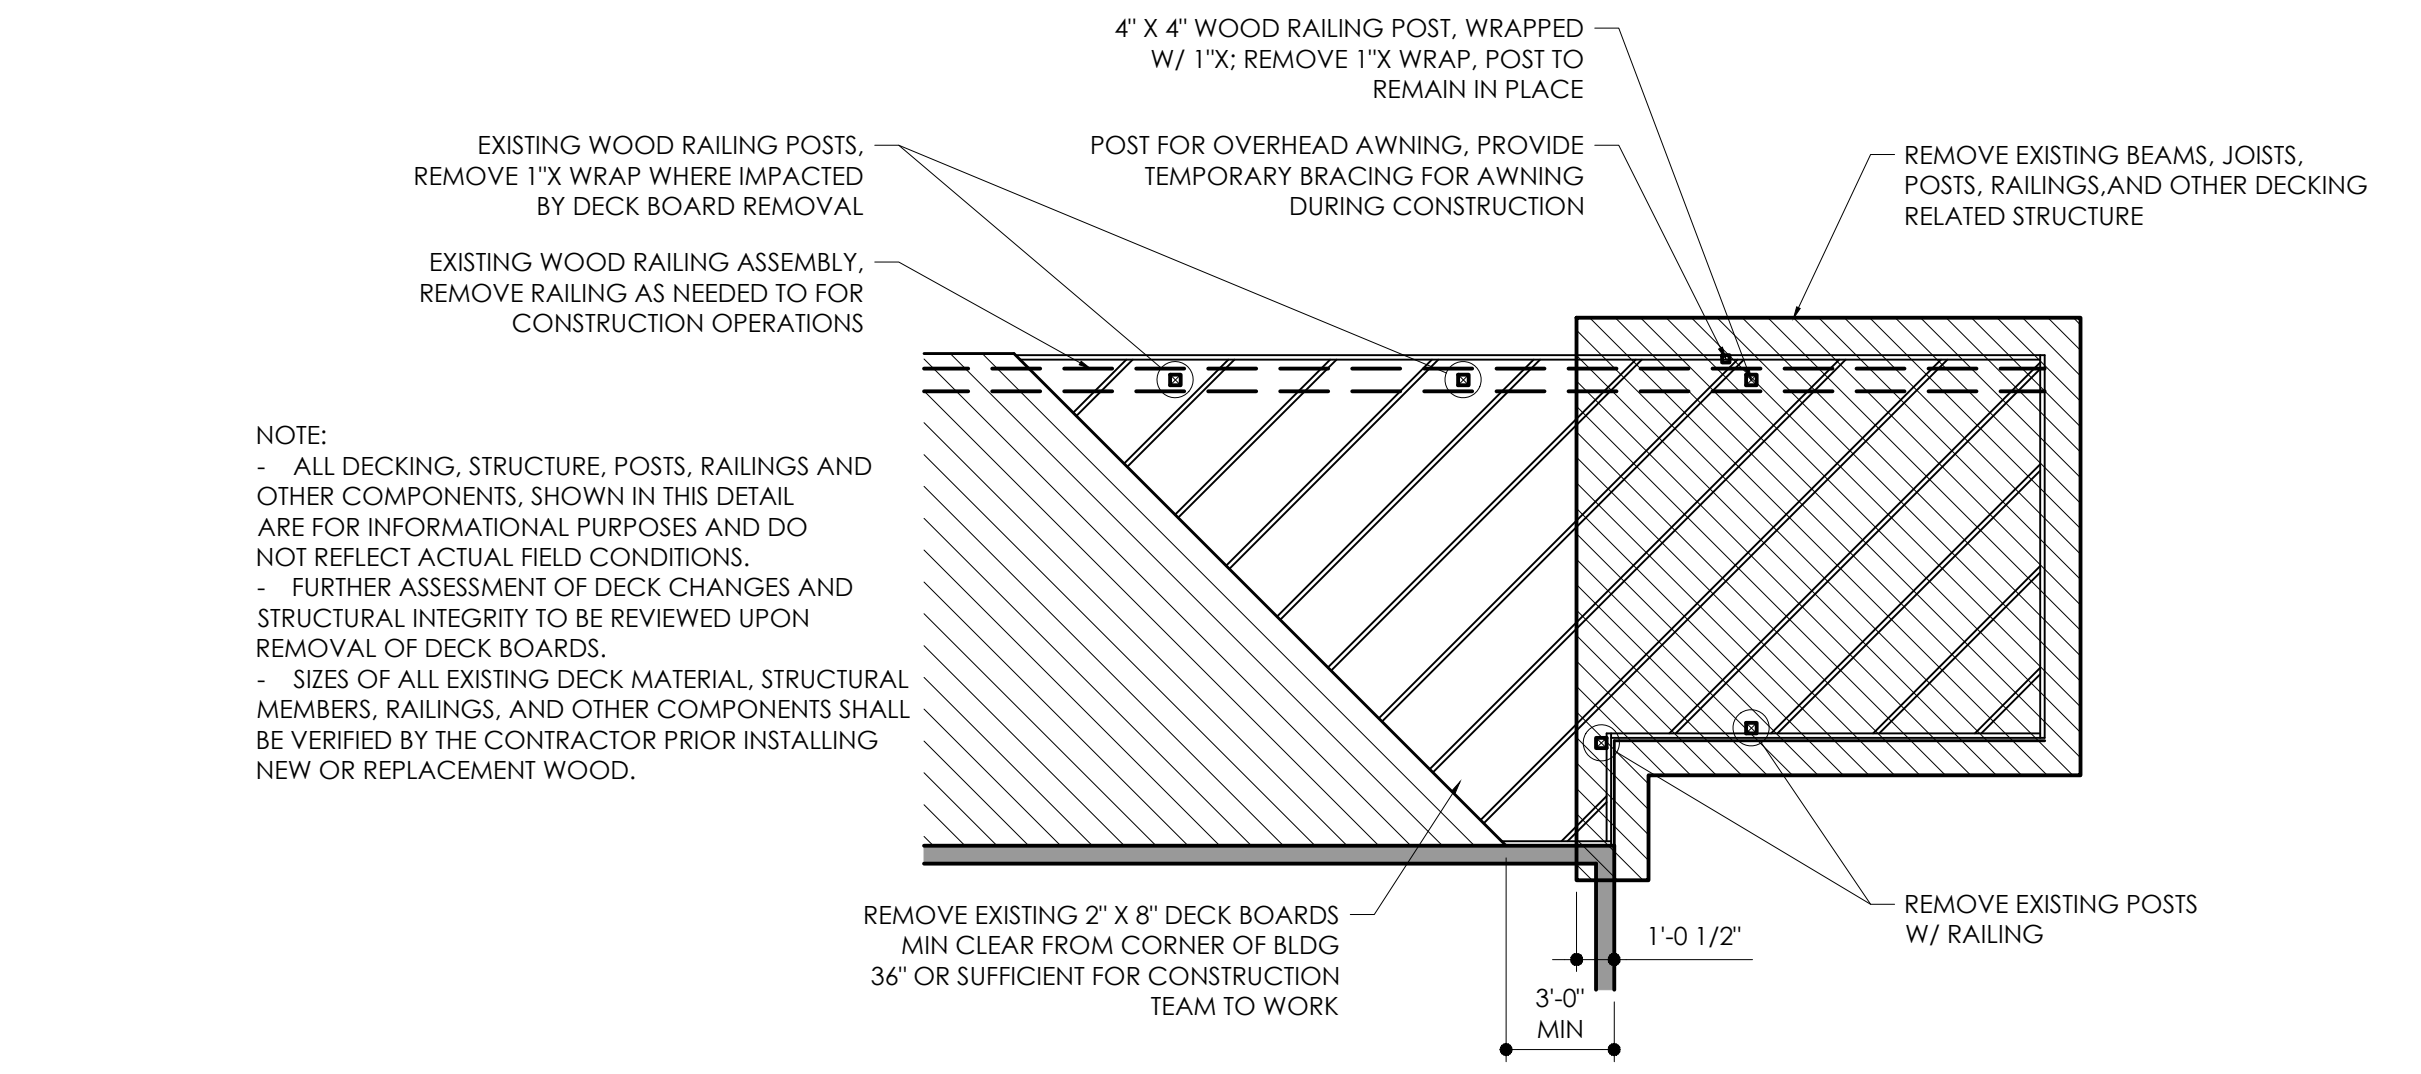


1 WOOD DECK DEMOLITION DETAIL NOTES
 3/16" = 1'-0"

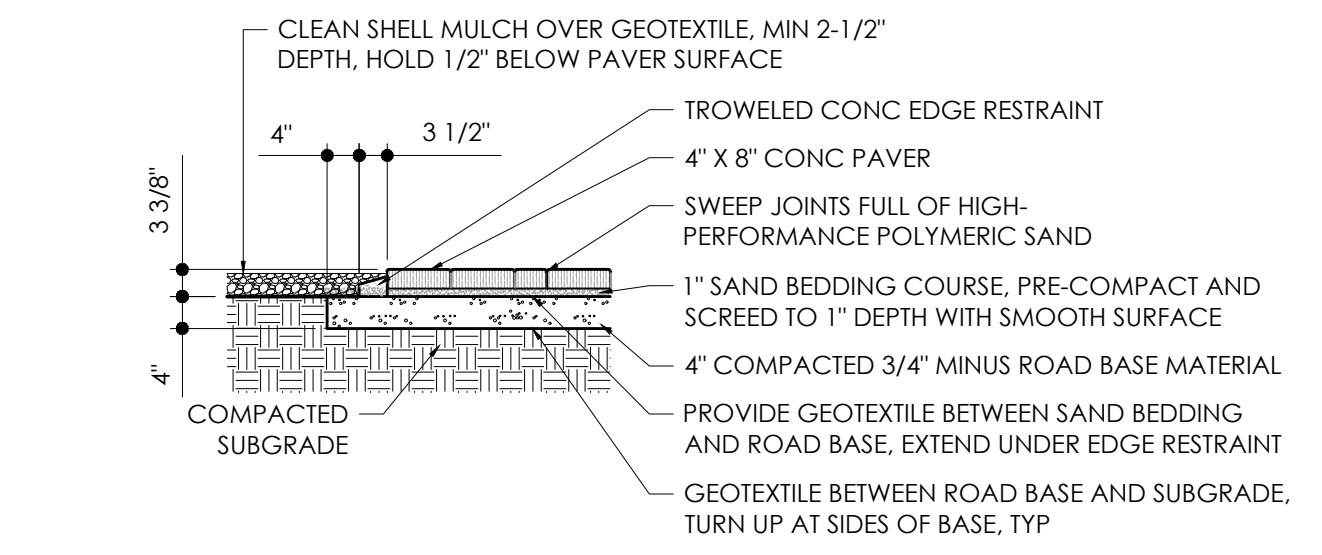


12 PALM BOX PAVER RESTRAINT
 1/2" = 1'-0"

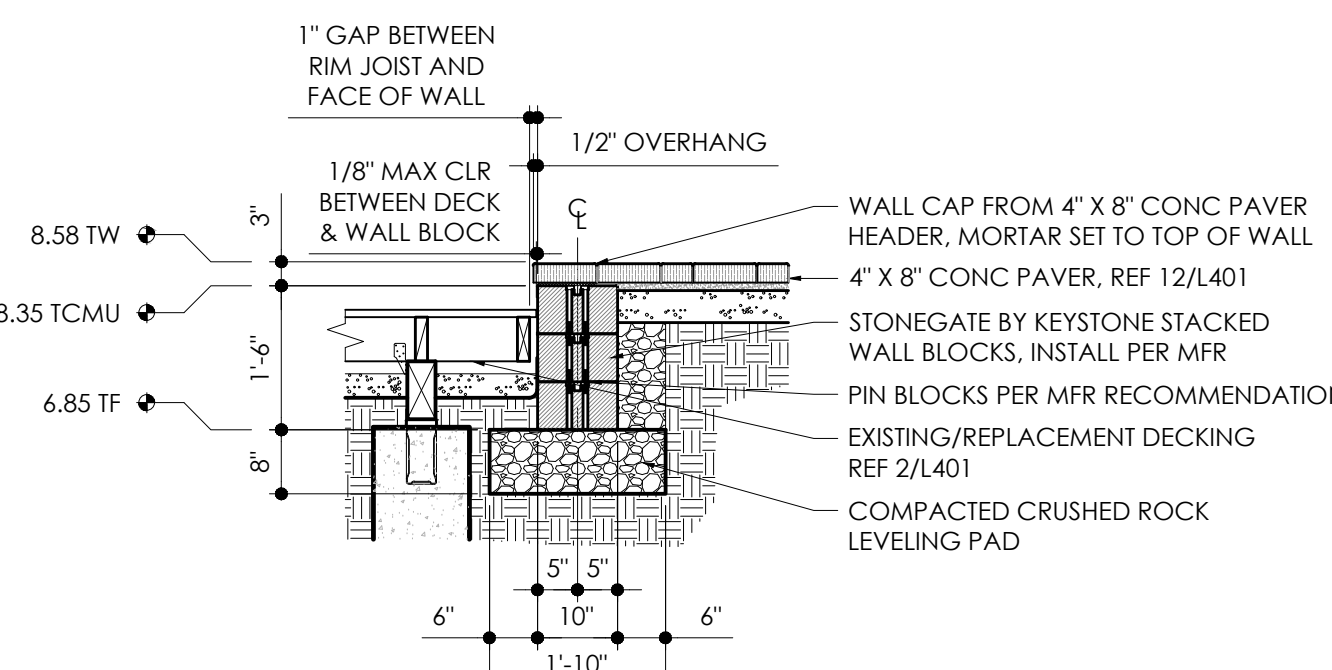


8 RETAINING WALL SECTION
 1/2" = 1'-0"

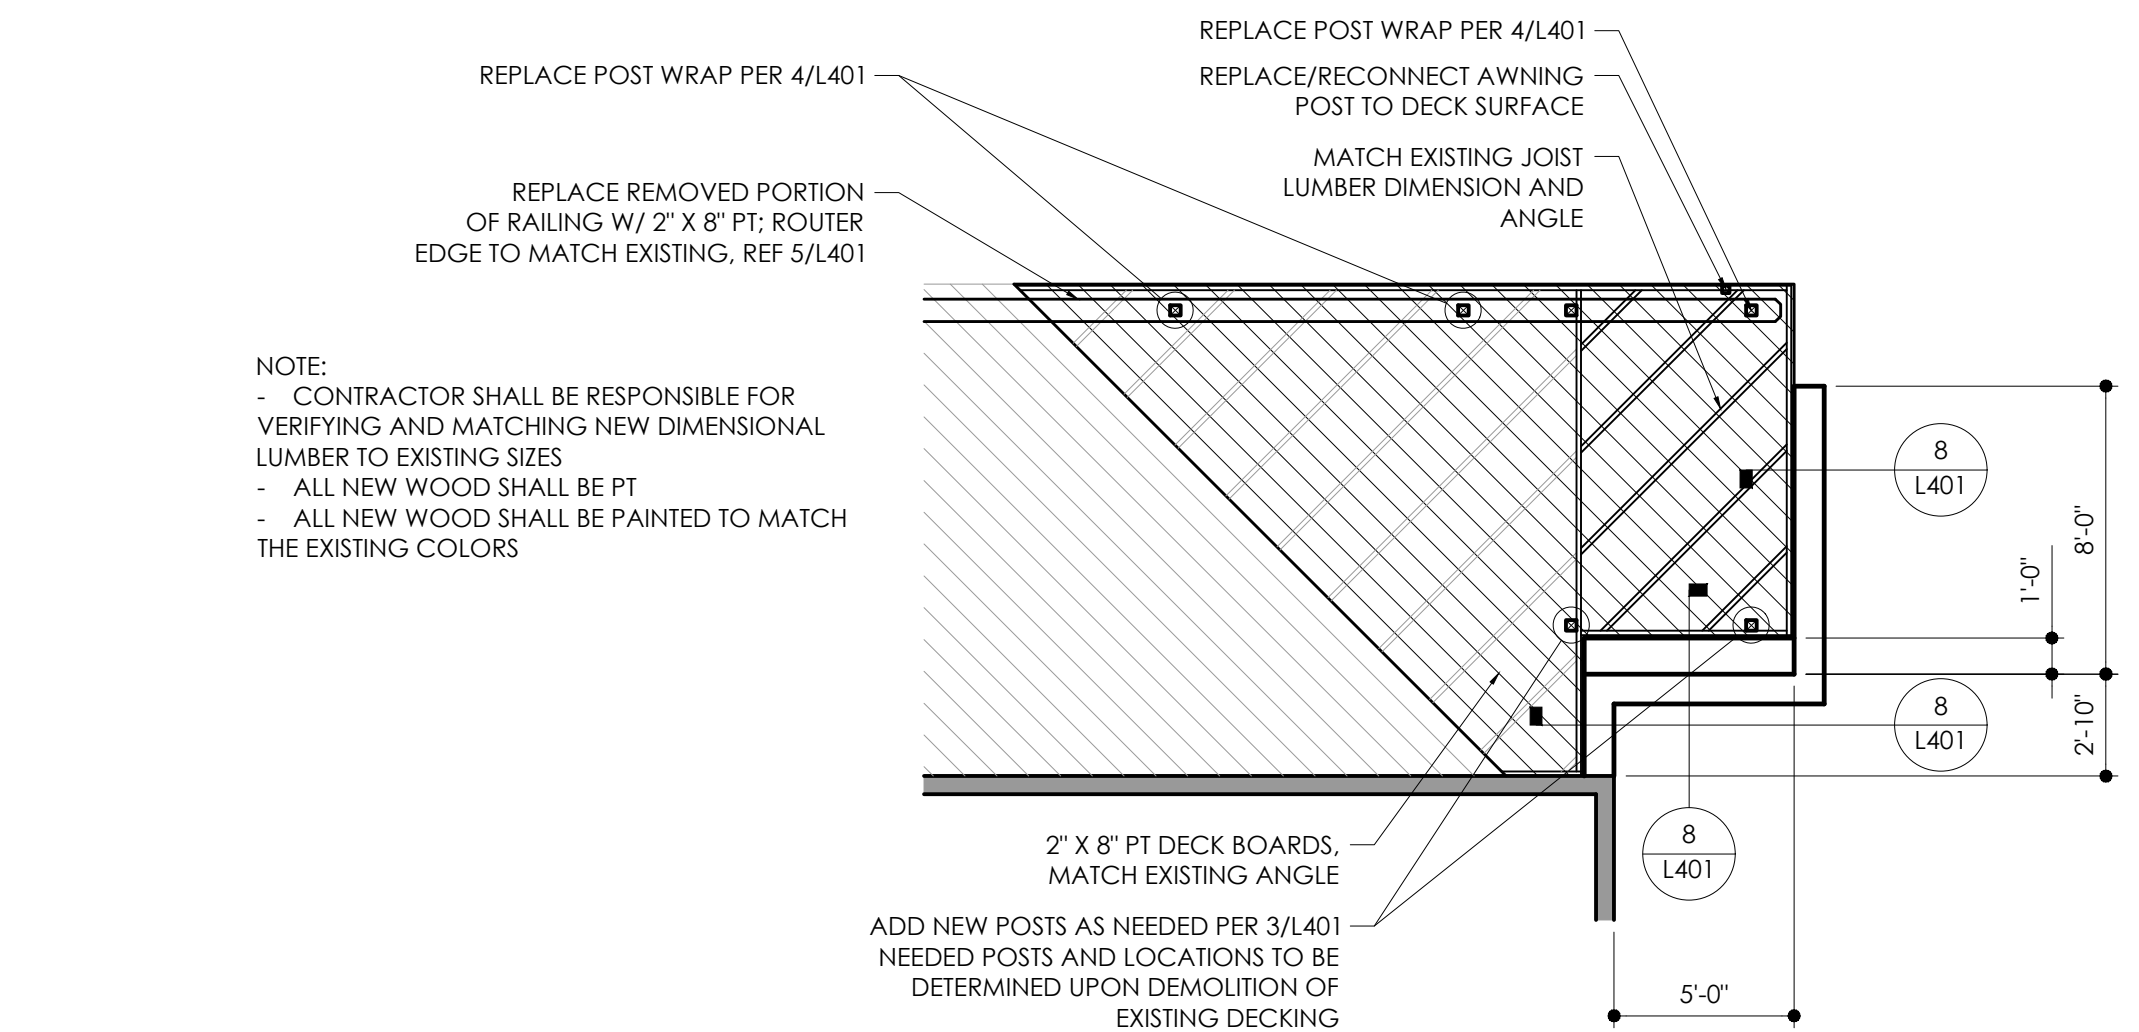


2 WOOD DECK RENOVATION DETAIL NOTES
 3/16" = 1'-0"

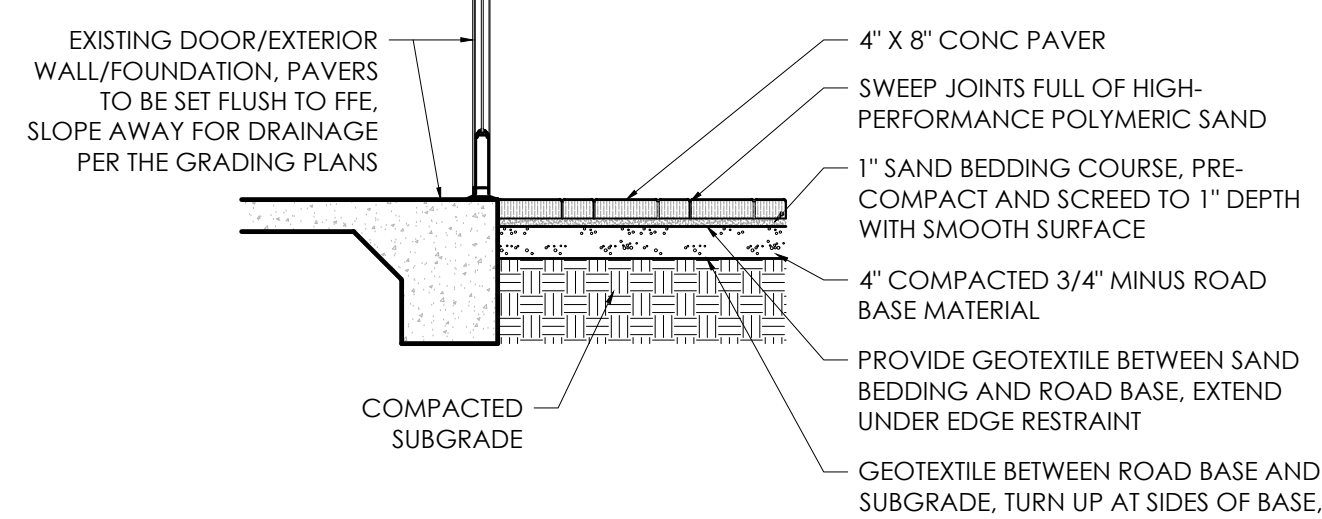


13 PAVERS AGAINST FOUNDATION
 1/2" = 1'-0"

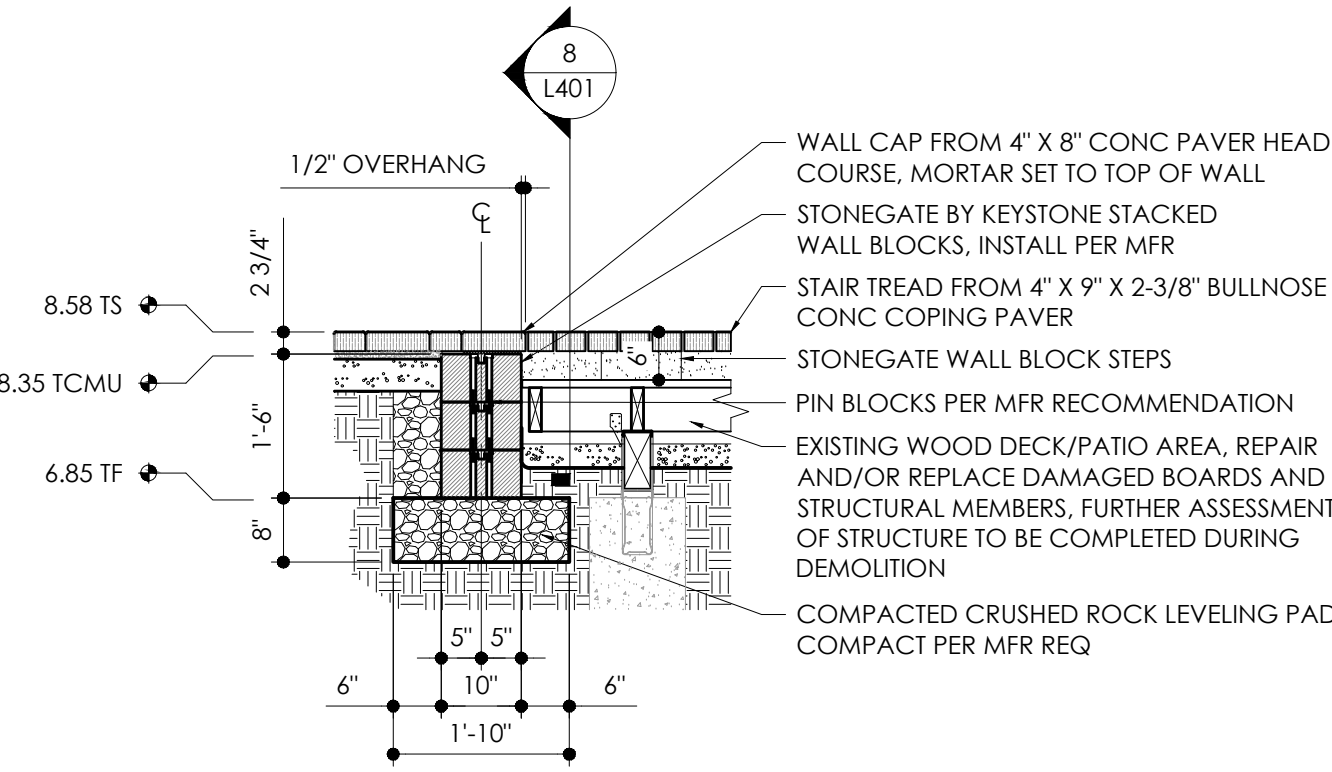


9 RETAINING WALL SECTION
 1/2" = 1'-0"

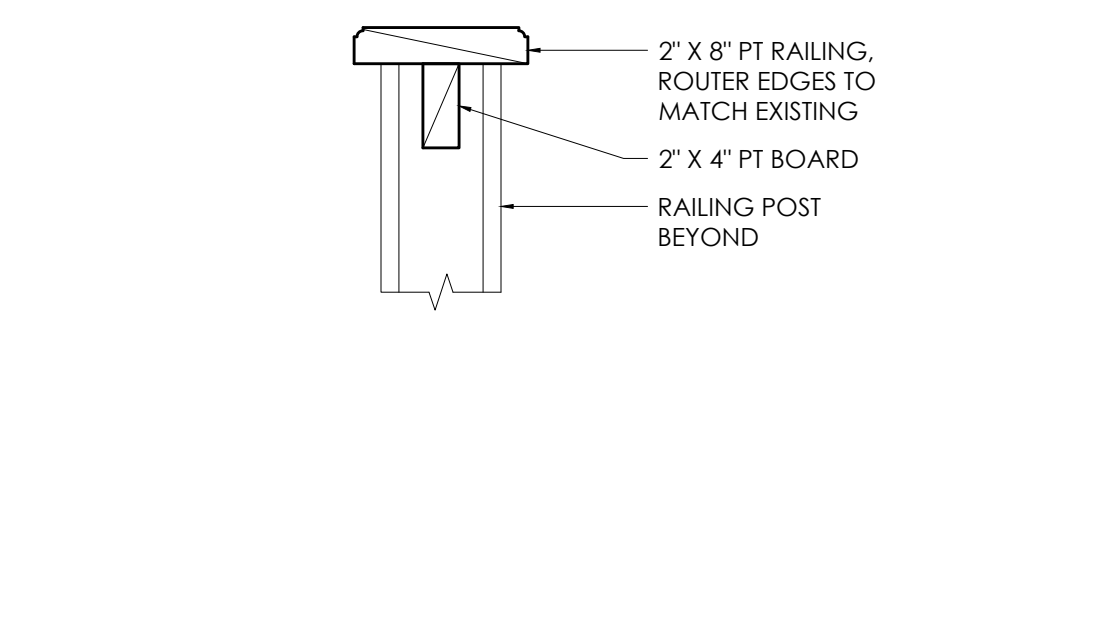


5 WOOD DECK RAILING DETAIL
 1-1/2" = 1'-0"

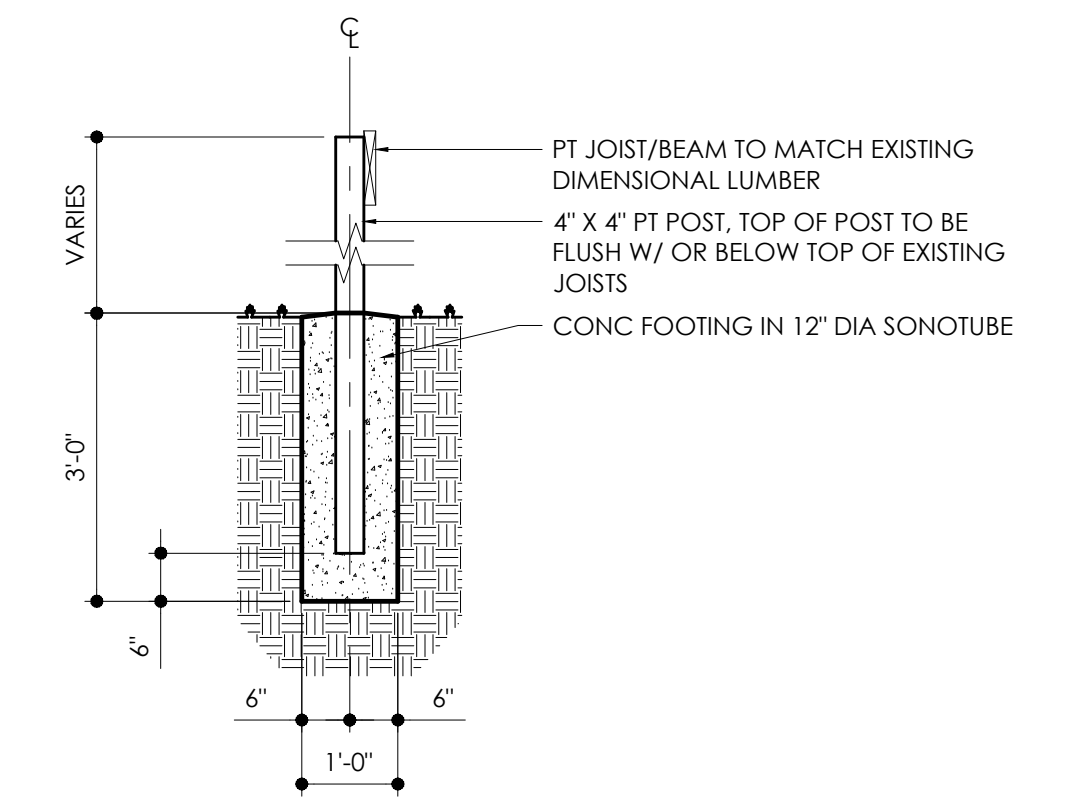


3 WOOD DECK POST DETAIL
 1/2" = 1'-0"

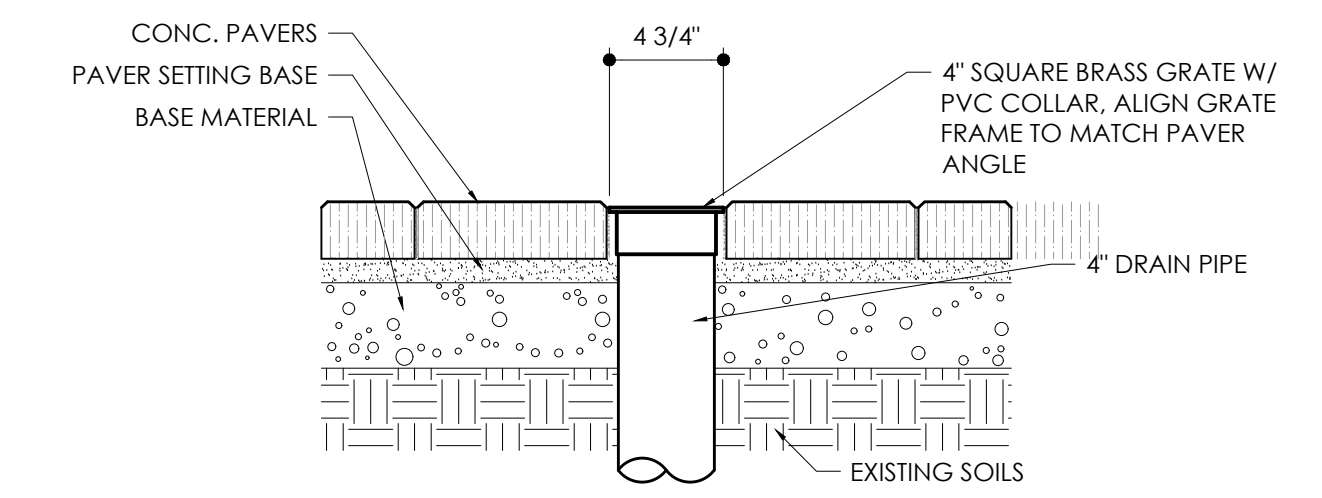


14 PAVER AREA DRAIN INLET
 1-1/2" = 1'-0"

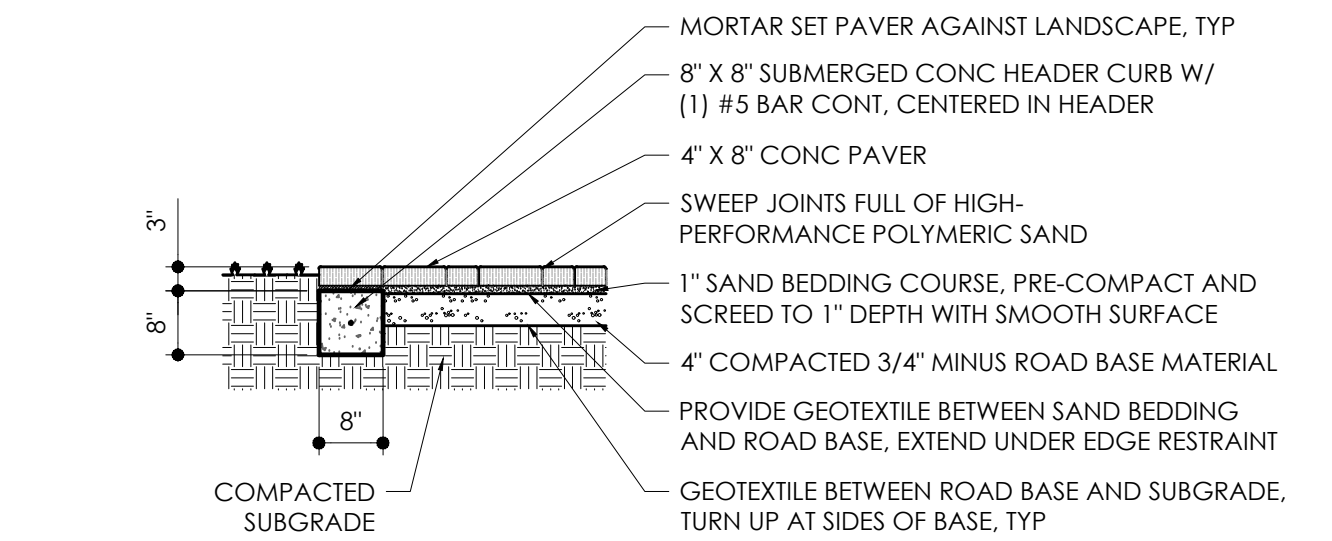

10 PERIMETER PAVER RESTRAINT
 1/2" = 1'-0"

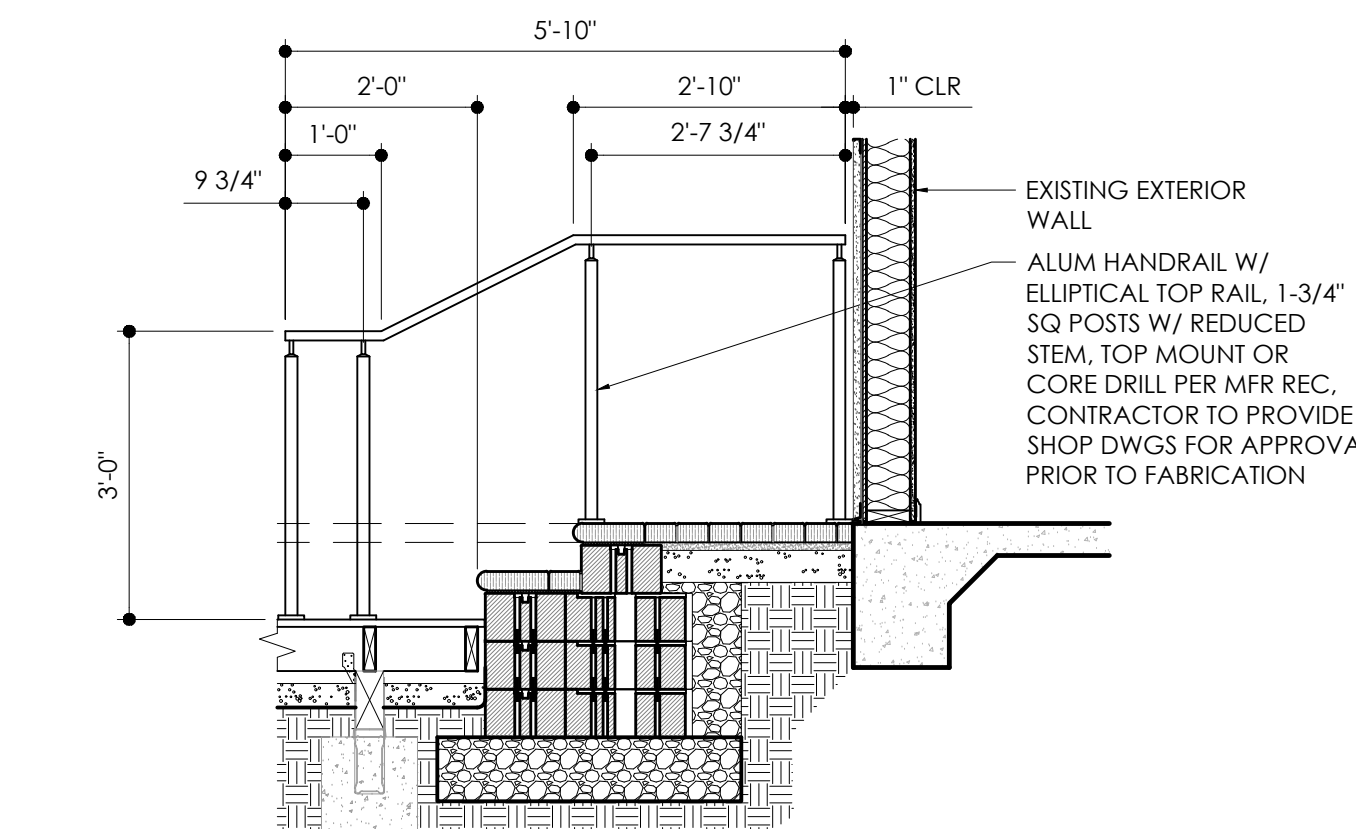

6 HANDRAIL SECTION
 1/2" = 1'-0"

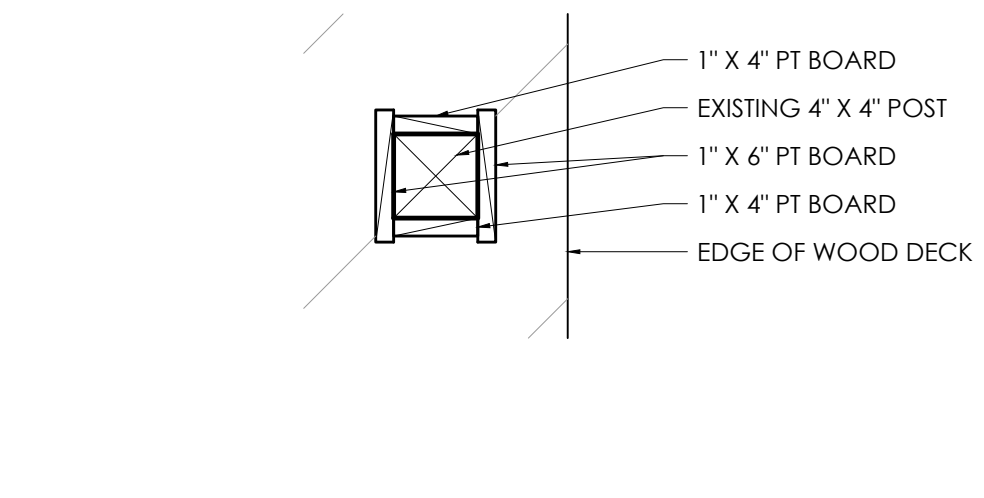

4 WOOD DECK POST TRIM DETAIL
 1-1/2" = 1'-0"




planning
 architecture
 landscape architecture
 urban design
 visual communication

Jacksonville
 ELM Studio
 1301 Riverplace Boulevard
 Suite 1818
 Jacksonville, FL 32207
 t 904 296 8066

elmplan.com

AA26000604 - LC26000209

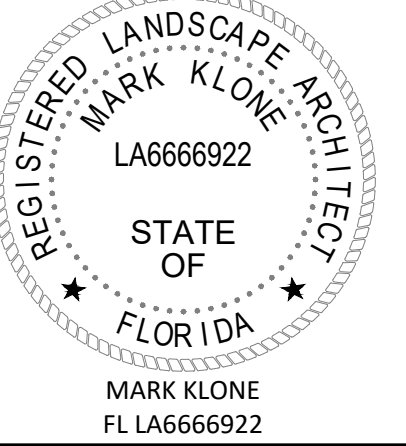

GOLF CLUB OUTDOOR BAR
 PONTE VEDRA INN & CLUB
 PONTE VEDRA BEACH, ST. JOHNS COUNTY, FLORIDA

ISSUE DATES

NO.	DESCRIPTION	DATE

THIS DRAWING IS AN INSTRUMENT OF SERVICE AND THE PROPERTY OF ELM, INC. AND SHALL REMAIN THEIR PROPERTY. THE USE OF THIS DRAWING SHALL BE RESTRICTED TO THE ORIGINAL SITE FOR WHICH IT IS PREPARED, AND PUBLICATION THEREOF IS EXPRESSLY LIMITED TO SUCH USE.

PROJ. #:	22-44
DATE:	12.22.2023
DRAWN BY:	MCK
CHECKED BY:	MCK
SCALE:	AS NOTED

HARDSCAPE DETAILS**SHEET NUMBER**

L401
 Project Status

ISSUE DATES

NO.	DESCRIPTION	DATE
1	AS-BUILT	24.02.26

THIS DRAWING IS AN INSTRUMENT OF SERVICE AND THE PROPERTY OF ELM, INC. AND SHALL REMAIN THEIR PROPERTY. THE USE OF THIS DRAWING SHALL BE RESTRICTED TO THE ORIGINAL SITE FOR WHICH IT IS PREPARED, AND PUBLICATION THEREOF IS EXPRESSLY LIMITED TO SUCH USE.


PROJ. #: 22-44
DATE: 12.22.2023
DRAWN BY: MCK
CHECKED BY: MCK
SCALE: AS NOTED

HARDSCAPE DETAILS


SHEET NUMBER

L402

Project Status

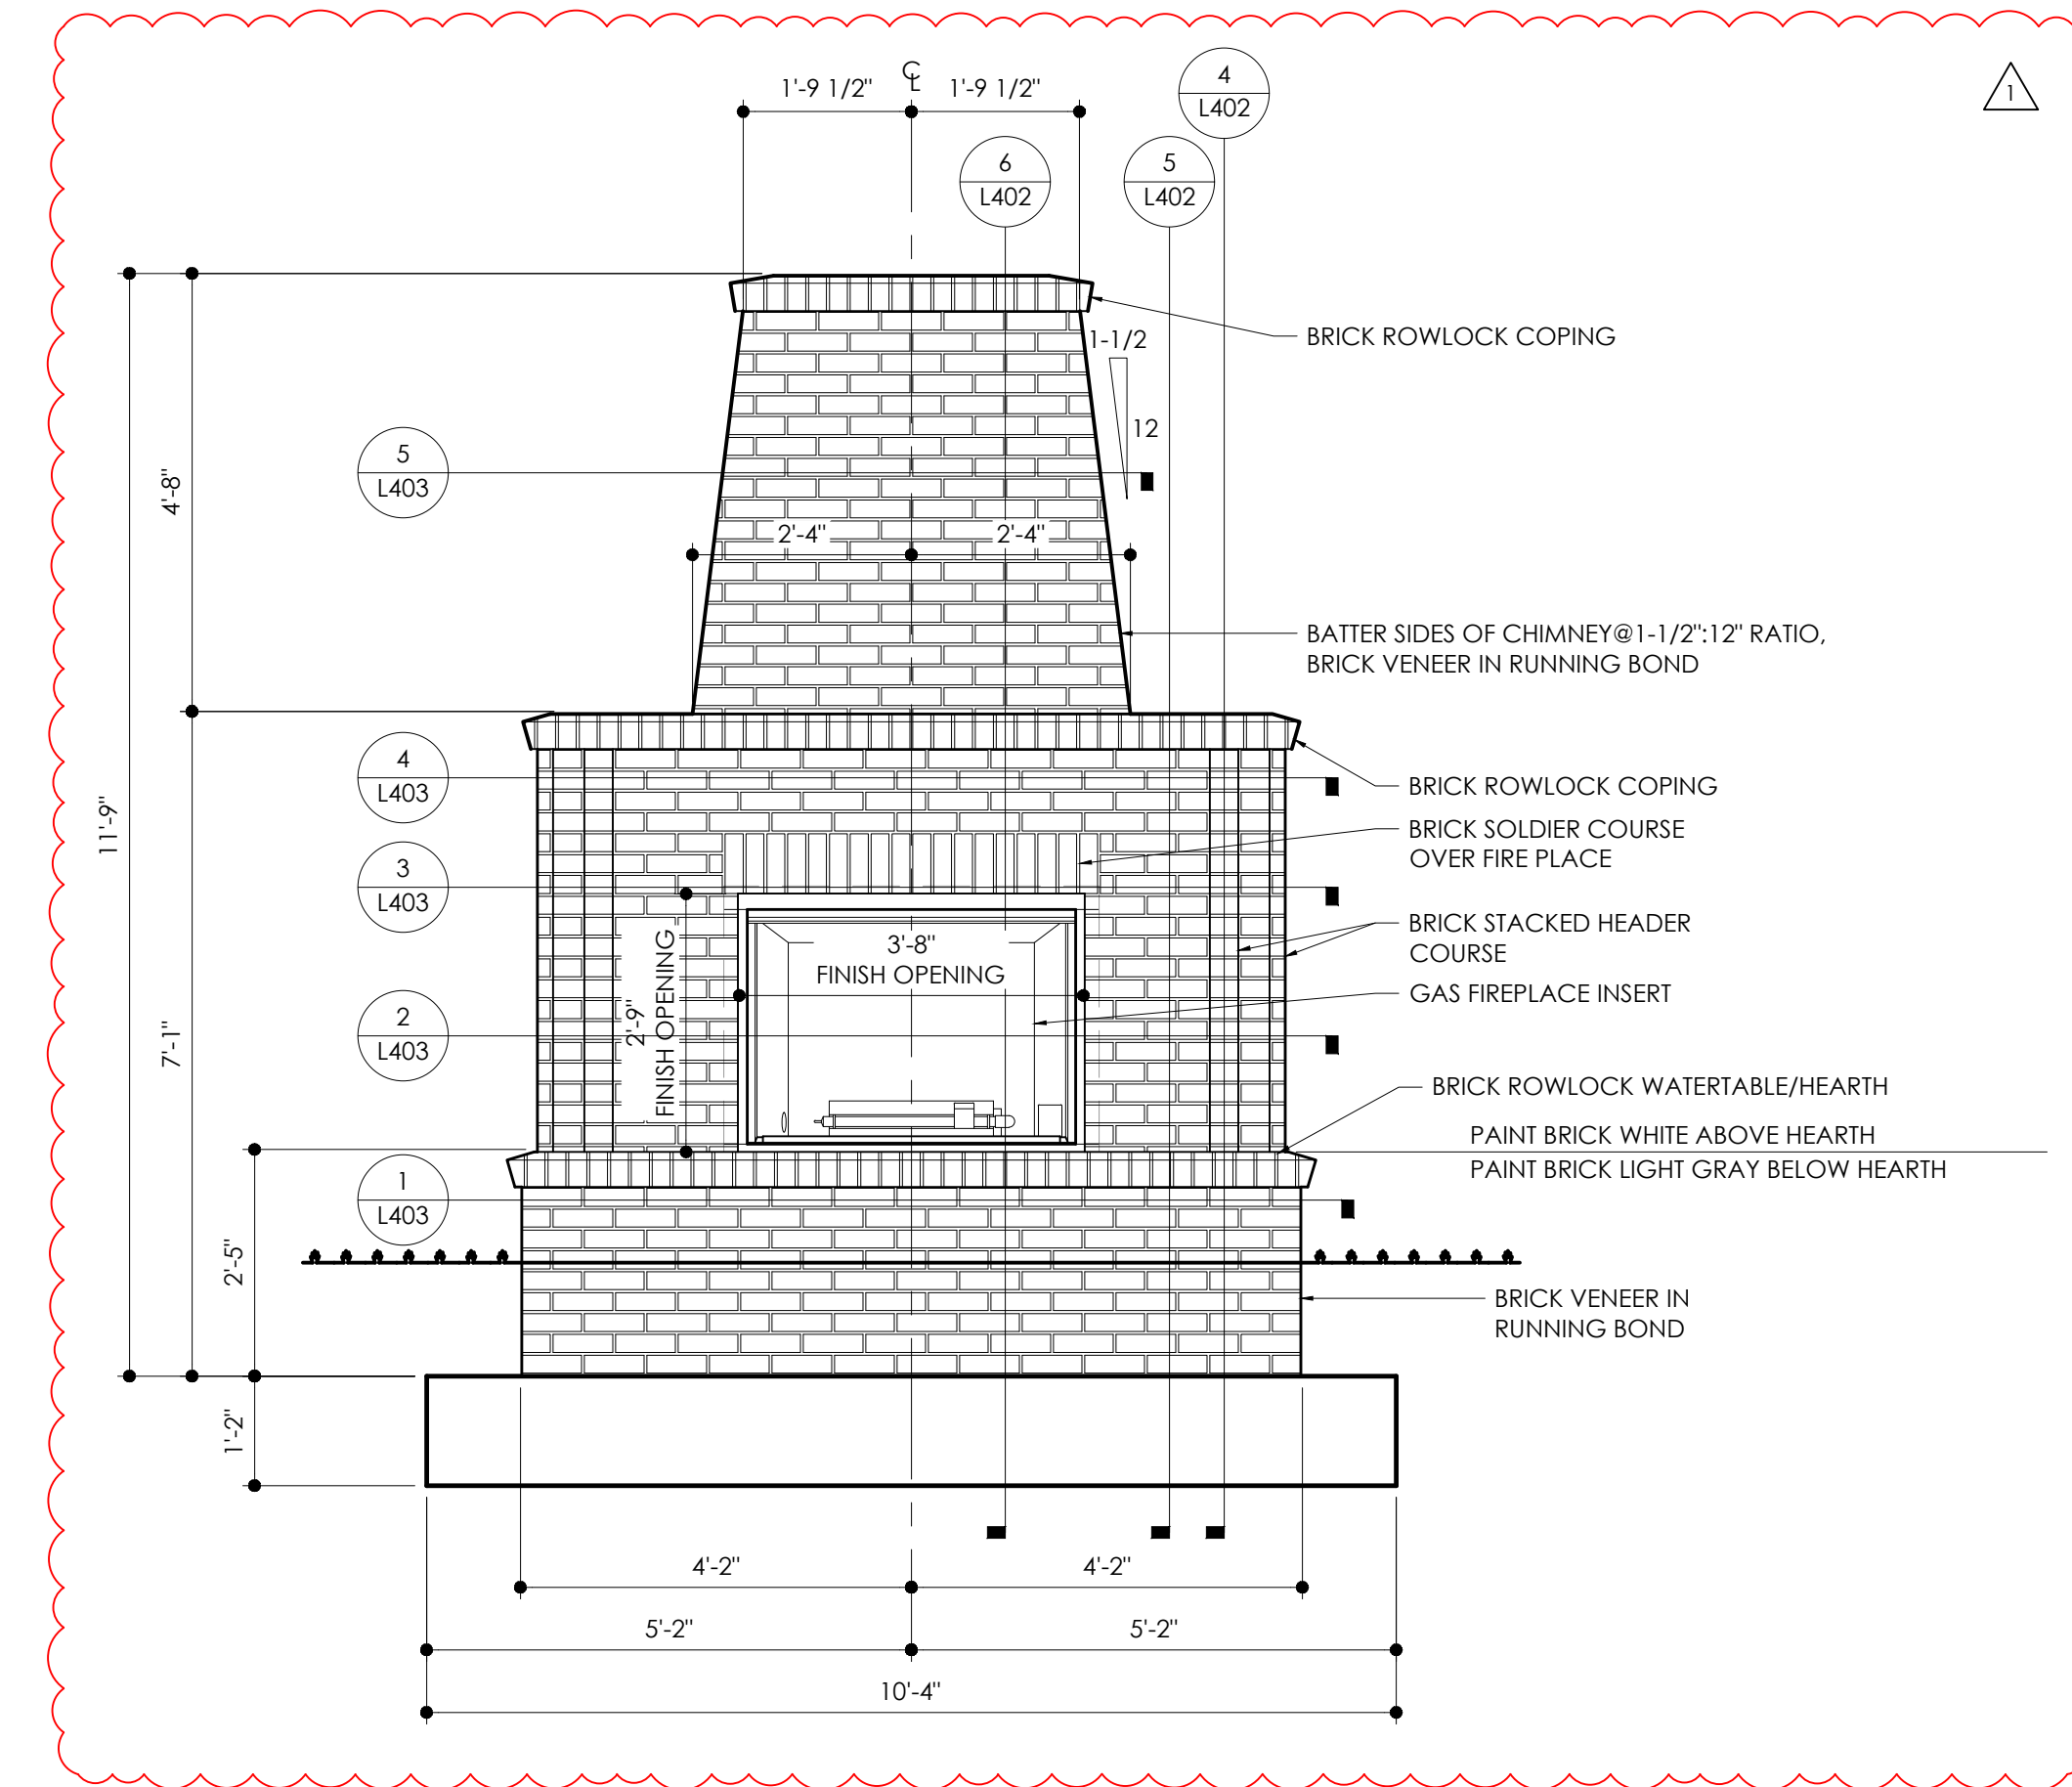


1 FIREPLACE - FRONT ELEVATION
1/2" = 1'-0"

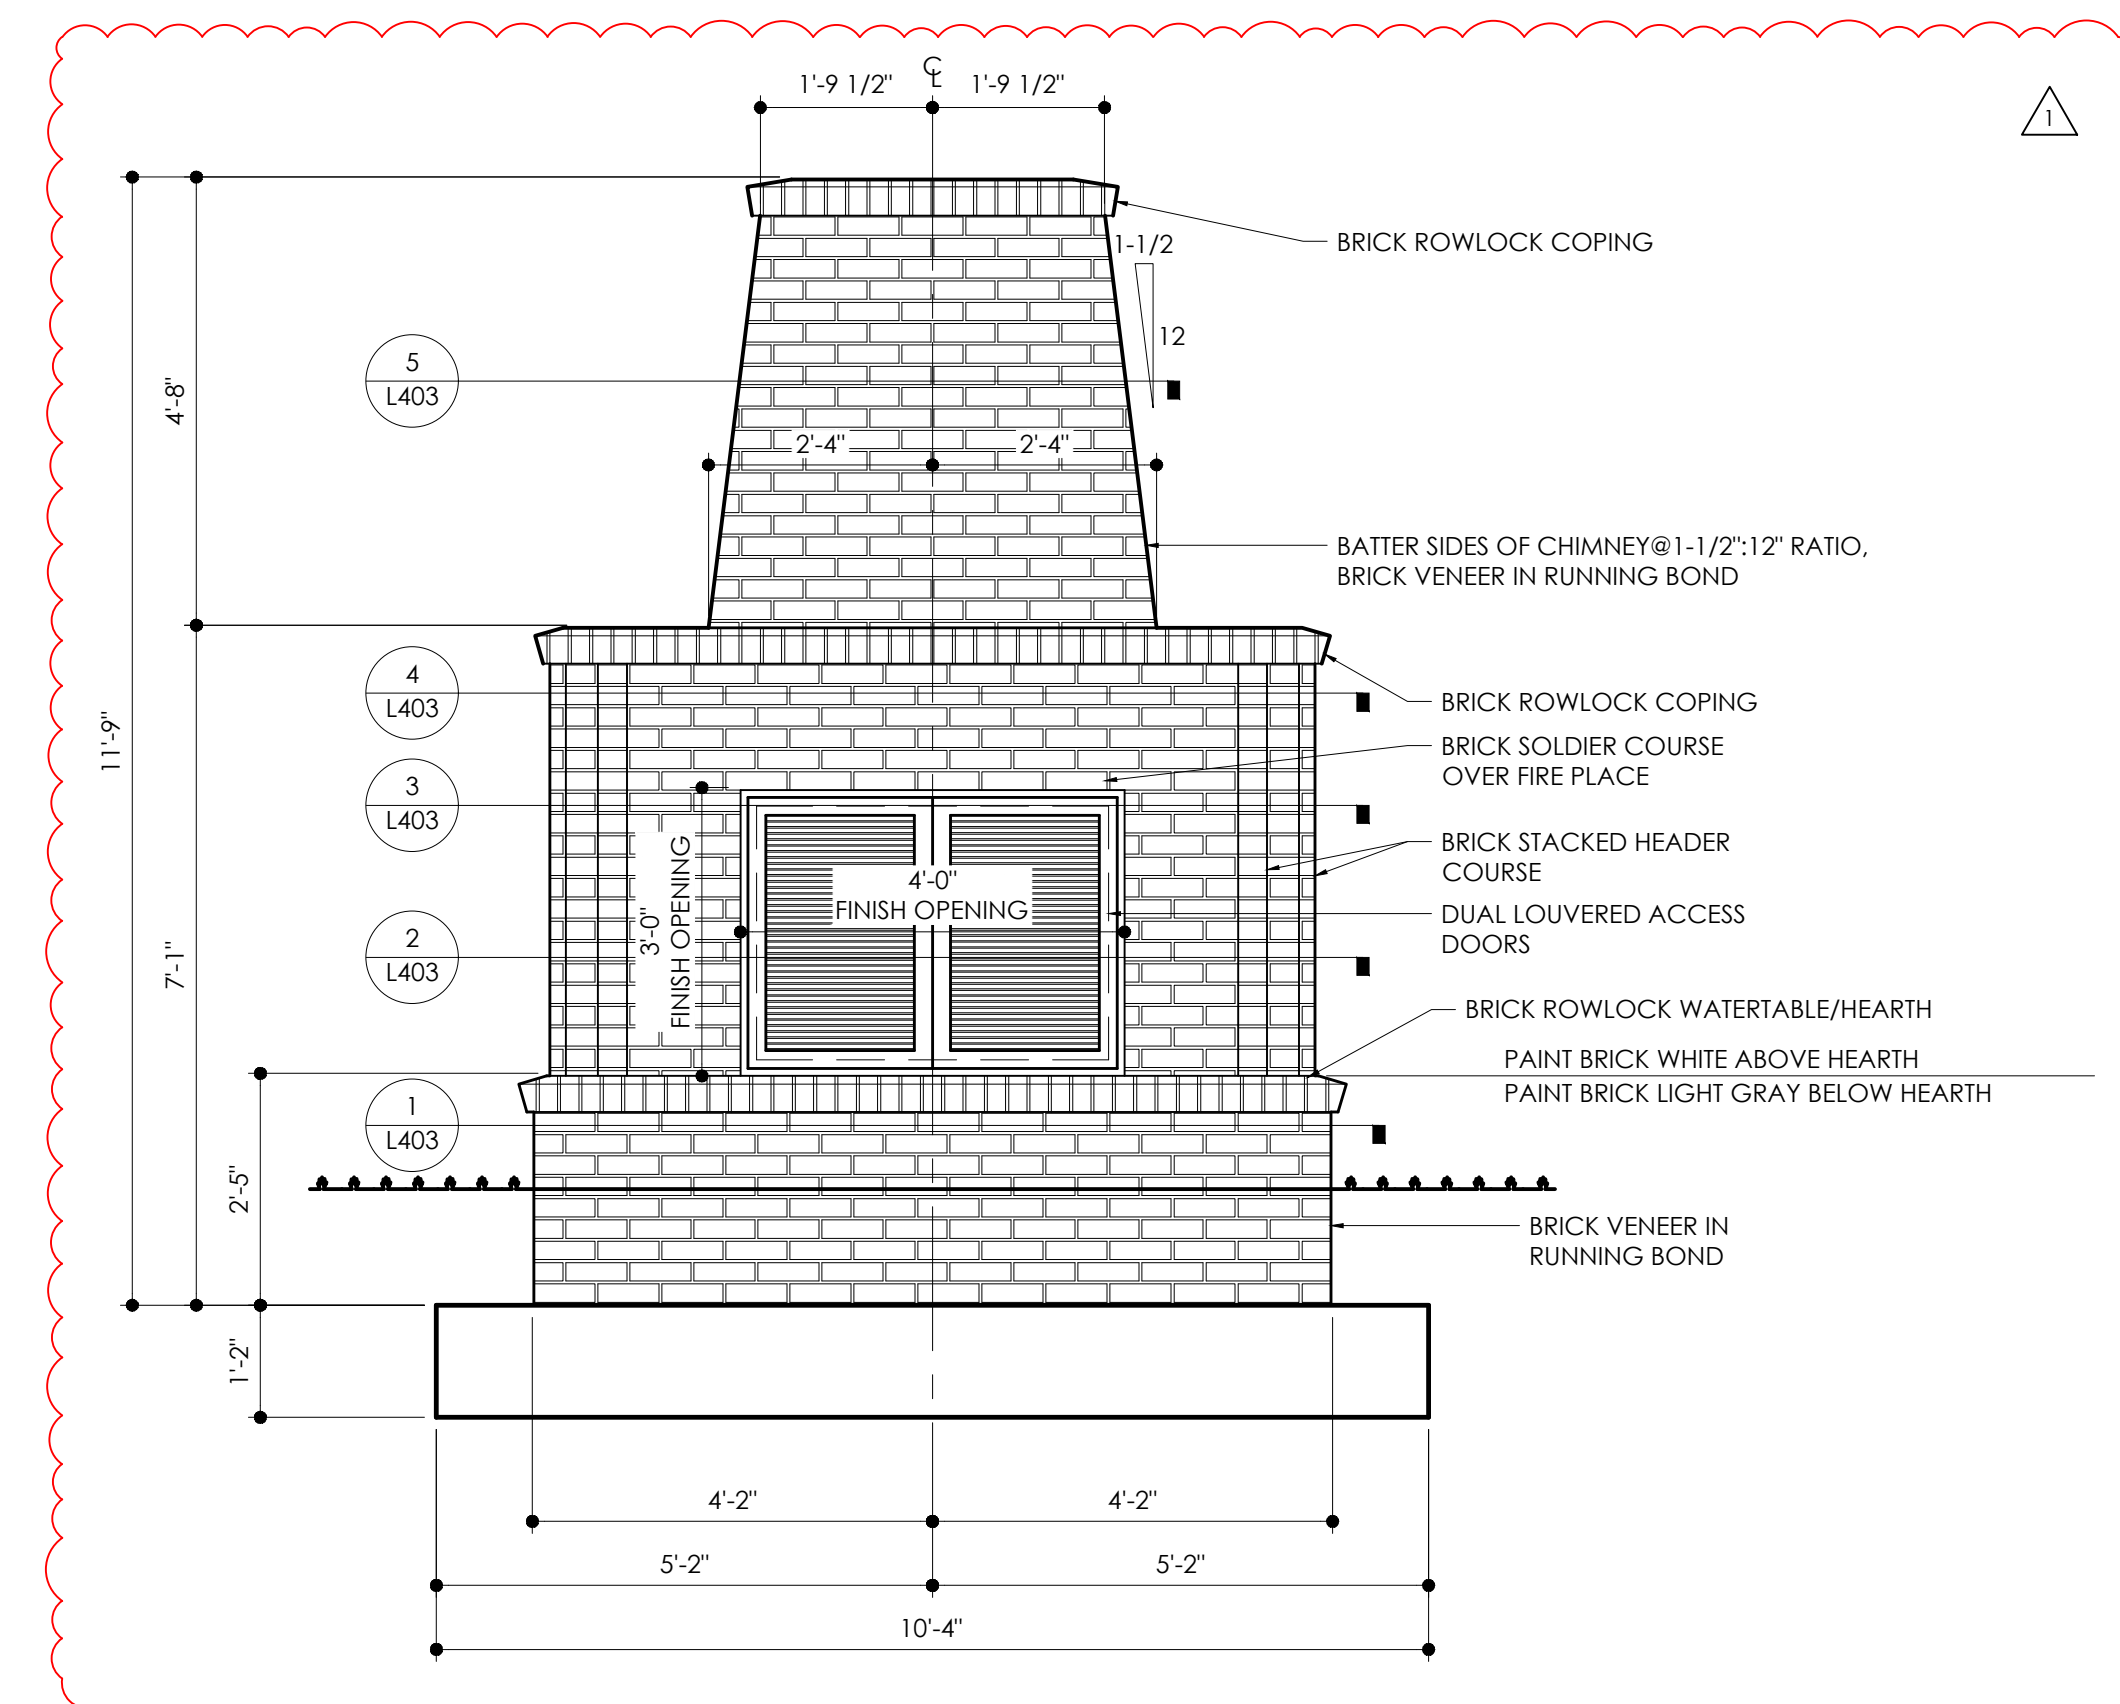


2 FIREPLACE - REAR ELEVATION
1/2" = 1'-0"

DETAIL REMOVED FROM THE SET


3 FIREPLACE - WING WALL SECTION
1/2" = 1'-0"

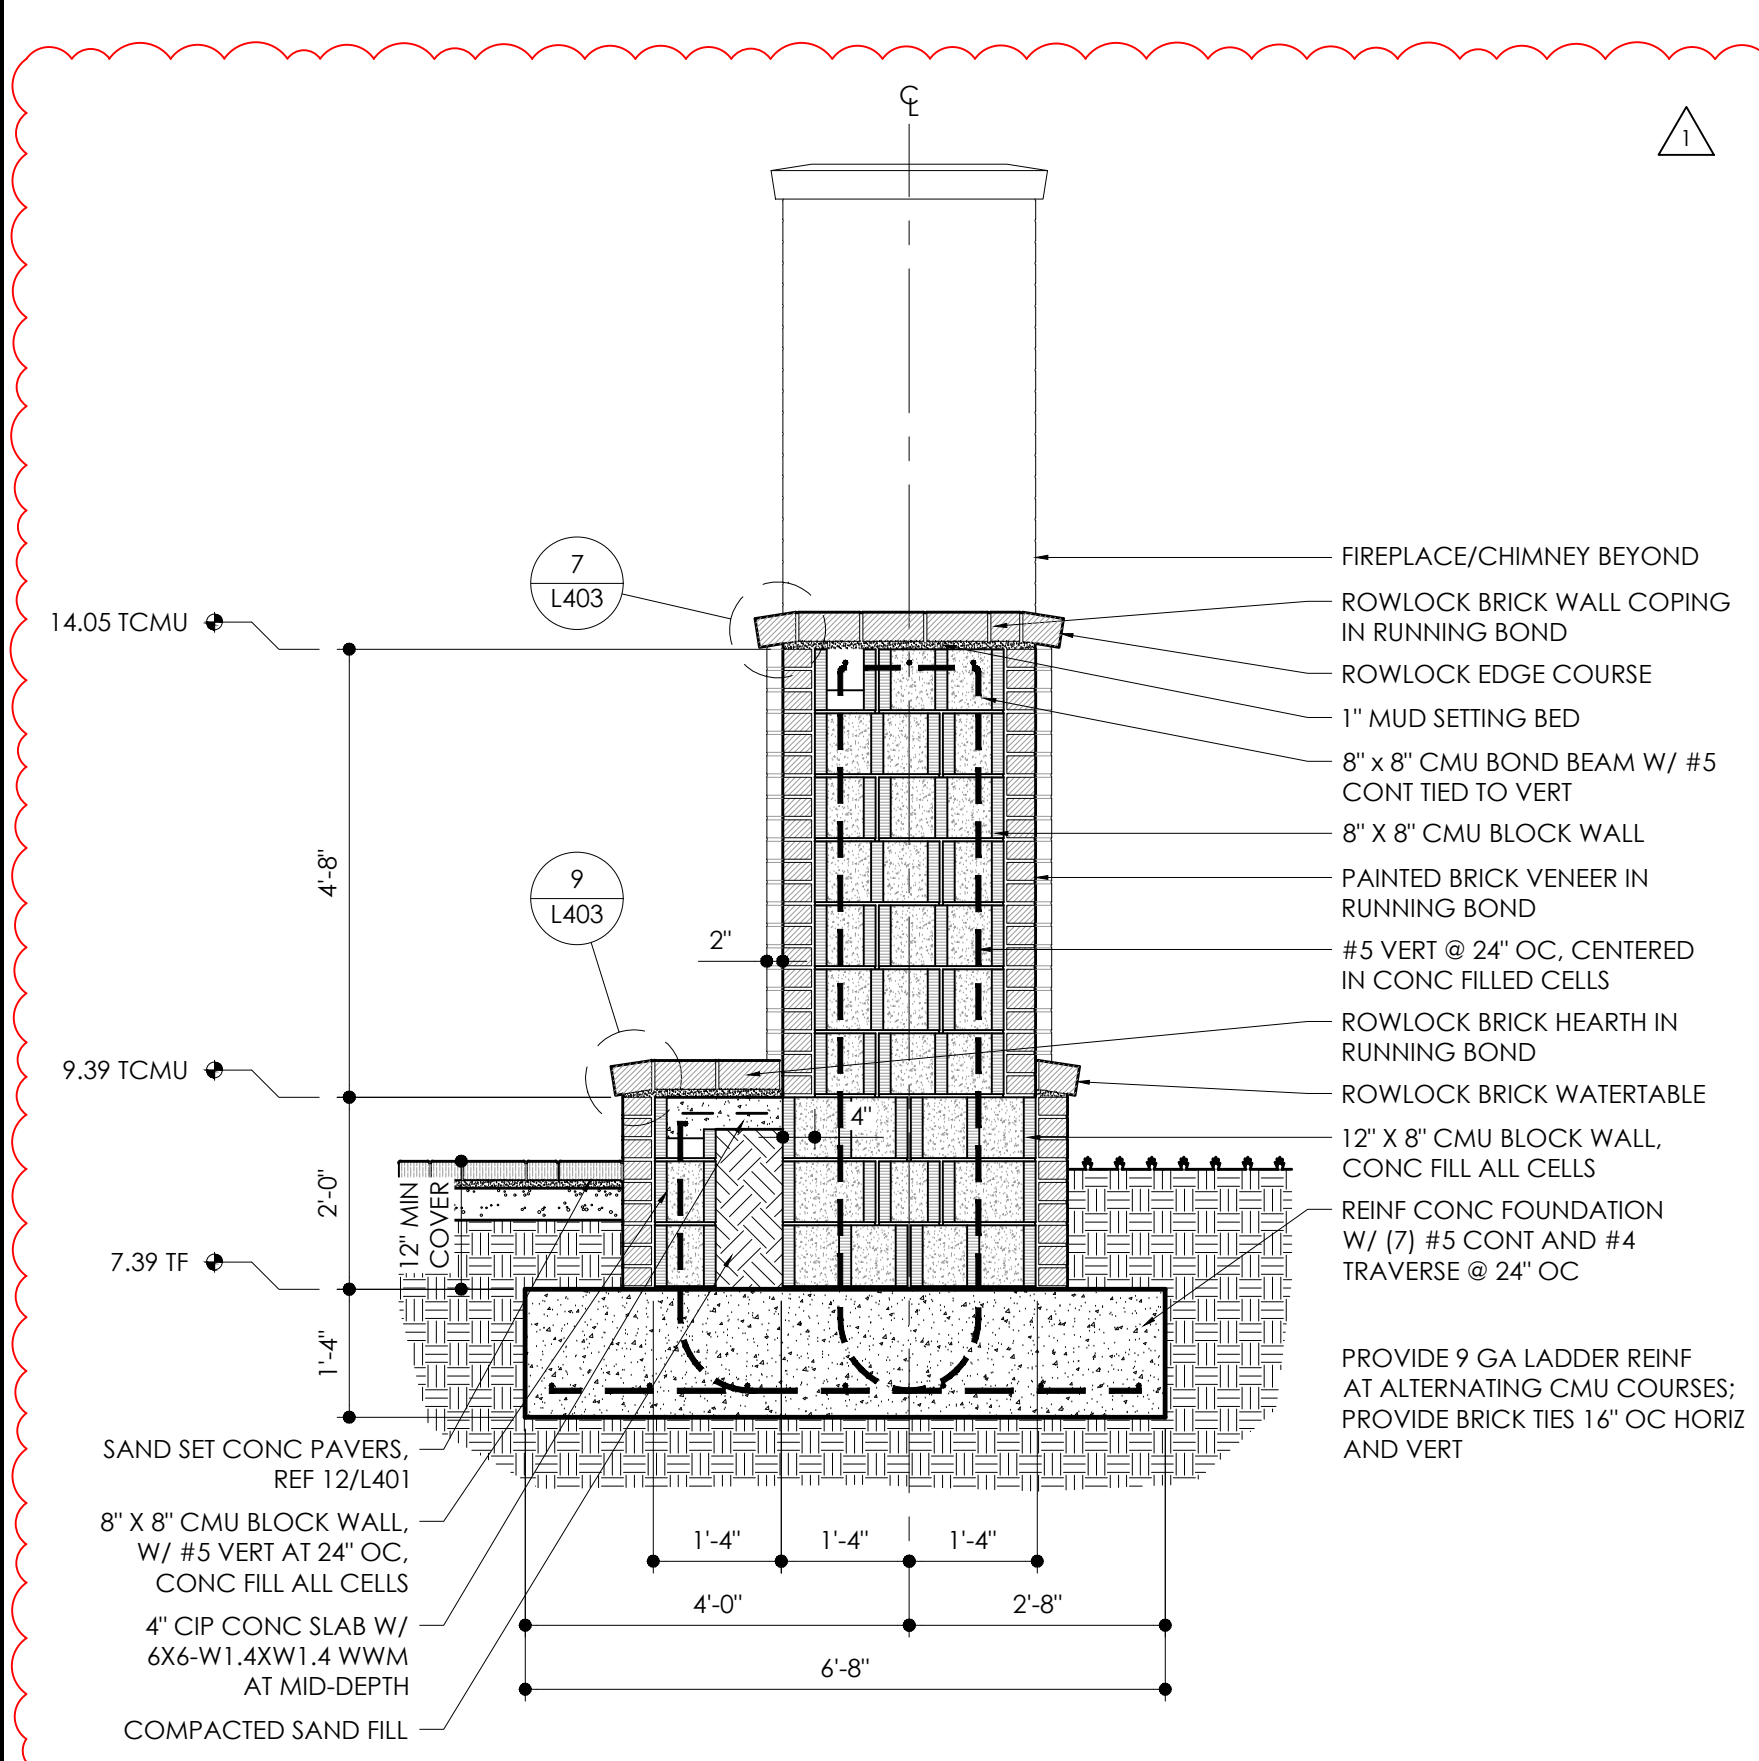




4 FIREPLACE - COLUMN SECTION
1/2" = 1'-0"

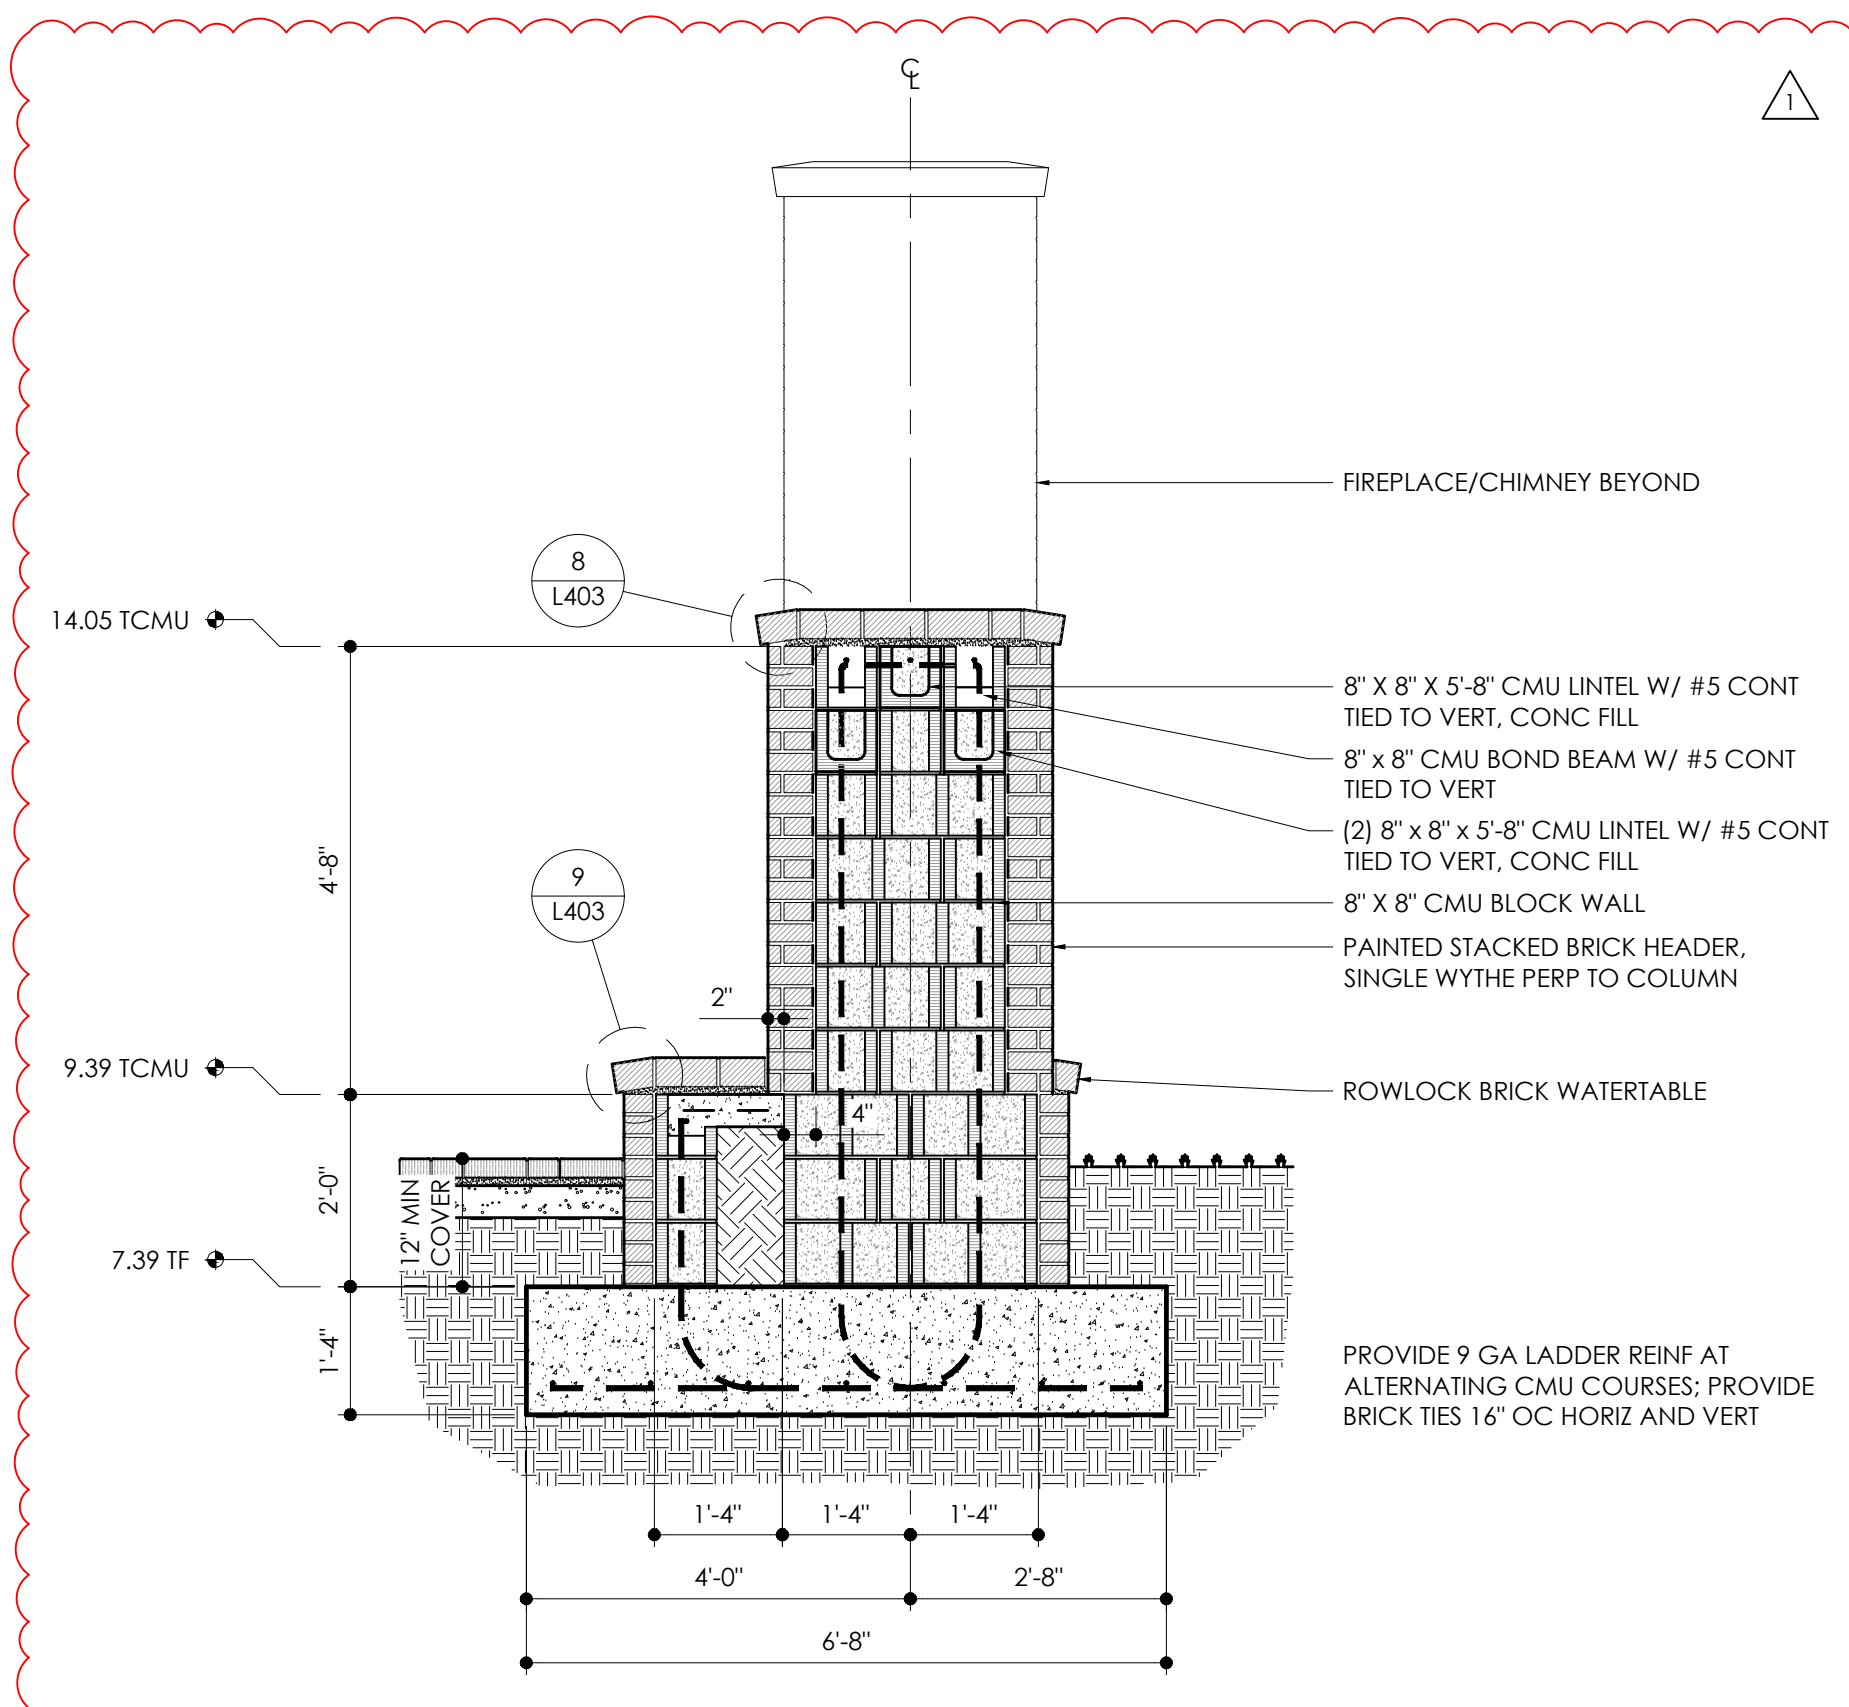

5 FIREPLACE - LINTEL BEARING SECTION
1/2" = 1'-0"

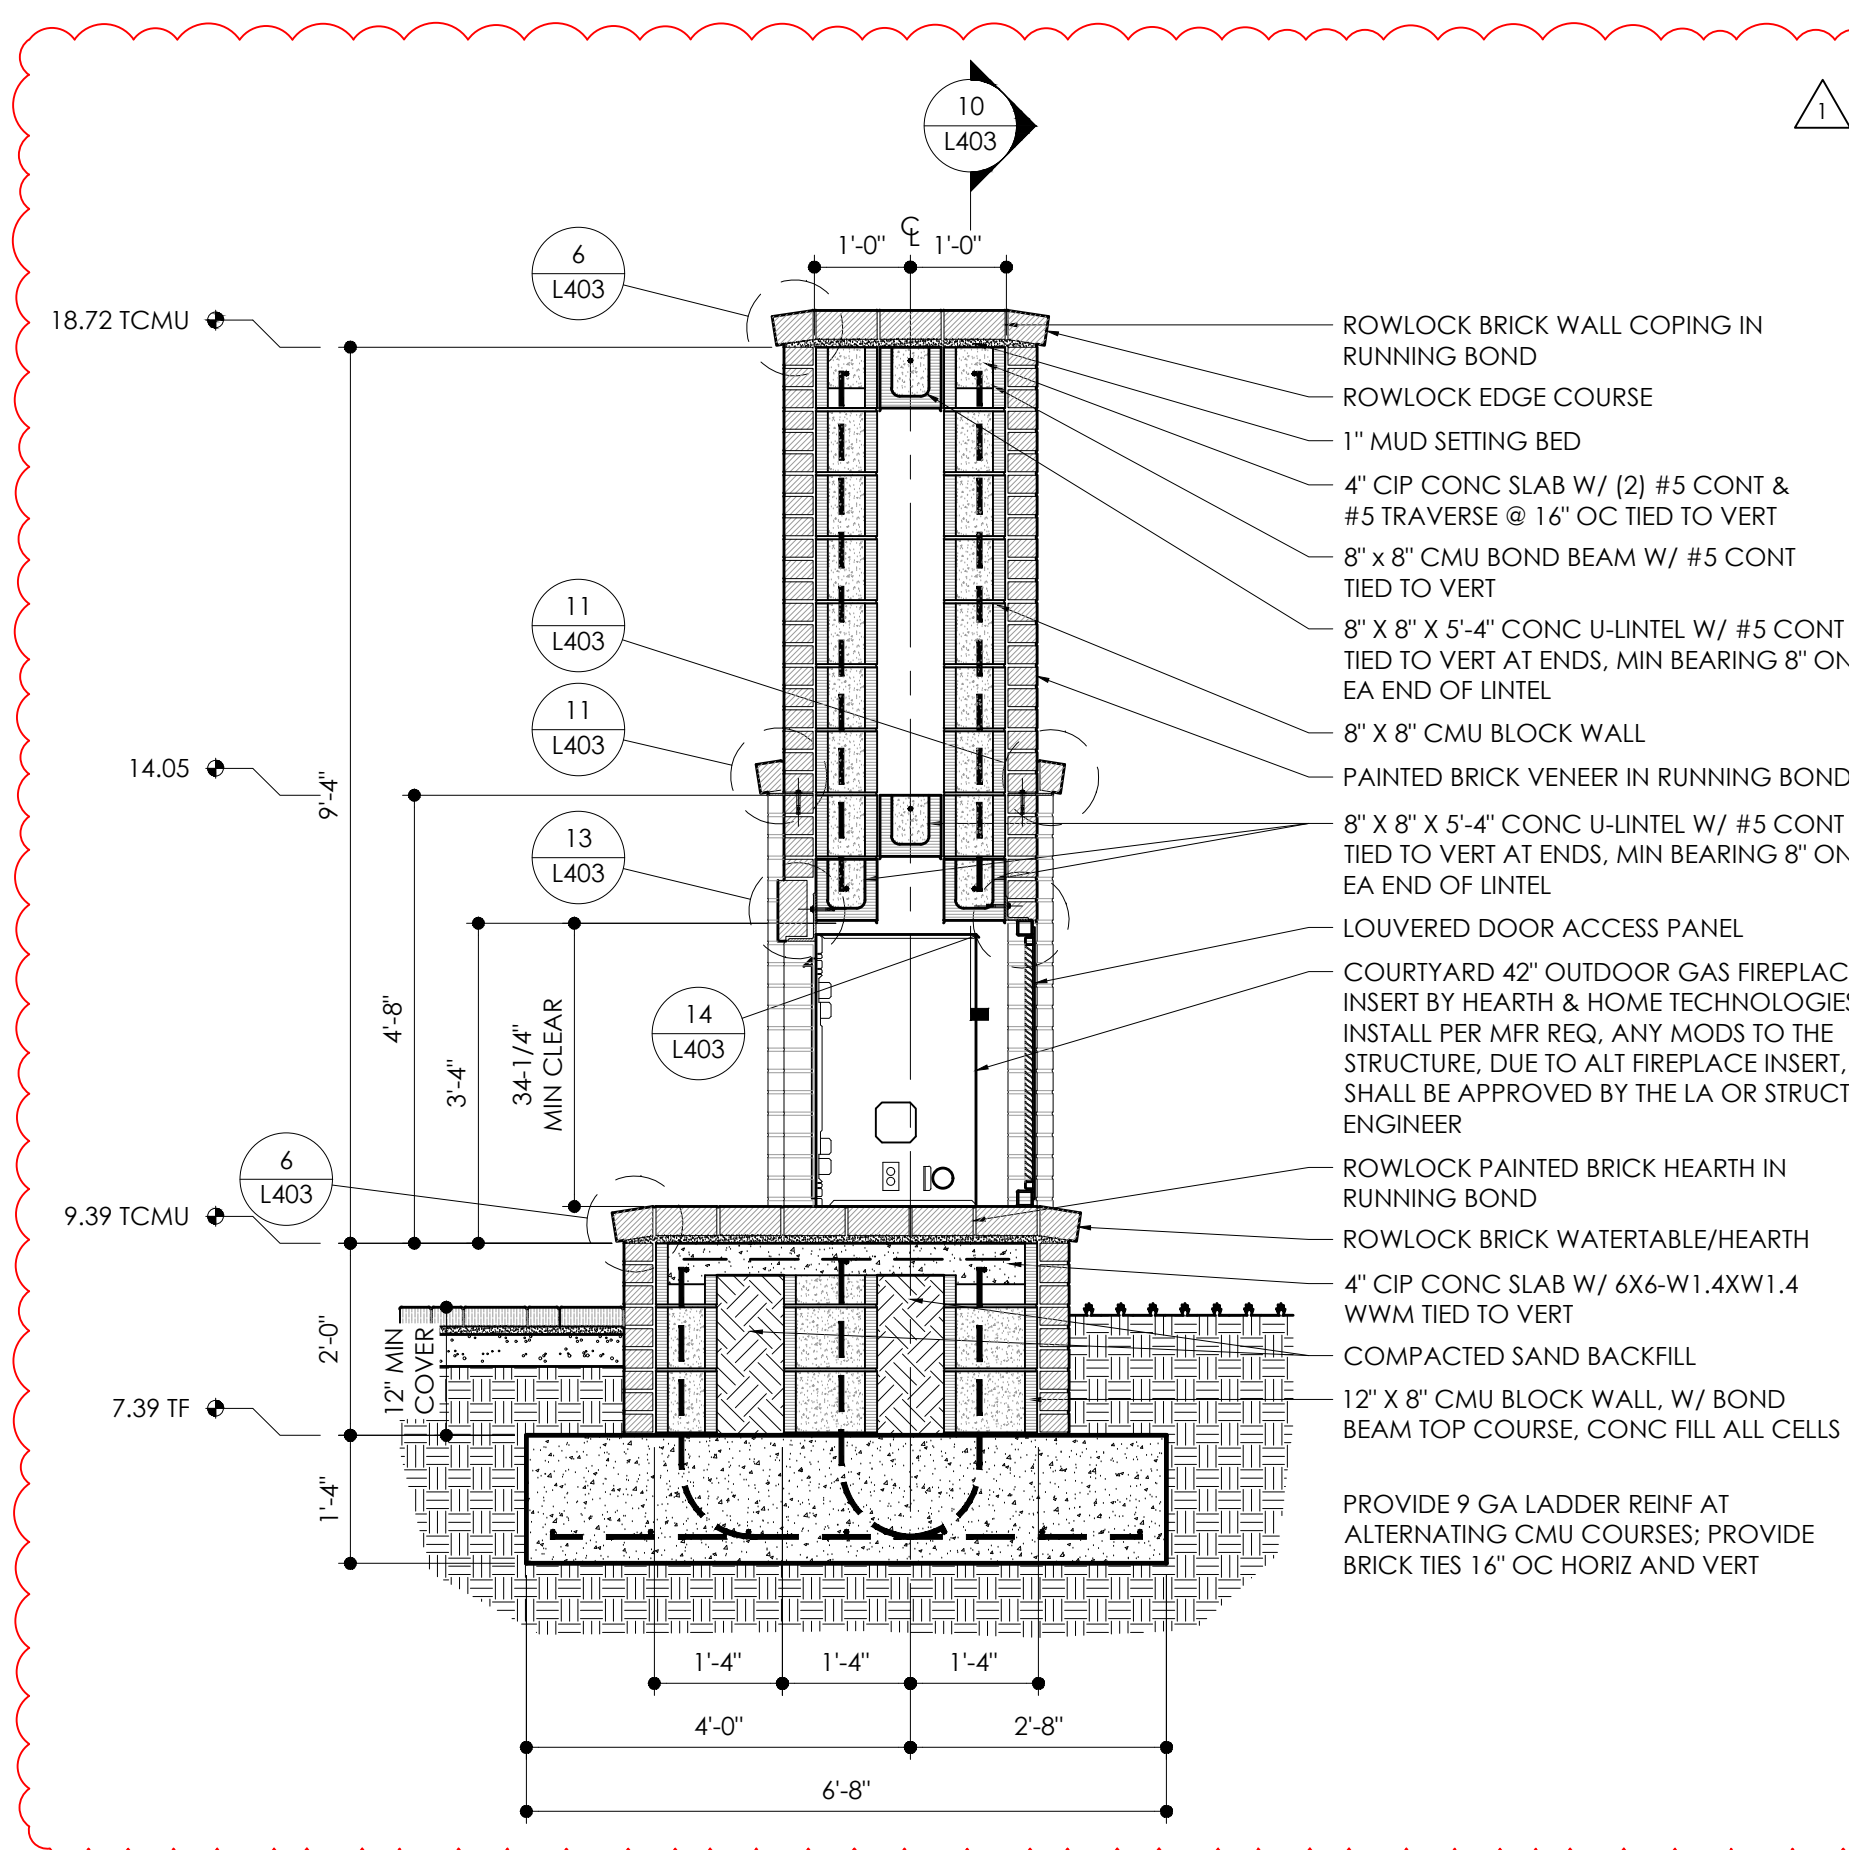

6 FIREPLACE - FIREPLACE INSERT SECTION
1/2" = 1'-0"

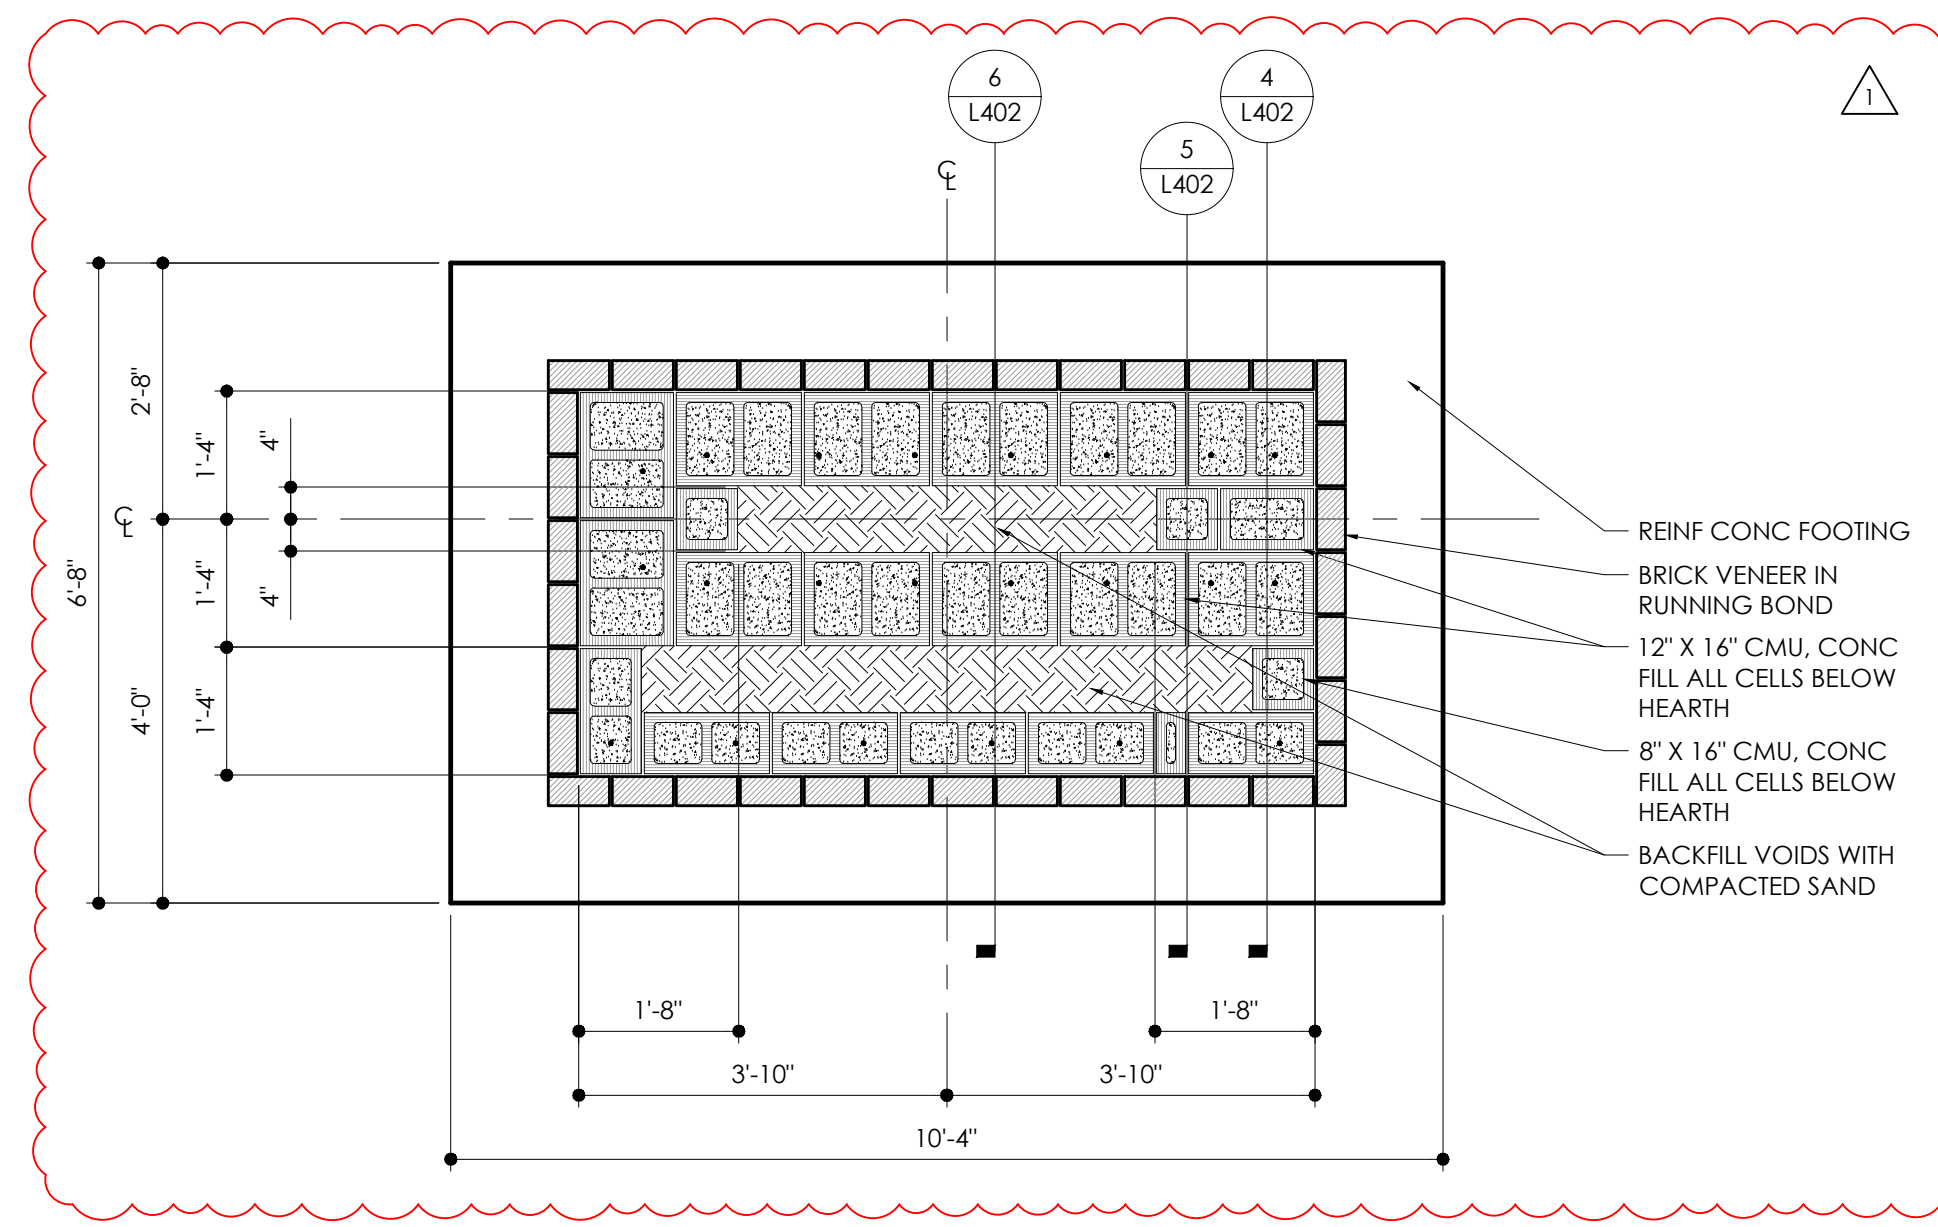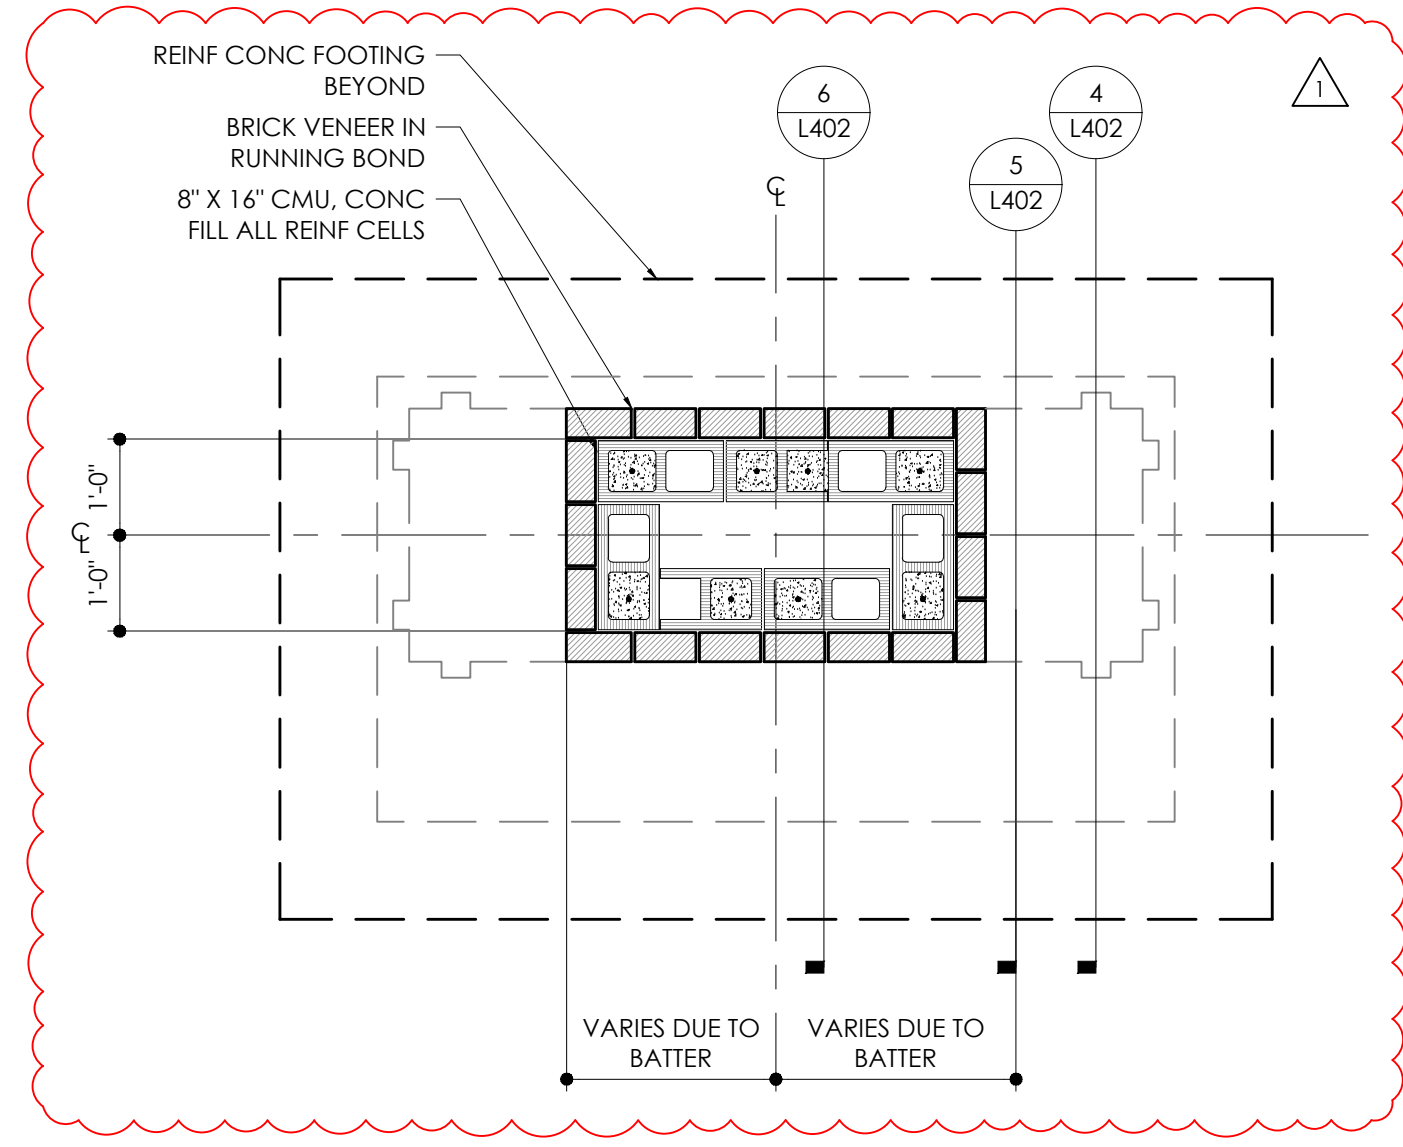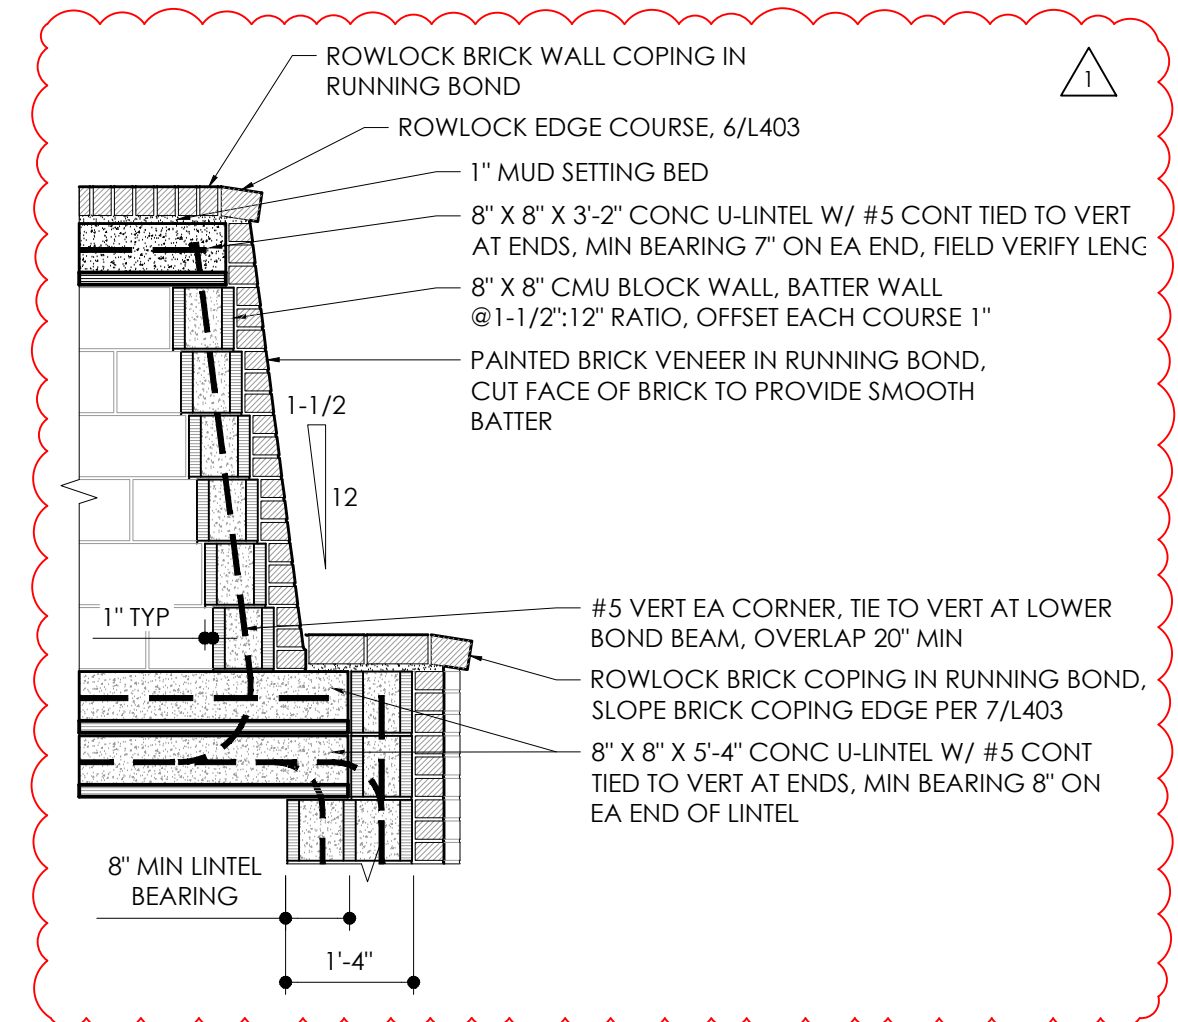

elm

planning
architecture
landscape architecture
urban design
visual communication

Jacksonville
ELM Studio
1301 Riverplace Boulevard
Suite 1818
Jacksonville, FL 32207
t 904 296 8066



elmpian.com
AA26000604 - LC260000209
REGISTERED LANDSCAPE ARCHITECT
MARK KLONE
LA6666922
STATE OF
FLORIDA
MARK KLONE
FL LA6666922

10 FIREPLACE - WALL BATTER SECTION
1/2" = 1'-0"

5 FIREPLACE - PLAN VIEW SECTION THROUGH CHIMNEY
1/2" = 1'-0"

1 FIREPLACE - PLAN VIEW OF FOUNDATION AND BELOW HEARTH WALL SECTION
1/2" = 1'-0"




DETAIL REMOVED FROM THE SET

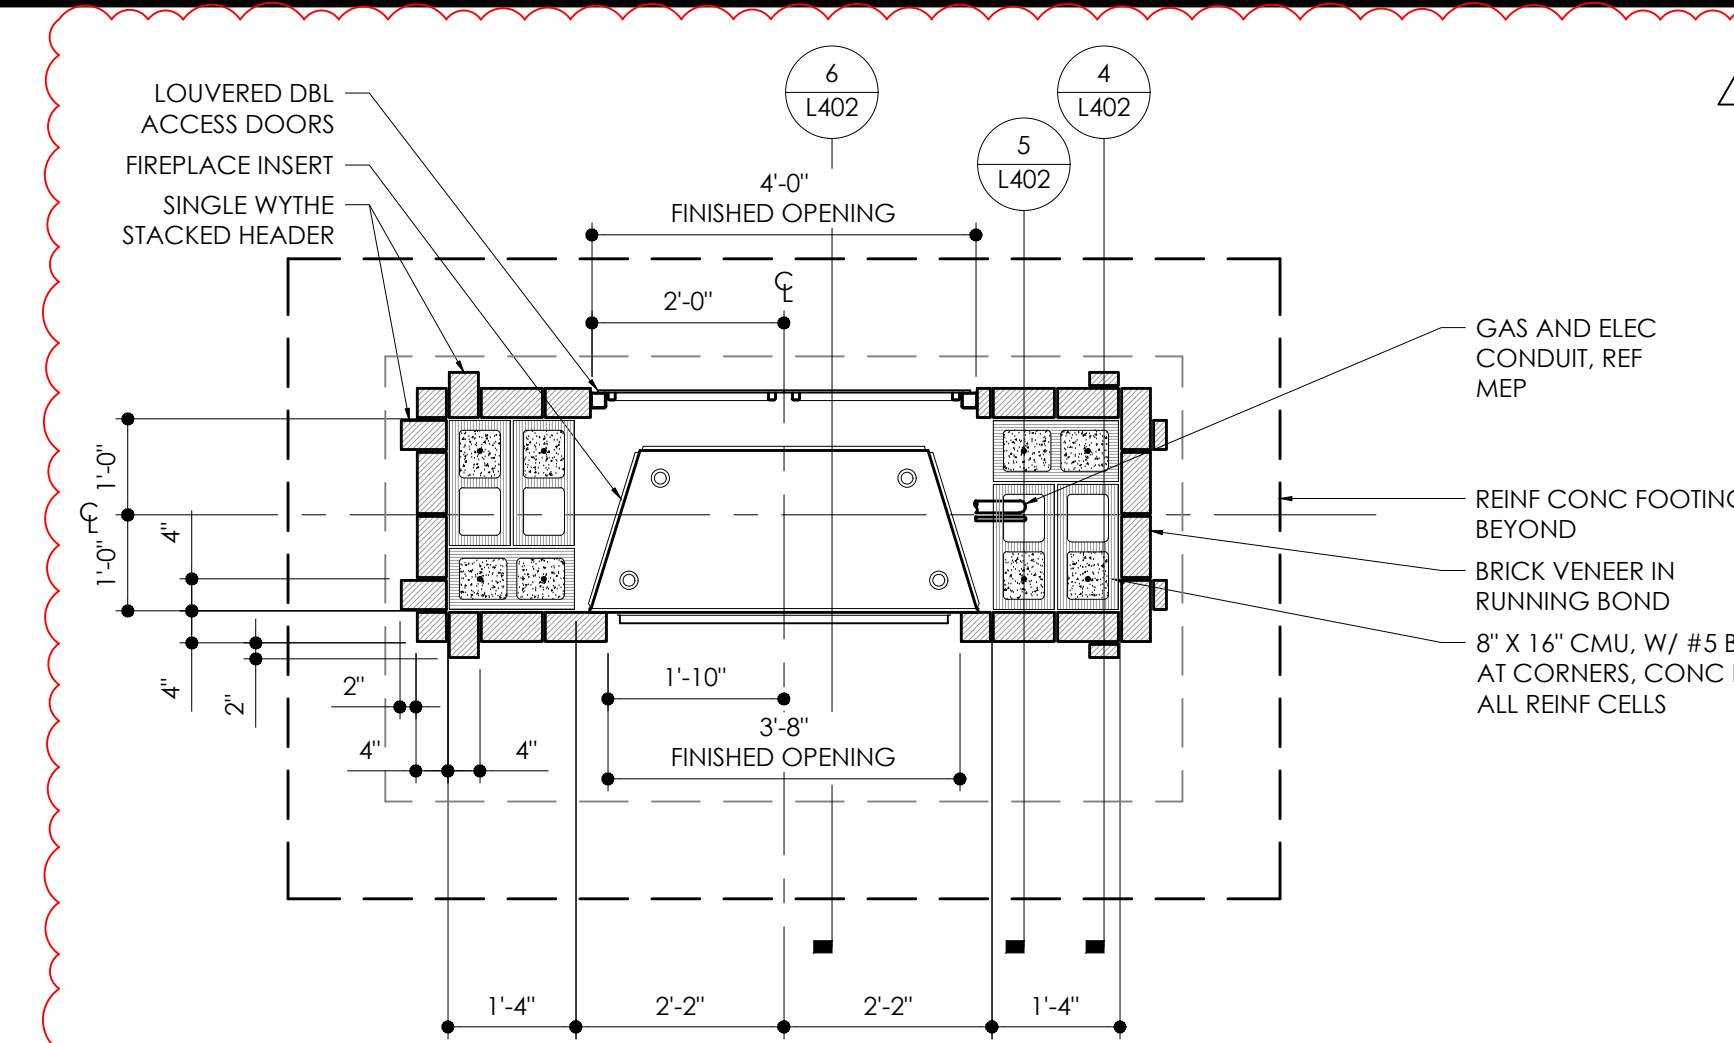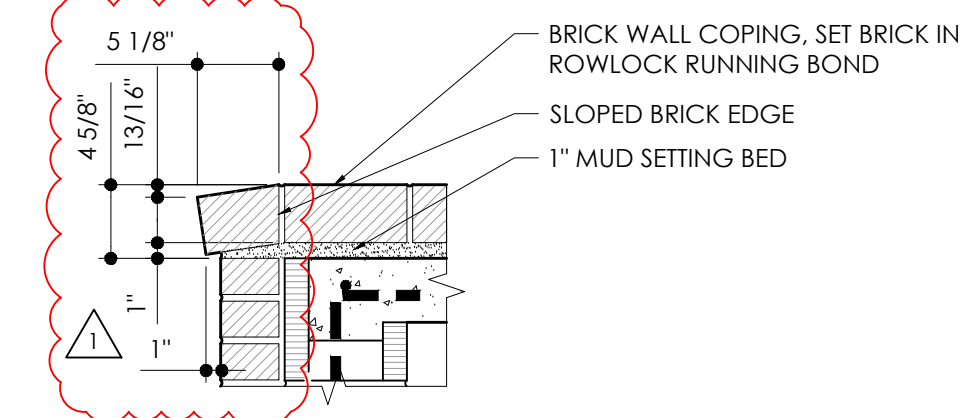

11 FIREPLACE - MANTLE WATERTABLE DETAIL
1" = 1'-0"

6 FIREPLACE - TYPICAL WALL COPING DETAIL
1" = 1'-0"




2 FIREPLACE - PLAN VIEW WALL SECTION THROUGH FIRE INSERT OPENING
1/2" = 1'-0"

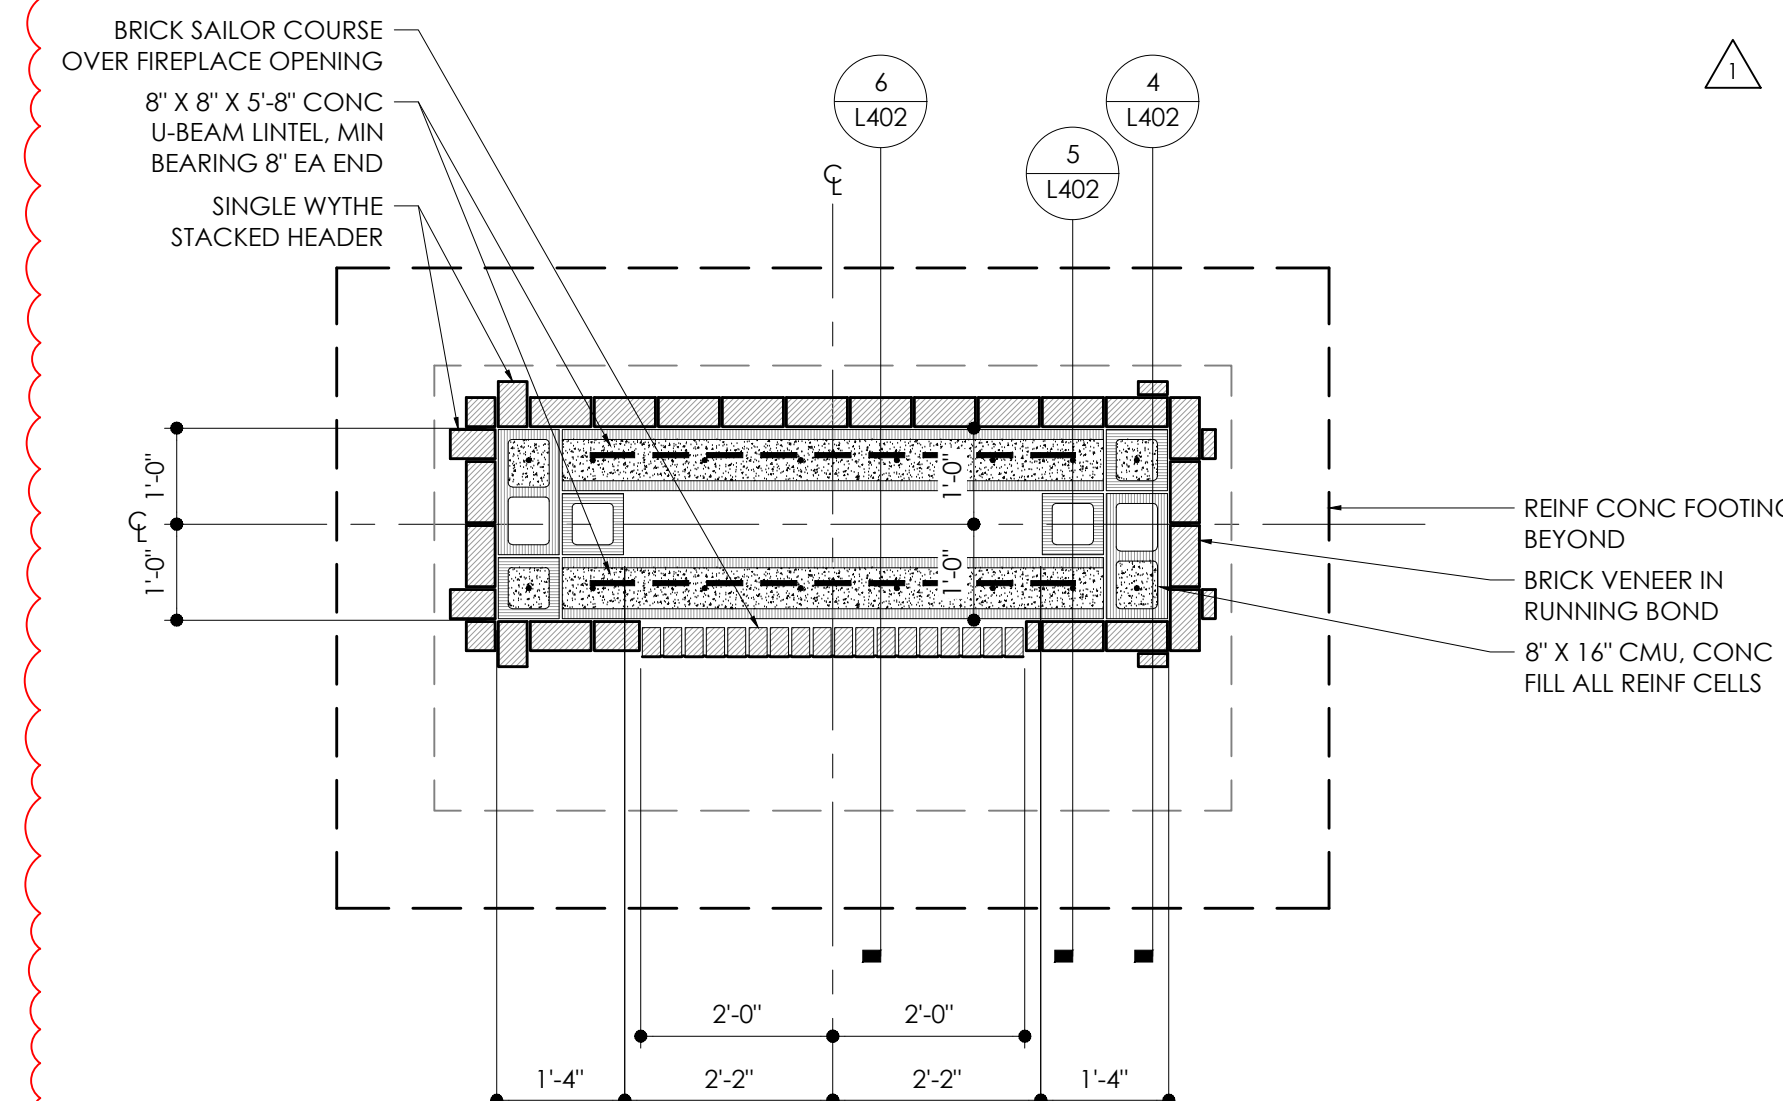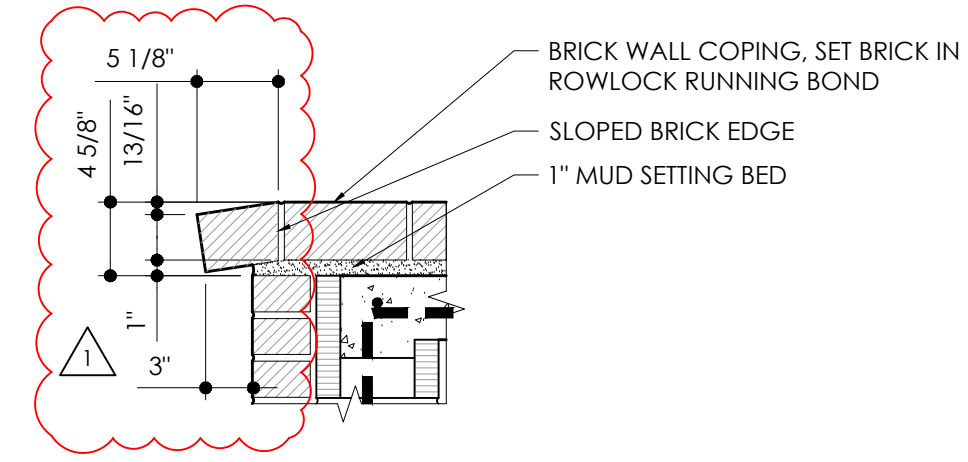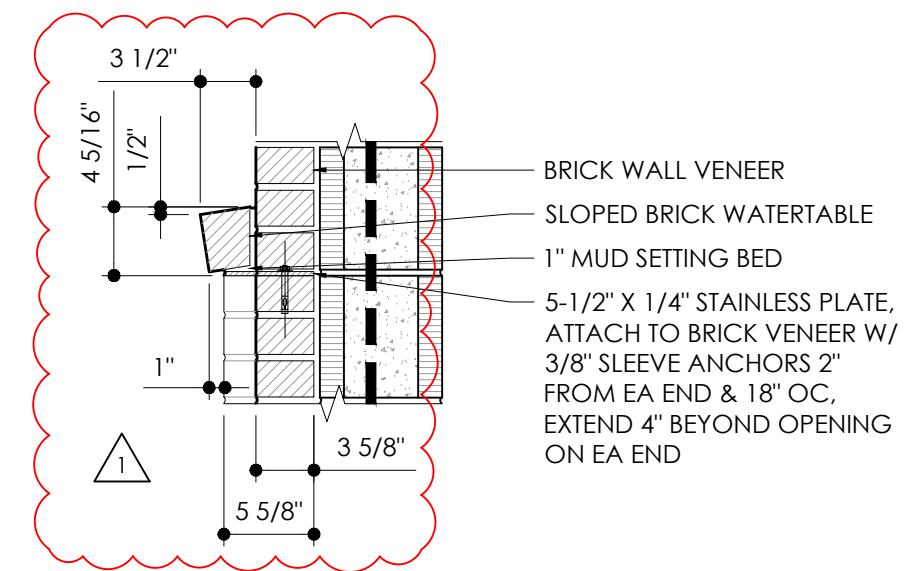

12 FIREPLACE - WATERTABLE OVER REAR DOORS DETAIL
1" = 1'-0"

7 FIREPLACE - SIDE COLUMN COPING DETAIL
1" = 1'-0"



3 FIREPLACE - PLAN VIEW WALL SECTION THROUGH LINTEL
1/2" = 1'-0"

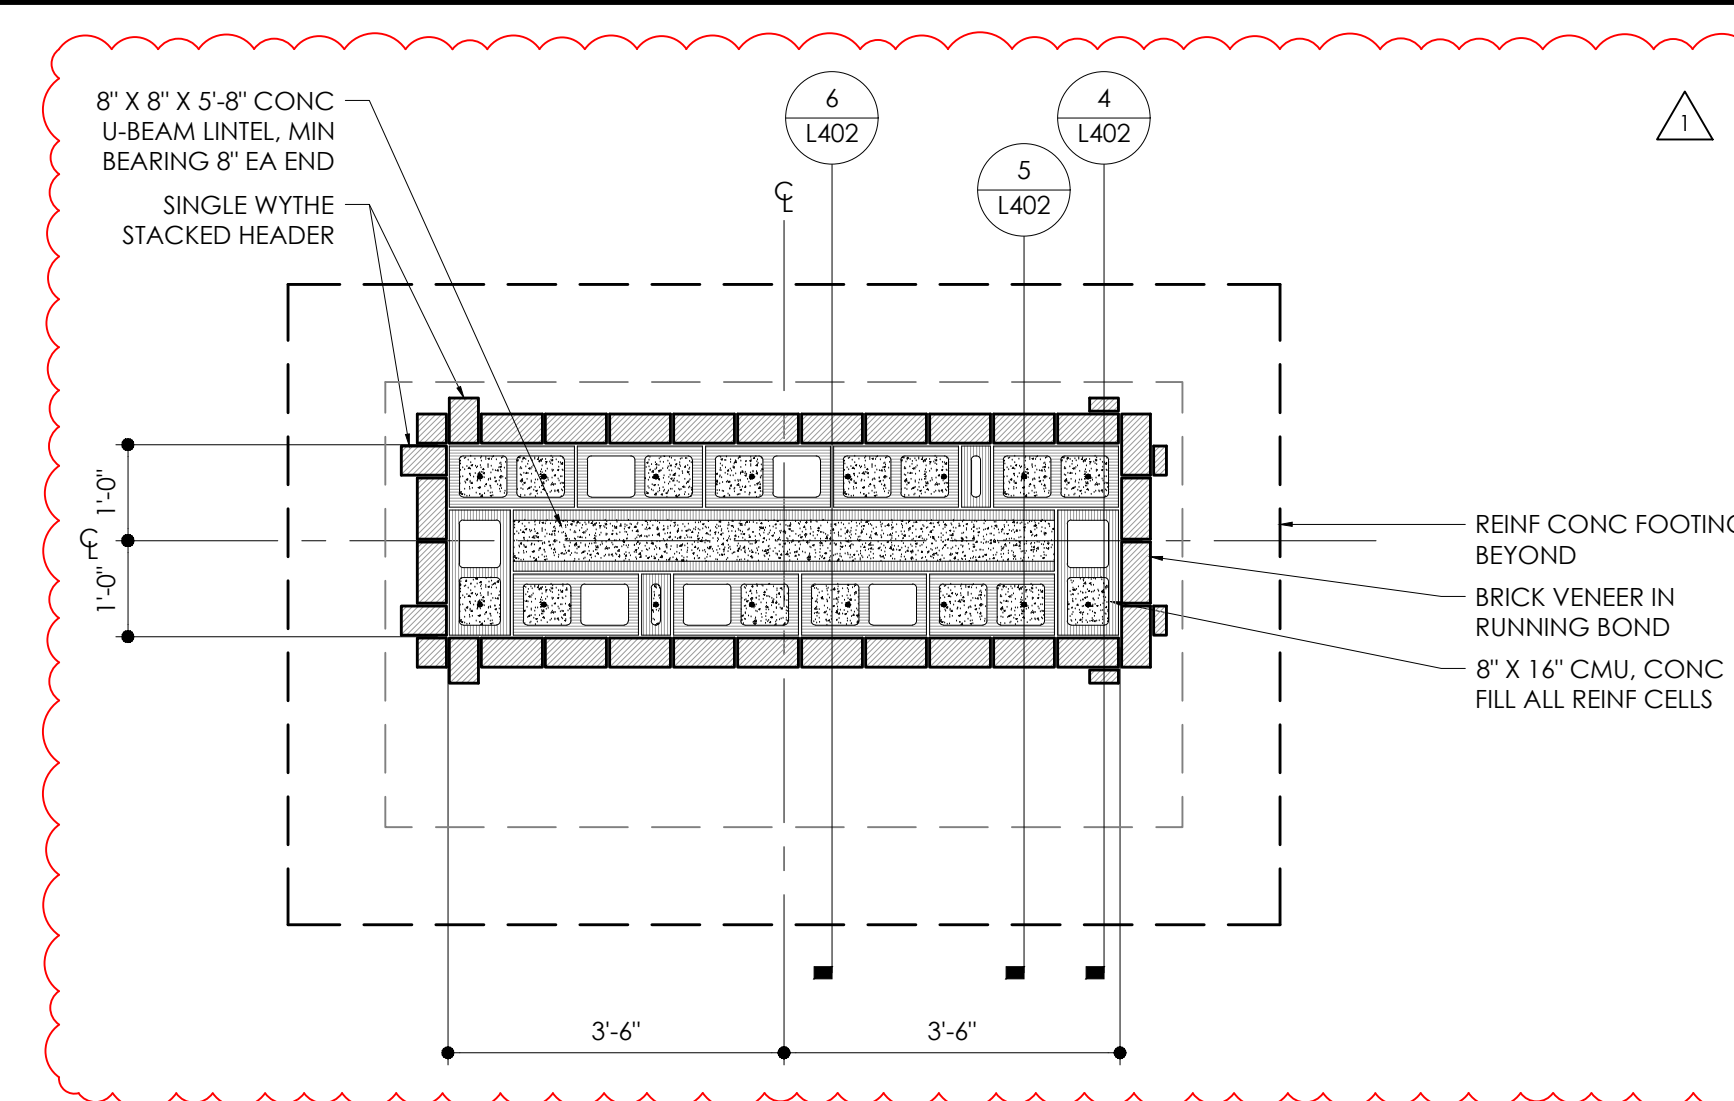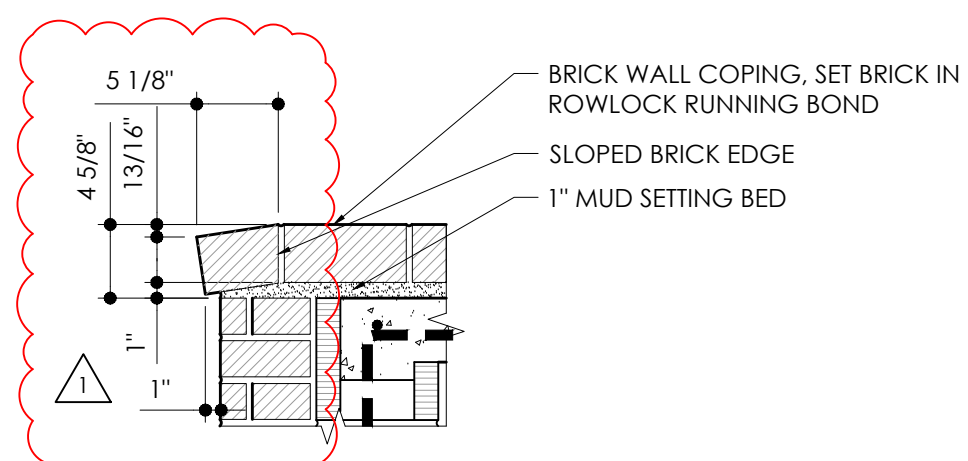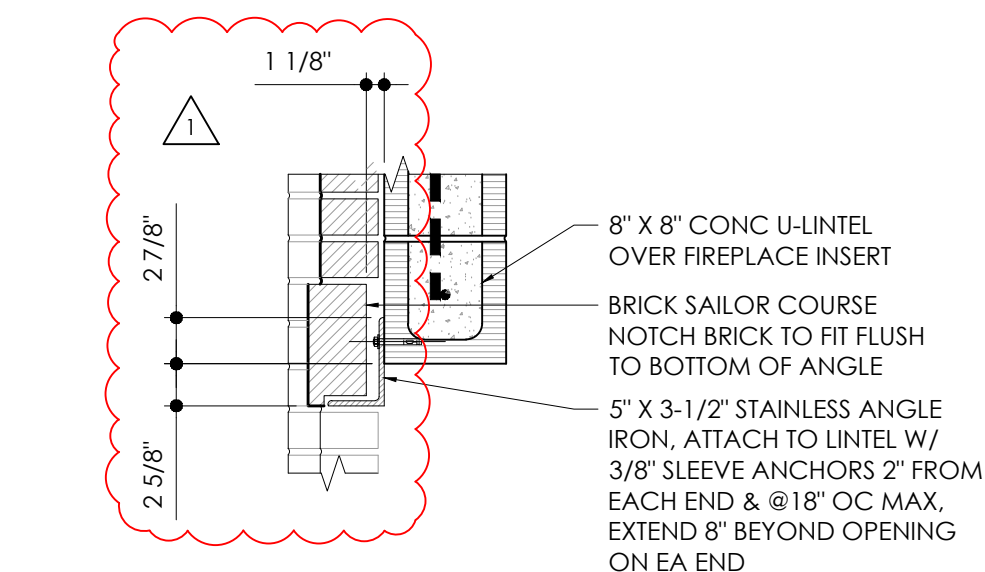

13 FIREPLACE - SAILOR COURSE LINTEL DETAIL
1" = 1'-0"

8 FIREPLACE - SIDE COLUMN COPING DETAIL
1" = 1'-0"

4 FIREPLACE - PLAN VIEW SECTION ABOVE LINTEL
1/2" = 1'-0"

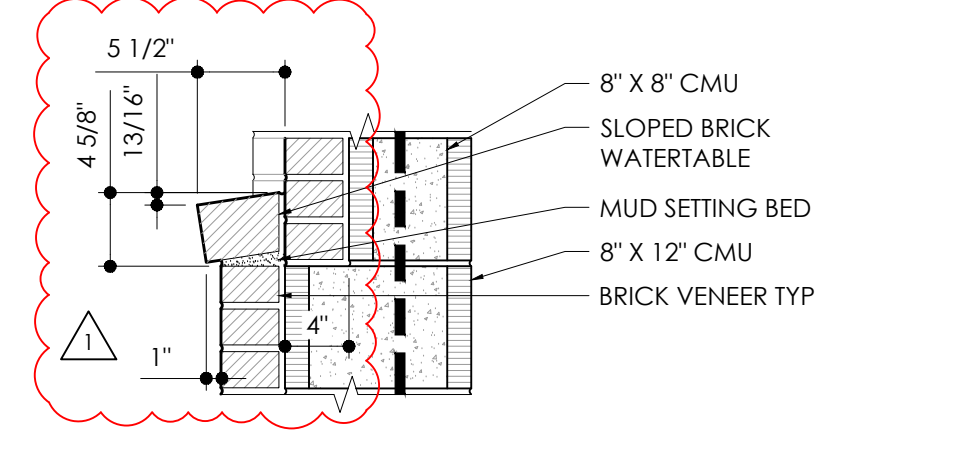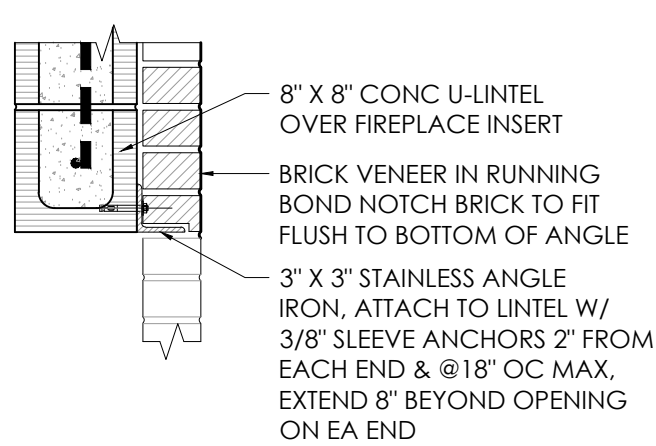

14 FIREPLACE - BRICK LINTEL OVER LOUVERED DOORS
1" = 1'-0"

9 FIREPLACE - WATERTABLE DETAIL
1" = 1'-0"

GOLF CLUB OUTDOOR BAR
PONTE VEDRA INN & CLUB
PONTE VEDRA BEACH, ST. JOHNS COUNTY, FLORIDA

ISSUE DATES

NO.	DESCRIPTION	DATE
1	AS NOTED	24.02.26

THIS DRAWING IS AN INSTRUMENT OF SERVICE AND THE PROPERTY OF ELM, INC. AND SHALL REMAIN THEIR PROPERTY. THE USE OF THIS DRAWING SHALL BE RESTRICTED TO THE ORIGINAL SITE FOR WHICH IT IS PREPARED, AND PUBLICATION THEREOF IS EXPRESSLY LIMITED TO SUCH USE.

PROJ. #: 22-44
DATE: 12.22.2023
DRAWN BY: MCK
CHECKED BY: MCK
SCALE: AS NOTED

HARDSCAPE DETAILS


SHEET NUMBER

L403

Project Status

PLANT SCHEDULE

SYMBOL	CODE	QTY	BOTANICAL NAME	COMMON NAME	NATIVE	SHADE	CANOPY	REMARKS
TREES								
	SP5	8	SABAL PALMETTO	SABAL PALM	YES	NO	11'	16' C.T. HEIGHT, ALL TRUNKS TO BE STRAIGHT, MATCHED HEADS
SHRUBS								
	CFR	2	CORDYLINE FRUTICOSA	TI PLANT	YES		42" o.c.	36" HEIGHT, 18" - 24" SPREAD, 7 GAL, 42" OC
	LLR	6	LOMANDRA LONGIFOLIA 'ROMA 13'	PLATINUM BEAUTY VARIEGATED MAT RUSH	NO		36" o.c.	18" - 21" HEIGHT AND SPREAD, 3 GAL, 36" OC
	LSS	4	LIGUSTRUM SINENSE 'SUNSHINE'	SUNSHINE CHINESE PRIVET	NO		36" o.c.	18" - 24" HEIGHT AND SPREAD, 3 GAL, 36" OC
	PMA	23	PODOCARPUS MACROPHYLLUS	JAPANESE PODOCARPUS	A.S.		36" o.c.	30" - 36" HEIGHT, 24" SPREAD MIN, 7 GAL, 36" OC
	RXR	34	RHODODENDRON X 'ROBLEZE'	AUTUMN STARBURST ENCORE AZALEA	YES		30" o.c.	18" X 18" HEIGHT AND SPREAD, 3 GAL, 30" OC, DWARF VARIETY OF REBLOOMING AZALEA, MATURE SIZE 3' - 4' HEIGHT AND SPREAD
GROUND COVERS								
	DTV	22	DIANELLA TASMANICA 'VARIEGATA'	FLAX LILY	NO		15" o.c.	14" - 18" HEIGHT, FULL PLANT, 1 GAL, 15" OC
	EGB	28	EVOLVULUS GLOMERATUS 'BLUE DAZE'	BRAZILIAN DWARF MORNING GLORY	NO		9" o.c.	4" - 6" HEIGHT AND SPREAD, LINER, 9" OC
TURF GRASS								
	SODA	274 SF	STENOTAPHRUM SECUNDATUM 'FLORITAM'	FLORITAM ST. AUGUSTINE SOD	0			SOD - SEE SPECS

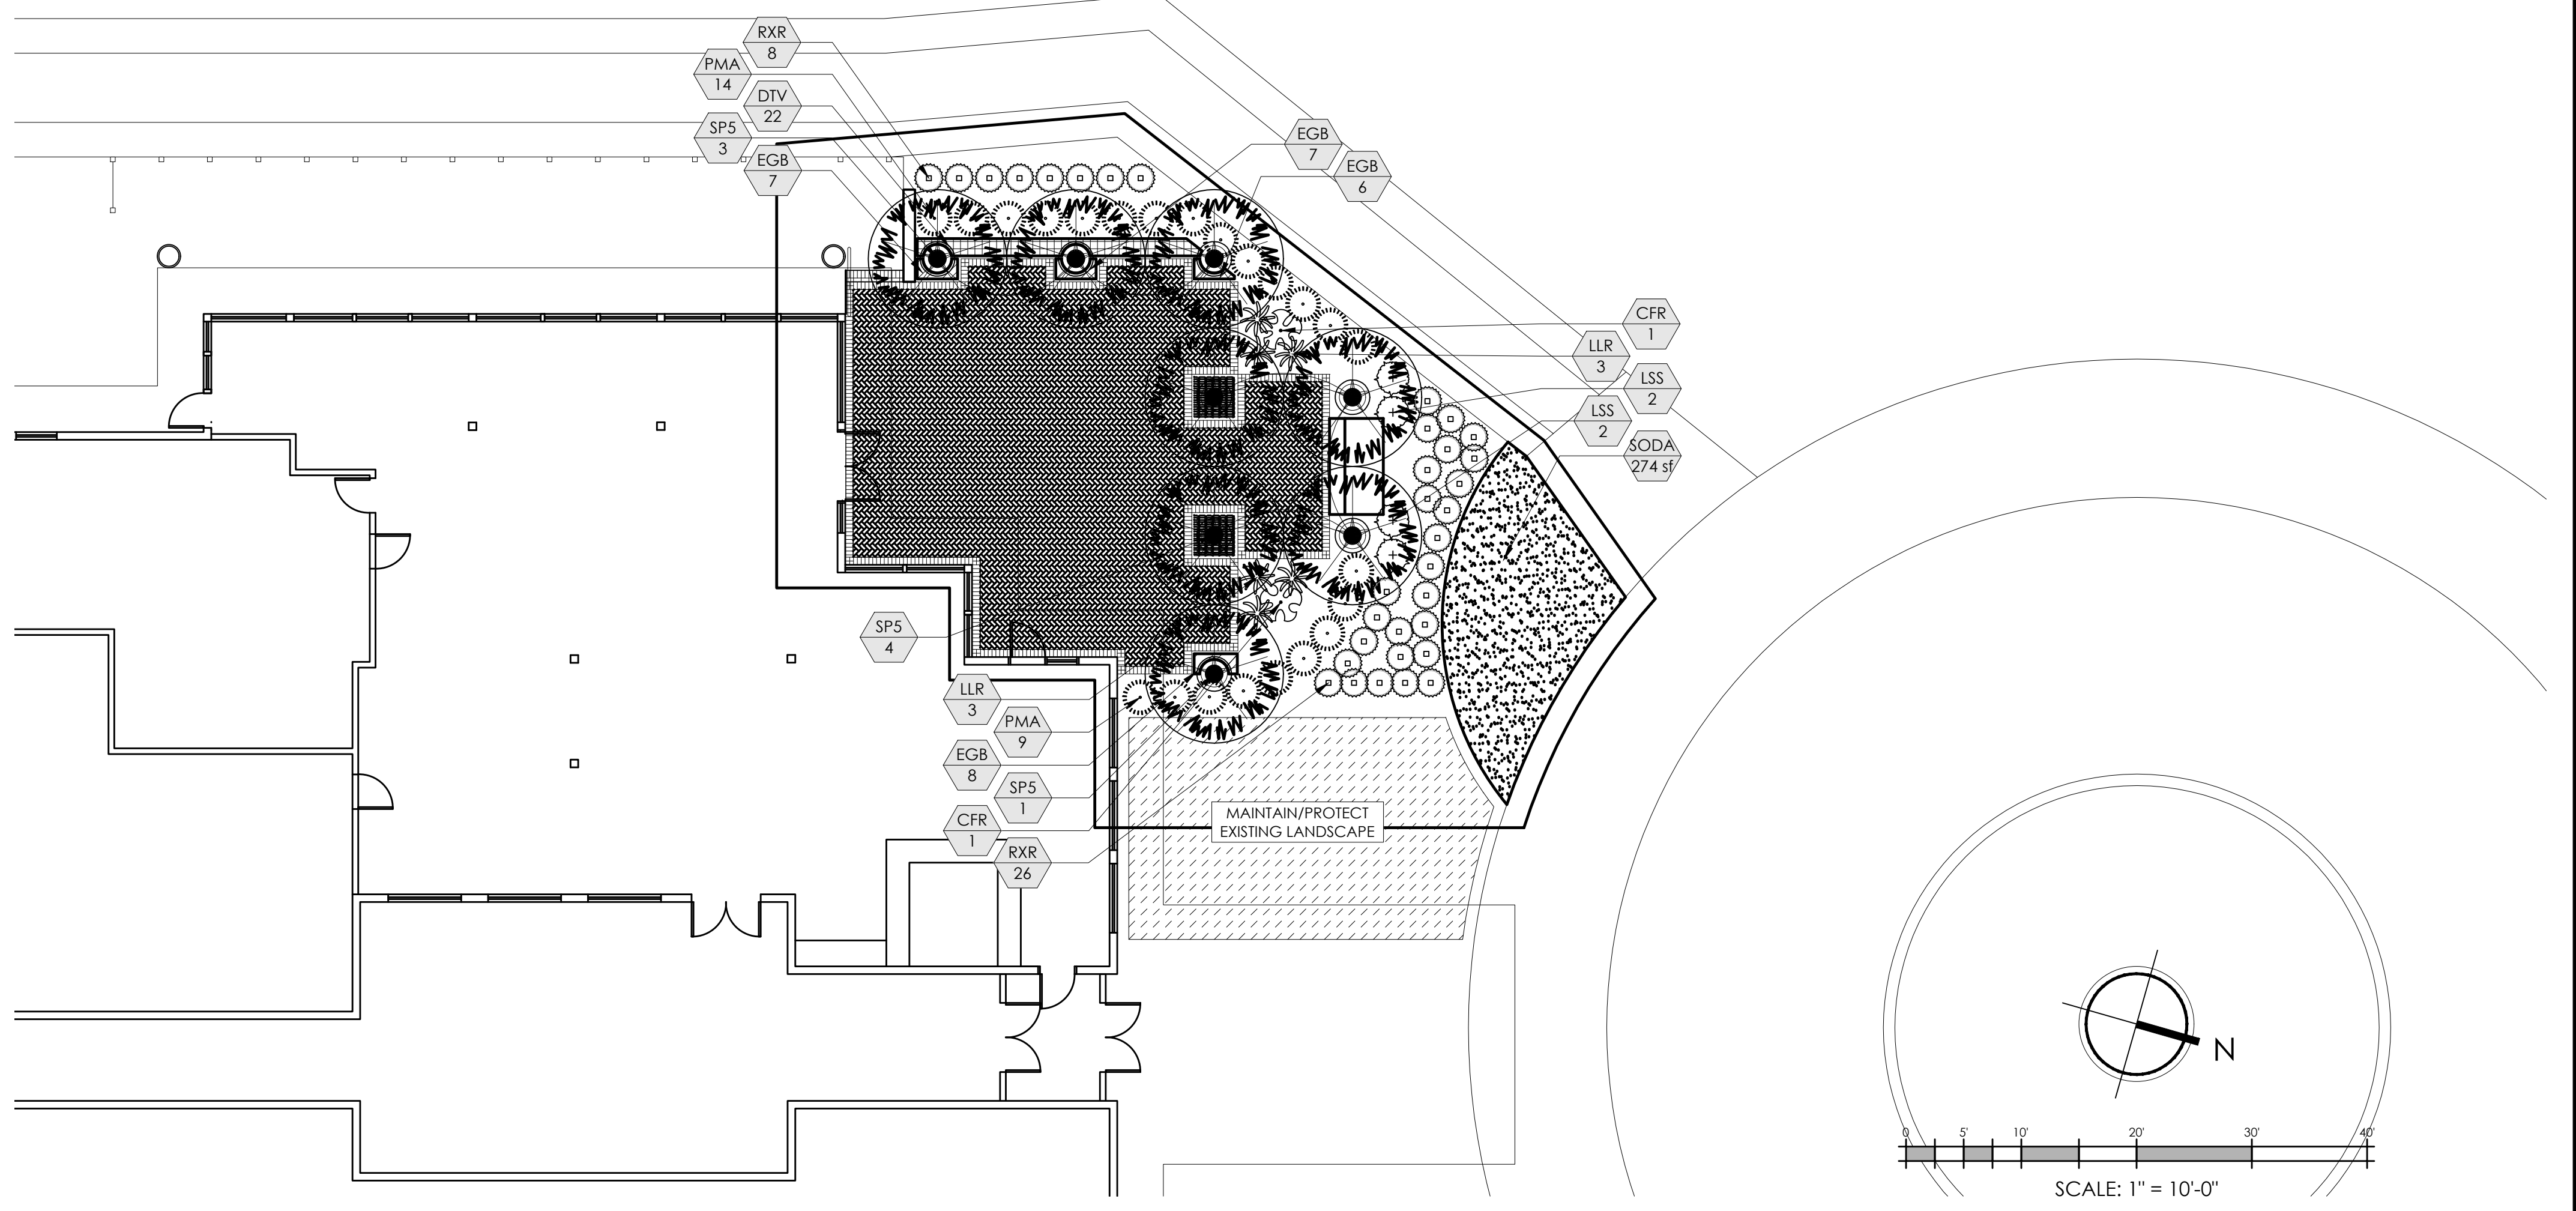

1 LANDSCAPE PLAN
1" = 10'-0"

LANDSCAPE PLANT CALCULATIONS

TREE INCHES PLANTED

QUANTITY	COMMON NAME	TYPE	NATIVE	INCHES CREDITED	TOTAL INCHES
8	SABAL PALM (16' CT)	NON-CANOPY	YES	6	48
				TOTAL INCHES PLANTED (NEED 179' x 122' (REMOVED) + 301')	48

REPLACEMENT INCHES

TYPE	INCHES REMOVED	INCHES PLANTED
CANOPY TREES	0	0
NON-CANOPY TREES	0	0

NATIVE TREE CALCULATIONS

TYPE	QUANTITY	PERCENTAGE
NATIVE TREES	8	100.0%
NON-NATIVE TREES	0	0.0%

CANOPY TREE CALCULATIONS

TYPE	QUANTITY	PERCENTAGE
CANOPY TREES**	0	50.0%
NON-CANOPY TREES***	0	50.0%


INCHES PER ACRE CALCULATION

DEVELOPED ACREAGE	INCHES REQ. PER ACRE (80' / ACRE)	INCHES PRESERVED	INCHES PLANTED	TOTAL INCHES
DEVELOPMENT ACREAGE: 0.05 ACRES	4"	0"	48"	48"


TREE INCHES PLANTED

INCHES REMOVED	INCHES PRESERVED FOR CREDIT	INCHES PLANTED	INCHES CREDITED
DEVELOPMENT AREA: 0'	0'	48"	48"

TOTAL INCHES CREDITED TOWARDS REMOVED: 48"
 TOTAL INCHES REMOVED: 0"
 TOTAL TREE FUND PAYMENT IN ACCORDANCE WITH 4.0.05.F.1.A.4 \$0.00
 NOTE: 4 TREE INCHES ARE REQUIRED PER THE DEVELOPMENT AREA (0.05 ACRES X 80', 0 TREE INCHES ARE REQUIRED AS REPLACEMENT FOR TREES REMOVED FOR DEVELOPMENT, 4 TOTAL TREE INCHES ARE REQUIRED, 48 TREE INCHES ARE PROVIDED.

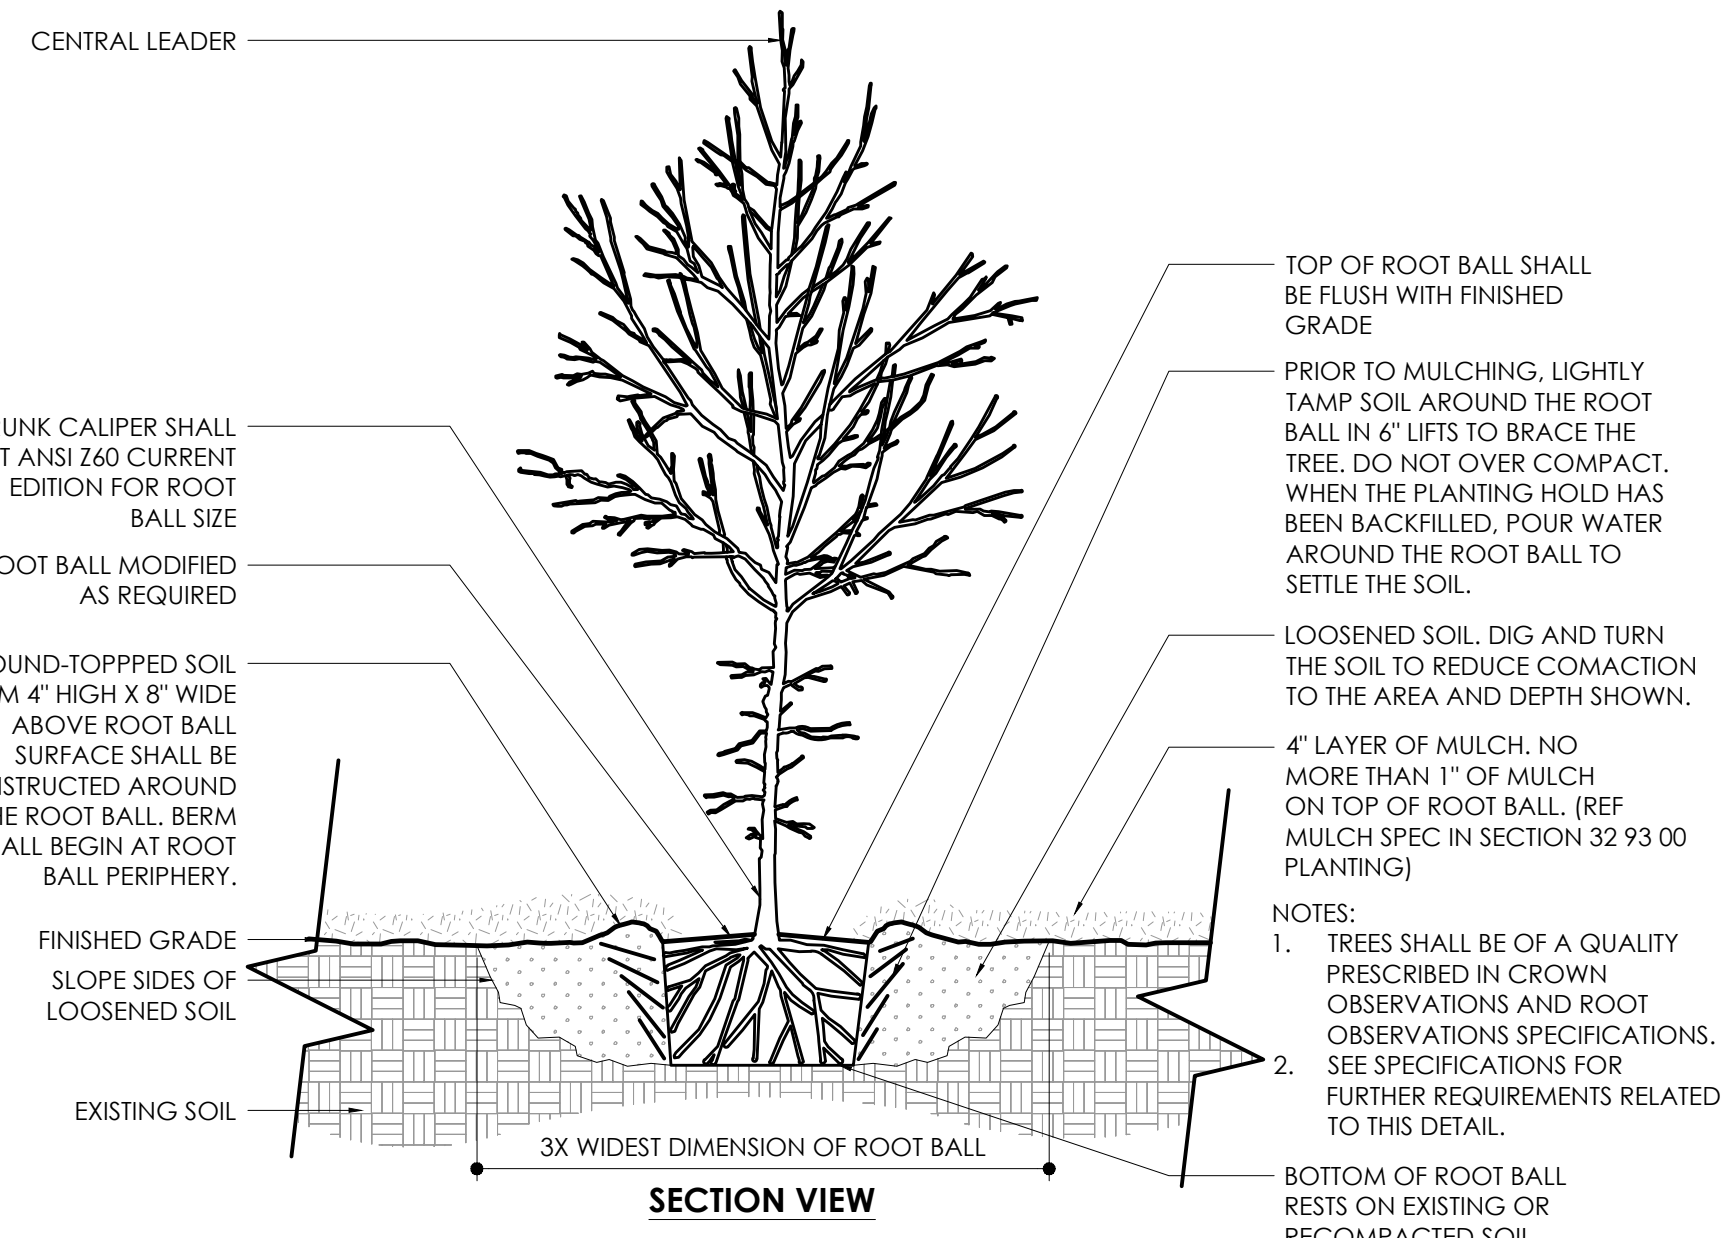

4 TREE WITH BERM
1/2" = 1'-0"

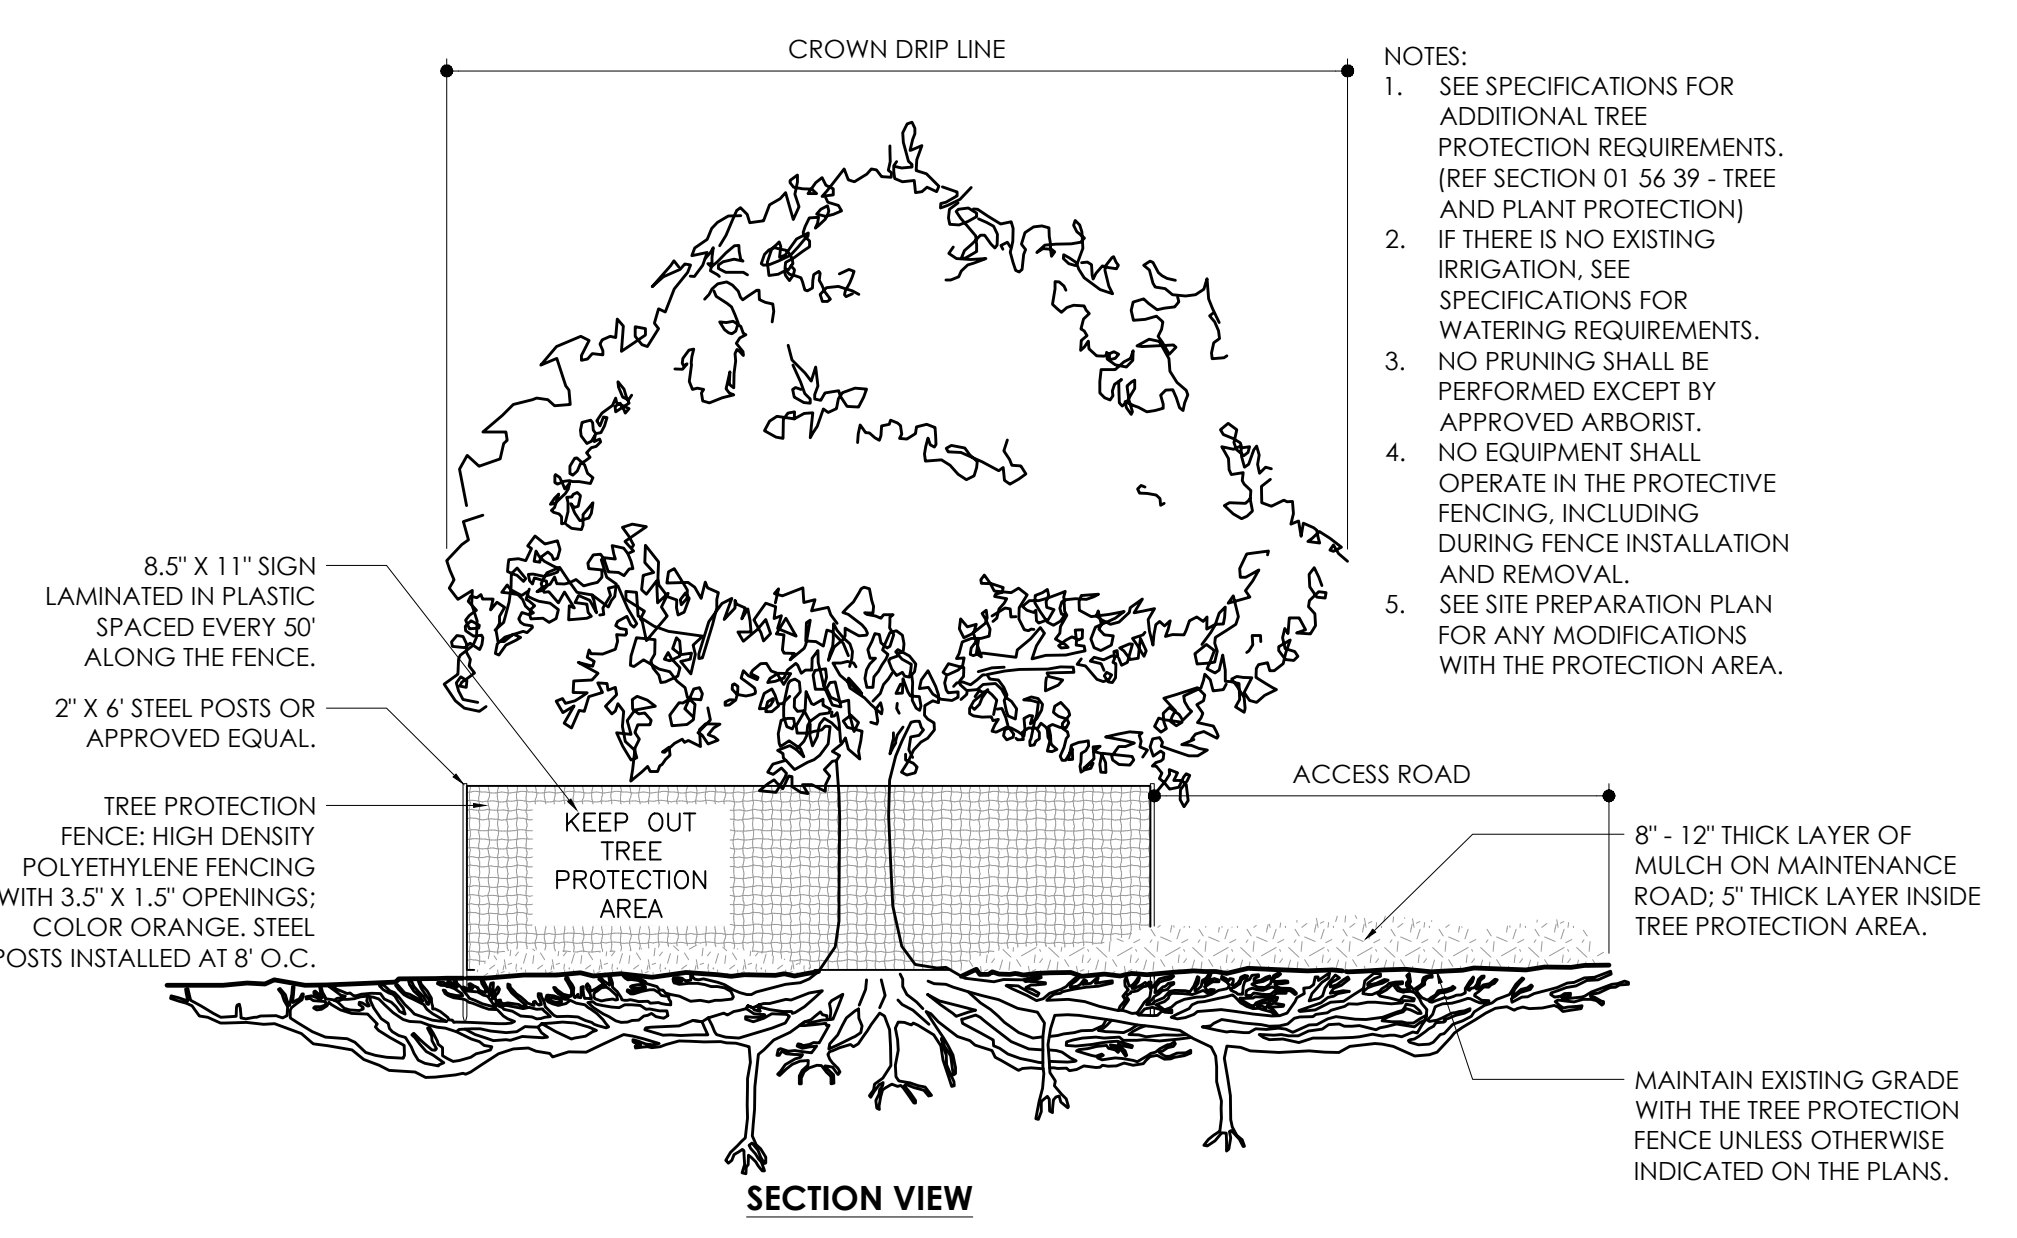


2 TREE PROTECTION DETAIL
1/4" = 1'-0"

GENERAL LANDSCAPE NOTES


- VEGETATION THAT EXCEEDS TWENTY-FIVE (25) FEET IN HEIGHT AT MATURITY SHOULD NOT BE PLANTED CLOSER THAN TEN (10) FEET OF THE VERTICAL PLANE OF AN EXISTING POWER LINE, EXCLUDING SERVICE WIRES.
- BALLED AND BURLAPPED STRAPPING WIRE, AND ANY SYNTHETIC MATERIAL SHALL BE REMOVED PRIOR TO FINAL INSPECTION. WIRE BASKETS SHOULD BE CUT 8" BELOW GRADE.
- NON-CANOPY PROTECTED TREES SHALL NOT BE PLANTED CLOSER THAN TEN (10) FEET FROM OTHER PROTECTED TREES AND PROTECTED CANOPY TREES SHALL NOT BE PLANTED CLOSER THAN TWENTY (20) FEET TO THIRTY (30) FEET FROM OTHER PROTECTED TREES UNLESS APPROVED BY THE COUNTY ADMINISTRATOR. PLANT MATERIAL SHALL CONFORM TO THE STANDARDS FOR GRADE #1 OR BETTER AS GIVEN IN THE LATEST "GRADES AND STANDARDS FOR NURSERY PLANTS I AND II," FLORIDA DEPARTMENT OF AGRICULTURE AND CONSUMER SERVICES OR TO THE STANDARDS AS GIVEN IN THE LATEST "AMERICAN STANDARD FOR NURSERY STOCK," AMERICAN NATIONAL STANDARDS INSTITUTE.
- MULCH SHALL BE PROVIDED AT A MINIMUM OF THREE (3) INCHES IN DEPTH AROUND ALL NEWLY PLANTED LANDSCAPING.
- A MULCH RING FOR ALL NEWLY PLANTED TREES SHALL BE PROVIDED AT LEAST FIVE (5) FEET IN DIAMETER AND NOT CLOSER THAN SIX (6) INCHES FROM THE TREE TRUNK.
- IRRIGATION WILL BE PROVIDED WITH AN AUTOMATIC IRRIGATION SYSTEM. REUSE WATER WILL BE USED AS DESCRIBED IN THE IEA WATER, SEWER AND RECLAIMED WATER DESIGN GUIDELINES.
- TREES SHALL BE A MINIMUM OF EIGHT (8) TO TEN (10) FEET IN HEIGHT AND TWO (2) INCHES OF CALIPER.

EXISTING TREE CARE NOTES

- FLAG ALL TREES AND PALMS TO BE SAVED IN PLACE. PROVIDE BARRICADING IN ACCORDANCE WITH LOCAL STANDARDS AROUND TREES TO BE SAVED. BARRICADING SHALL BE IN PLACE PRIOR TO SITE DEMOLITION.
- ALL EXISTING TREES TO REMAIN SHALL BE BARRICADED (SEE DETAILS). SUCH BARRICADE SHALL BE IN PLACE PRIOR TO LAND CLEARING OR CONSTRUCTION ACTIVITIES.
- ALL CLEARING, GRUBBING, EXCAVATING AND/OR GRADING UNDER THE DRIP LINE OF TREES TO REMAIN SHALL BE DONE BY HAND. ANY EXCEPTIONS TO THIS SHALL BE APPROVED BY THE LANDSCAPE ARCHITECT OR PROJECT ARBORIST.
- ANY ACTIVITIES (DRIVING, STORAGE, ETC.) TO OCCUR WITHIN DRIPLINE OF THE TREES SHOULD BE OF TEMPORARY NATURE AND SHALL ONLY OCCUR AFTER A TEMPORARY MATERIAL SUCH AS MARINE GRADE PLYWOOD AND PINE BARK MULCH (MIN. 12" DEPTH) HAS BEEN SPREAD IN THE DRIPLINE AREA TO BE AFFECTED.
- ALL WORK SHALL BE UNDERTAKEN IN THE PRESENCE OF A REGISTERED ARBORIST EMPLOYED BY THE LANDSCAPE CONTRACTOR. ALL TREES AND PALMS TO BE SAVED SHALL BE EXAMINED FOR DAMAGE, DISEASE AND INSECT INFESTATION. PARTS OF THE TREE SHOWING THESE CONDITIONS SHALL BE TREATED OR PRUNED IN ACCORDANCE WITH THE ARBORIST RECOMMENDATIONS. REMOVE ALL DEAD LIMBS AND VINES.
- ALL TREES TO REMAIN SHALL HAVE ALL DEAD WOOD AND CONFLICTING WOOD REMOVED. ALL TRUNK AND MAJOR LIMB (OVER TWO (2) INCHES DIAMETER) CUTS SHALL BE COATED. COATING USED SHALL BE APPROVED BY PROJECT ARBORIST.
- ROOT PRUNE ALL TREES TO BE SAVED PRIOR TO GRADING AROUND TREES. CUT ALONG LINES OFFSET FROM LINES OF DEVELOPMENT SURROUNDING THE TREE (I.E. AT BUILDING FOUNDATIONS, PARKING LOTS, ETC.)
- TREAT ALL CUTS WITH FUNGICIDAL BARRIER.
- BACKFILL THE TRENCH, WITHIN 4 HOURS OF DIGGING, WITH A 1:1 MIXTURE OF SITE SOIL AND SAWDUST OR OTHER FINE ORGANIC MATERIAL. DO NOT COMPACT.
- FERTILIZE THE PLANT AS DIRECTED BY THE CONSULTING ARBORIST.
- AN ARBORIST SHALL VISIT THE SITE PERIODICALLY TO ASSESS THE HEALTH OF THE TREES AND ISSUE REPORTS ON THE RELATIVE HEALTH OF THE TREE AND MAKE RECOMMENDATIONS FOR FURTHER TREATMENT IF NECESSARY.

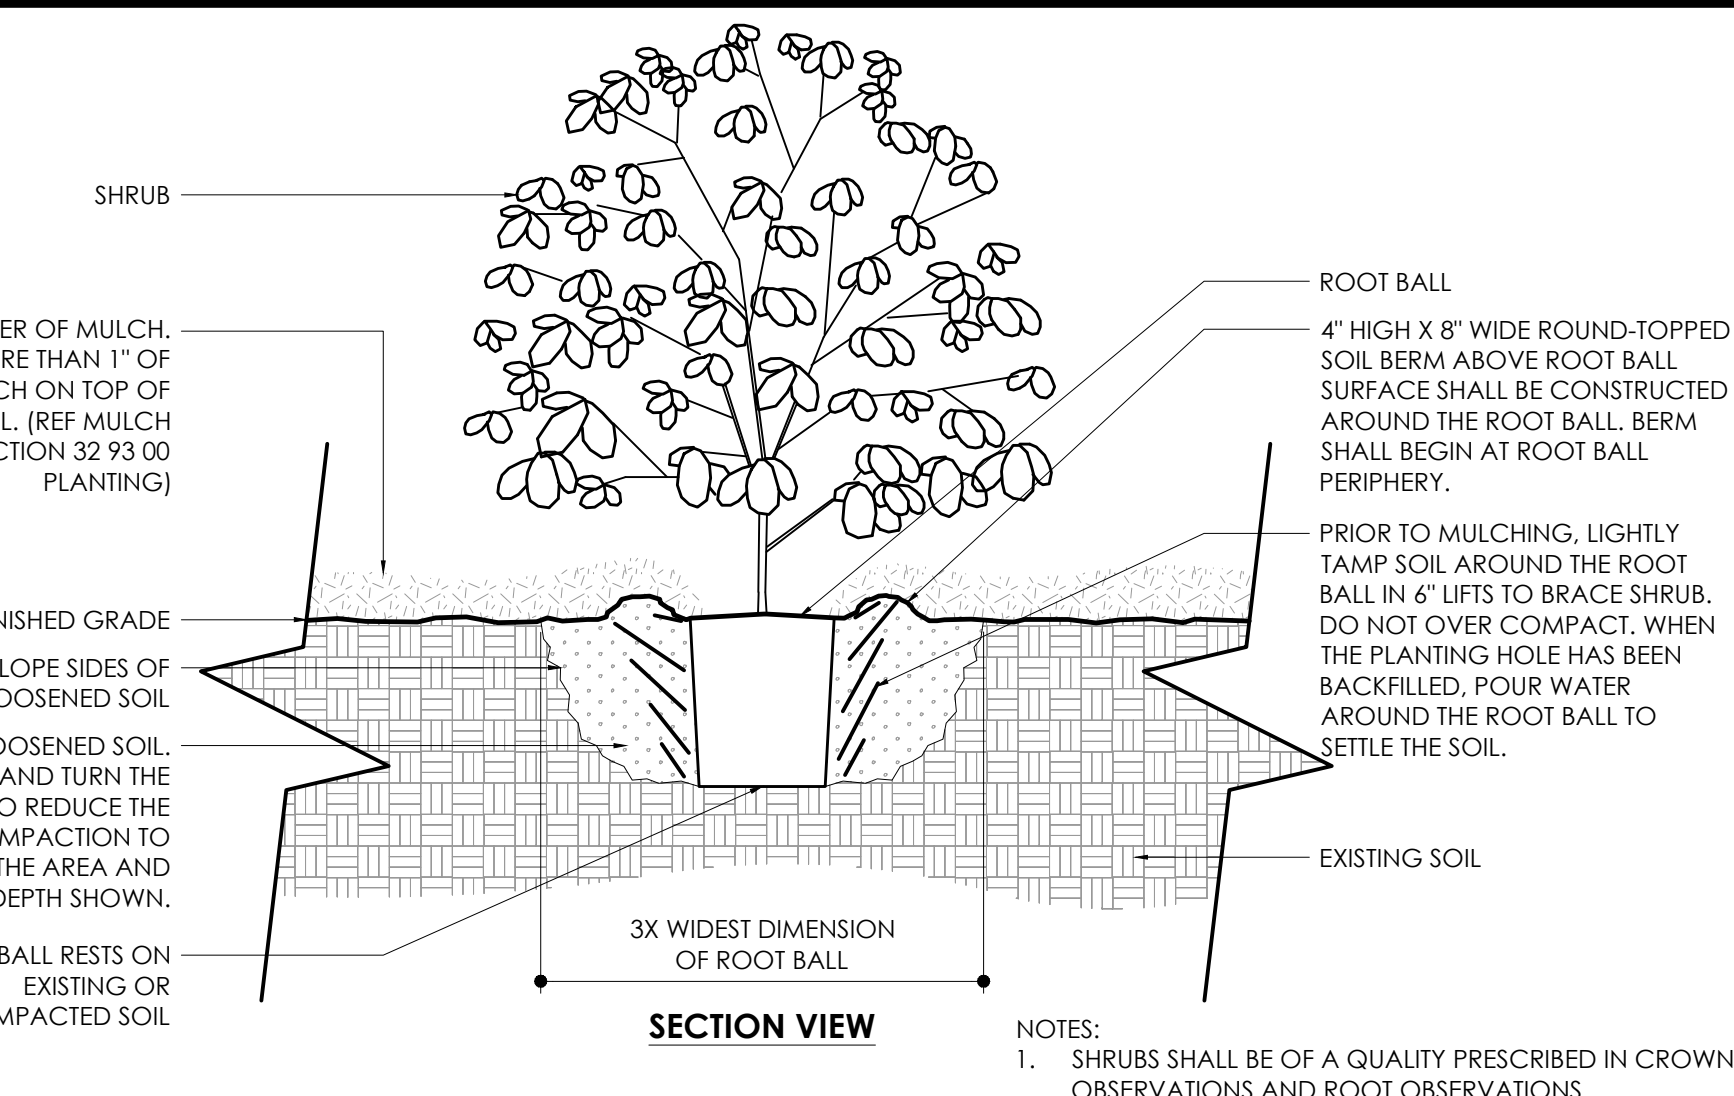

5 SHRUB WITH BERM
3/4" = 1'-0"

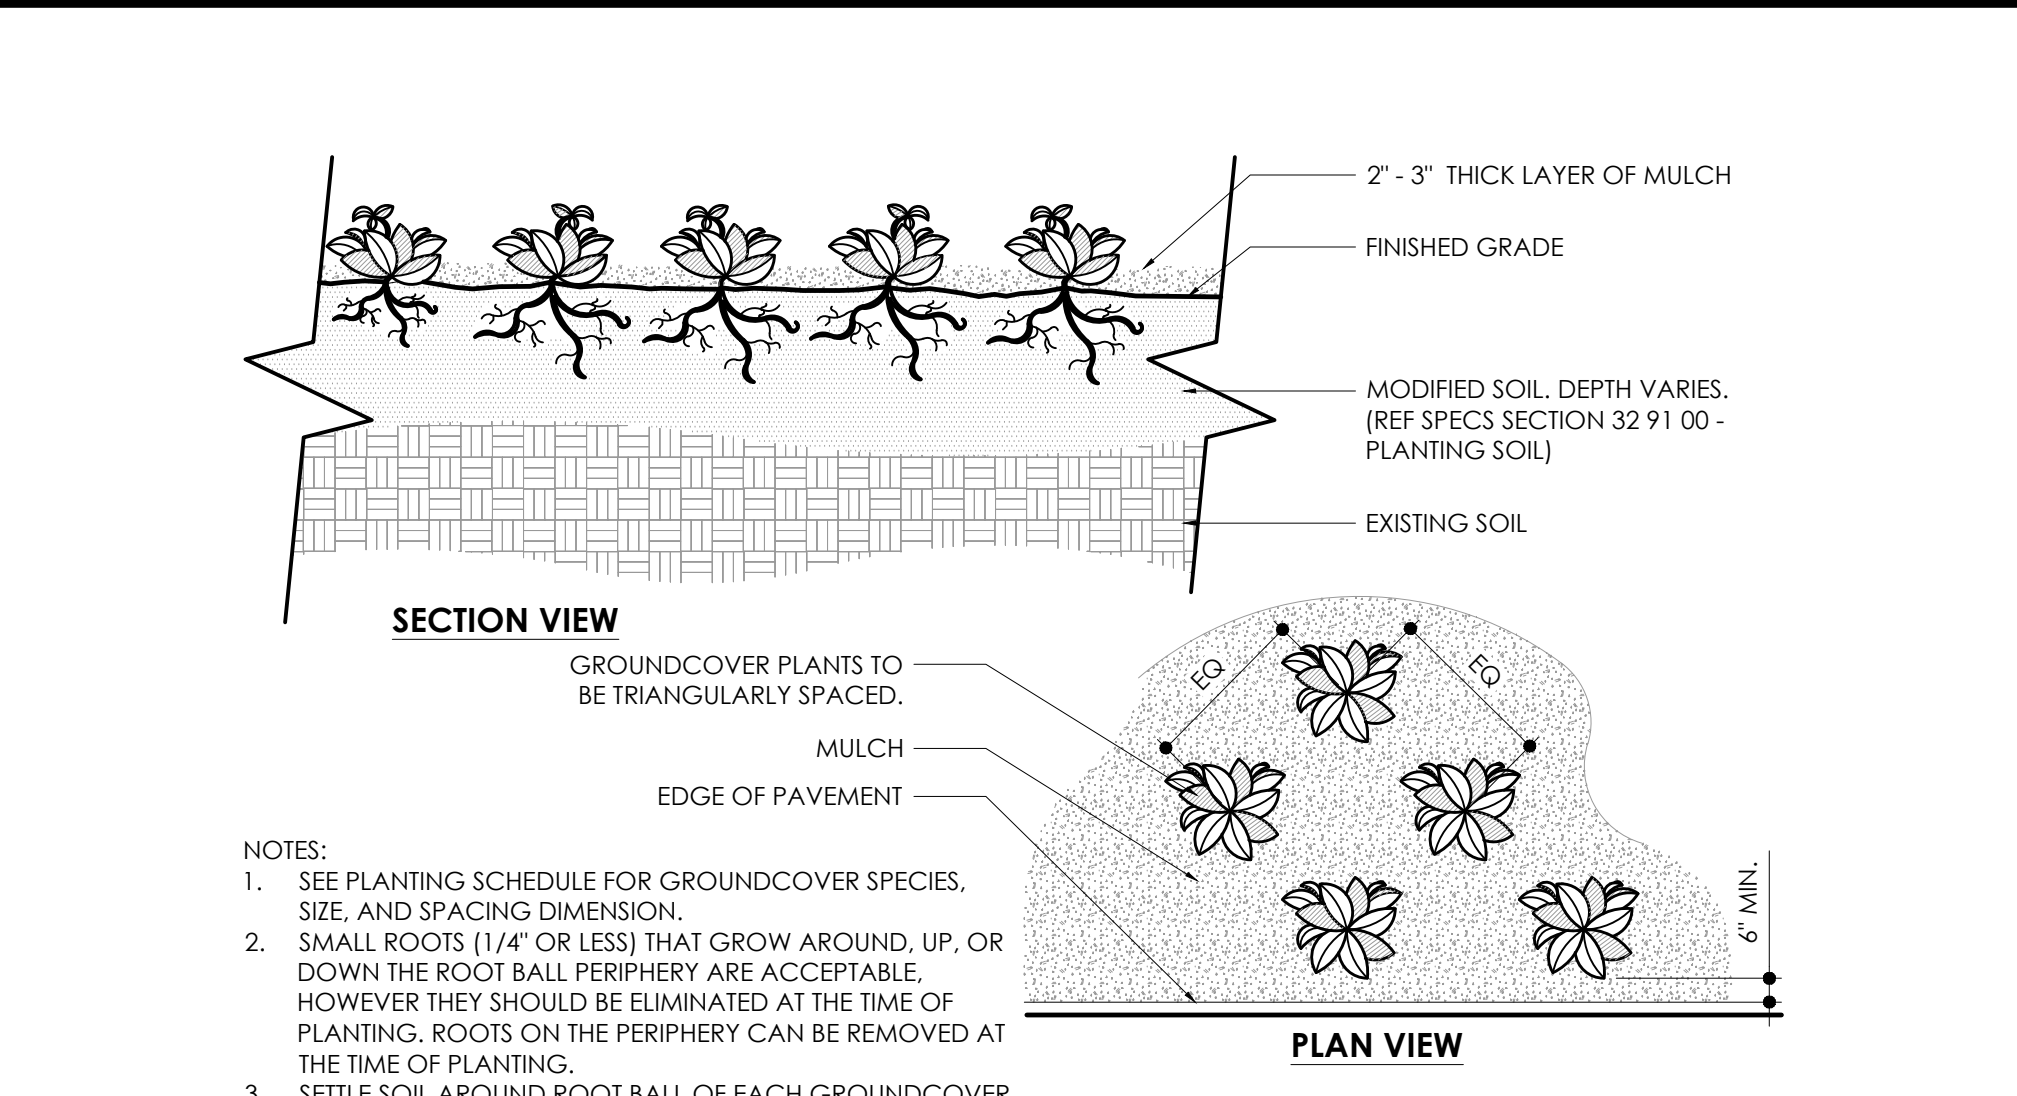

3 Groundcover Detail
3/4" = 1'-0"




planning
architecture
landscape architecture
urban design
visual communication

Jacksonville
ELM Studio
1301 Riverplace Boulevard
Suite 1818
Jacksonville, FL 32207
t 904 296 8066

elmpln.com

AA26000604 - LC26000209

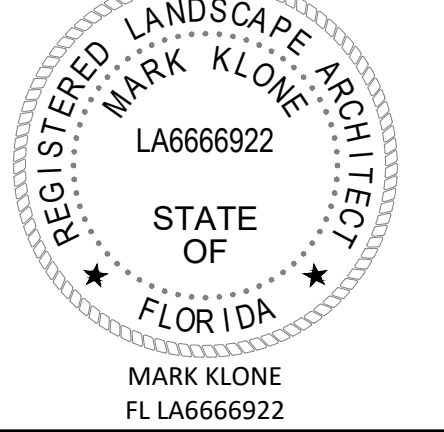

GOLF CLUB OUTDOOR BAR
PONTE VEDRA INN & CLUB
PONTE VEDRA BEACH, ST. JOHNS COUNTY, FLORIDA

ISSUE DATES

NO.	DESCRIPTION	DATE

THIS DRAWING IS AN INSTRUMENT OF SERVICE AND THE PROPERTY OF ELM, INC. AND SHALL REMAIN THEIR PROPERTY. THE USE OF THIS DRAWING SHALL BE RESTRICTED TO THE ORIGINAL SITE FOR WHICH IT IS PREPARED, AND PUBLICATION THEREOF IS EXPRESSLY LIMITED TO SUCH USE.

PROJ. #: 22-44
 DATE: 12.22.2023
 DRAWN BY: MCK
 CHECKED BY: MCK
 SCALE: AS NOTED

LANDSCAPE PLAN, PLANT SCHEDULE, & NOTES

SHEET NUMBER

L501
Project Status

2/28/2024 9:15:23 AM

C. SPADE HARVESTED AND TRANSPLANTED PLANTS

- After installing the tree, loosen the soil along the seam between the root ball and the surrounding soil out to a radius from the root ball edge equal to the diameter of the root ball to a depth of 8 - 10 inches by hand digging to disturb the soil interface.
 - Fill any gaps below this level with loose soil.
- D. CONTAINER (INCLUDES BOXED AND ABOVE-GROUND FABRIC CONTAINERS) PLANTS
- This specification assumes that most container plants have significant stem girdling and circling roots, and that the root collar is too low in the root ball.
 - Remove the container.
 - Perform root ball shaving as defined in Installation of Plants: General above.
 - Remove all roots and substrate above the root collar and the main structural roots according to root correction details so root system conforms to root observations detail.
 - Remove all substrate at the bottom of the root ball that does not contain roots.
 - Using a hose, power washer or air excavation device, wash out the substrate from around the trunk and top of the remaining root ball and find and remove all stem girdling roots within the root ball above the top of the structural roots.

3.11 GROUND COVER, PERENNIAL AND ANNUAL PLANTS

- A. Assume that soil moisture is within the required levels prior to planting. Irrigation, if required, shall be applied at least 12 hours prior to planting to avoid planting in muddy soils.
- B. Assume that soil grades in the beds are smooth and as shown on the plans.
- C. Plants shall be planted in even, triangularly spaced rows, at the intervals called out for on the drawings, unless otherwise noted. The first row of Annual flower plants shall be 6 inches from the bed edge unless otherwise directed.
- D. Dig planting holes sufficiently large enough to insert the root system without deforming the roots. Set the top of the root system at the grade of the soil.
- E. Schedule the planting to occur prior to application of the mulch. If the bed is already mulched, pull the mulch from around the hole and plant into the soil. Do not plant the root system in the mulch. Pull mulch back so it is not on the root ball surface.
- F. Press soil to bring the root system in contact with the soil.
- G. Spread any excess soil around in the spaces between plants.
- H. Apply mulch to the bed being sure not to cover the tops of the plants with or the tops of the root ball with mulch.
- I. Water each planting area as soon as the planting is completed. Apply additional water to keep the soil moisture at the required levels. Do not over water.

3.12 PALM PLANTING

- A. Palm trees shall be placed at grade making sure not to plant the tree any deeper in the ground than the palm trees originally stood.
- B. The trees shall be placed with their vertical axis in a plumb position.
- C. All backfill shall be native soil except in cases where planting in rock. Water-settle the back fill.
- D. Do not cover root ball with mulch or topsoil.
- E. Provide a watering berm at each palm. Berms shall extend a minimum of 18 inches out from the trunk all around and shall be a minimum of 6 inches high.
- F. Remove twine which ties fronds together after placing palm in planting hole and securing it in the upright position.

3.13 STAKING AND GUYING

- A. Do not stake or guy trees unless specifically required by the Contract Documents, or in the event that the Contractor feels that staking is the only alternative way to keep particular trees plumb.
- The Owner's Representative shall have the authority to require that trees are staked or to reject staking as an alternative way to stabilize the tree.
 - Trees that required heavily modified root balls to meet the root quality standards may become unstable. The Owner's Representative may choose to reject these trees rather than utilize staking to temporarily support the tree.
- B. Trees that are guyed shall have their guys and stakes removed after one full growing season or at other times as required by the Owner's Representative.
- C. Tree guying shall utilize the tree staking and guying materials specified. Guying to be tied in such a manner as to create a minimum 12-inch loop to prevent girdling. Refer to manufacturer's recommendations and the planting detail for installation.
- Plants shall stand plumb after staking or guying.
 - Stakes shall be driven to sufficient depth to hold the tree rigid.
- D. For trees planted in planting mix over waterproofed membrane, use dead men buried 24 inches to the top of the dead man, in the soil. Tie the guy to the dead man with a double wrap of line around the dead man followed by a double half hitch. When guys are removed, leave the dead men in place and cut the guy tape 12 inches above the ground, leaving the tape end covered in mulch.

3.14 STRAIGHTENING PLANTS

- A. Maintain all plants in a plumb position throughout the warranty period. Straighten all trees that move out of plumb including those not staked. Plants to be straightened shall be excavated and the root ball moved to a plumb position, and then re-baffled.
- B. Do not straighten plants by pulling the trunk with guys.

3.15 INSTALLATION OF FERTILIZER AND OTHER CHEMICAL ADDITIVES

- A. Do not apply any soluble fertilizer to plantings during the first year after transplanting unless soil test determines that fertilizer or other chemical additives is required. Apply chemical additives only upon the approval of the Owner's Representative.
- B. Controlled release fertilizers shall be applied according to the manufacturer's instructions and standard horticultural practices.

3.16 PRUNING OF TREES AND SHRUBS

- A. Prune plants as directed by the Owner's Representative. Pruning trees shall be limited to addressing structural defects as shown in details; follow recommendations in "Structural Pruning: A Guide For the Green Industry" published by Urban Tree Foundation, Vista, CA.
- B. All pruning shall be performed by a person experienced in structural tree pruning.
- C. Except for plants specified as multi-stemmed or as otherwise instructed by the Owner's Representative, preserve or create a central leader.
- D. Pruning of large trees shall be done using pole pruners or if needed, from a ladder or hydraulic lift to gain access to the top of the tree. Do not climb newly planted trees. Small trees can be structurally pruned by laying them over before planting. Pruning may also be performed at the nursery prior to shipping.
- E. Remove and replace excessively pruned or malformed stock resulting from improper pruning that occurred in the nursery or after.
- F. Pruning shall be done with clean, sharp tools.
- G. No tree paint or sealants shall be used.

3.17 MULCHING OF PLANTS

- A. Apply 3 inches of mulch before settlement, covering the entire planting bed area. Install no more than 1 inch of mulch over the top of the root balls of all plants. Taper to 2 inches when abutting pavement.
- B. For trees planted in lawn areas the mulch shall extend to a 5 foot radius around the tree or to the extent indicated on the plans.
- C. Lift all leaves, low hanging stems and other green portions of small plants out of the mulch if covered.

3.18 PLANTING BED FINISHING

- A. After planting, smooth out all grades between plants before mulching.
- B. Separate the edges of planting beds and lawn areas with a smooth, formed edge cut into the turf with the bed mulch level slightly lower, 1 and 2 inches, than the adjacent turf sod or as directed by the Owner's Representative. Bed edge lines shall be depicted on the drawings.

3.19 WATERING

- A. The Contractor shall be fully responsible to ensure that adequate water is provided to all plants from the point of installation until the date of Substantial Completion Acceptance. The Contractor shall adjust the automatic irrigation system, if available, and apply additional or adjust for less water using hoses as required.
- B. Hand water root balls of all plants to assure that the root balls have moisture above will point and below field capacity. Test the moisture content in each root ball and the soil outside the root ball to determine the water content.

3.20 CLEAN-UP

- A. During installation, keep the site free of trash, pavements reasonably clean and work area in an orderly condition at the end of each day. Remove trash and debris in containers from the site no less than once a week.
- Immediately clean up any spilled or tracked soil, fuel, oil, trash or debris deposited by the Contractor from all surfaces within the project or on public right of ways and neighboring property.
- B. Once installation is complete, wash all soil from pavements and other structures. Ensure that mulch is confined to planting beds and that all tags and flagging tape are removed from the site. The Owner's Representative's seeds are to remain on the trees and removed at the end of the warranty period.
- C. Make all repairs to grades, ruts, and damage by the plant installer to the work or other work at the site.
- D. Remove and dispose of all excess planting soil, subsoil, mulch, plants, packaging, and other material brought to the site by the Contractor.

3.21 PROTECTION DURING CONSTRUCTION

- A. The Contractor shall protect planting and related work and other site work from damage due to planting operations, operations by other Contractors or trespassers. Maintain protection during installation until Substantial Completion Acceptance. Treat, repair or replace damaged work immediately.
- B. Damage done by the Contractor, or any of their sub-contractors to existing or installed plants, or any other parts of the work or existing features to remain, including roots, trunk or branches of large existing trees, soil, paving, utilities, lighting, irrigation, other finished work and surfaces including those on adjacent property, shall be cleaned, repaired or replaced by the Contractor at no expense to the Owner. The Owner's Representative shall determine when such cleaning, replacement or repair is satisfactory.

3.22 PLANT MAINTENANCE PRIOR TO SUBSTANTIAL COMPLETION ACCEPTANCE

- A. During the project work period and prior to Substantial Completion Acceptance, the Contractor shall maintain all plants.
- B. Maintenance during the period prior to Substantial Completion Acceptance shall consist of pruning, watering, cultivating, weeding, mulching, removal of dead material, repairing and replacing of tree stakes, tightening and repairing of guys, repairing and replacing of damaged tree wrap material, resetting plants to proper grades and upright position, and furnishing and applying such sprays as are necessary to keep plantings reasonably free of damaging insects and disease, and in healthy condition. The threshold for applying insecticides and herbicides shall follow established Integrated Pest Management (IPM) procedures. Mulch areas shall be kept reasonably free of weeds, grass.

3.23 SUBSTANTIAL COMPLETION ACCEPTANCE

- A. Upon written notice from the Contractor, the Owners Representative shall review the work and make a determination if the work is substantially complete.
- Notification shall be at least 7 days prior to the date the contractor is requesting the review.
 - The date of substantial completion of the planting shall be the date when the Owner's Representative accepts that all work in Planting, Planting Soil, and irrigation installation sections is complete.
 - The Plant Warranty period begins at date of written notification of substantial completion from the Owner's Representative. The date of substantial completion may be different than the date of substantial completion for the other sections of the project.

3.24 MAINTENANCE DURING THE WARRANTY PERIOD BY OWNER

- A. After Substantial Completion Acceptance, the Contractor shall make sufficient site visits to observe the Owner's maintenance and become aware of problems with the maintenance in time to request changes, until the date of End of Warranty Final Acceptance.
- Notify the Owner's Representative in writing if maintenance, including watering, is not sufficient to

maintain plants in a healthy condition. Such notification must be made in a timely period so that the Owner's Representative may take corrective action.

a. Notification must define the maintenance needs and describe any corrective action required.

- In the event that the Contractor fails to visit the site and or notify, in writing, the Owner's Representative of maintenance needs, lack of maintenance shall not be used as grounds for voiding or modifying the provisions of the warranty.

3.25 MAINTENANCE DURING THE WARRANTY PERIOD BY INSTALLER

- A. During the warranty period, provide all maintenance for all plantings to keep the plants in a healthy state and the planting areas clean and neat.
- B. General requirements:
- All work shall be undertaken by trained planting crews under the supervision of a foreman with a minimum of 5 years experience supervising commercial plant maintenance crews.
 - All chemical and fertilizer applications shall be made by licensed applicators for the type of chemicals to be used. All work and chemical use shall comply with all applicable local, provincial and federal requirements.
 - Assure that hoses and watering equipment and other maintenance equipment does not block paths or be placed in a manner that may create tripping hazards. Use standard safety warning banners and other procedures to maintain the site in a safe manner for visitors at all times.
 - All workers shall wear required safety equipment and apparel appropriate for the tasks being undertaken.
 - The Contractor shall not store maintenance equipment at the site at times when they are not in use unless authorized in writing by the Owner's Representative.
 - Maintenance vehicles shall not park on the site including walks and lawn areas at any time without the Owner's Representative's written permission.
 - Maintain a detailed log of all maintenance activities including types of tasks, date of task, types and quantities of materials and products used, watering times and amounts, and number of each crew. Periodically review the logs with the Owner's Representative, and submit a copy of the logs at the end of each year of the maintenance agreement.
 - Meet with the Owner's Representative a minimum of three times a year to review the progress and discuss any changes that are needed in the maintenance program. At the end of the warranty period attend a hand over meeting to formally transfer the responsibilities of maintenance to the Owner's Representative. Provide all information on past maintenance activities and provide a list of critical tasks that will be needed over the next 12 months. Provide all maintenance logs and soil test data. Make the Contractor's supervisor available for a minimum of one year after the end of the warranty period to answer questions about past maintenance.

C. Provide the following maintenance tasks:

- Watering: Provide all water required to keep soil within and around the root balls at optimum moisture content for plant growth.
 - Maintain all watering systems and equipment and keep them operational.
 - Monitor soil moisture to provide sufficient water. Check soil moisture and root ball moisture with a soil moisture meter on a regular basis and record moisture readings. Do not over water.
- Soil nutrient levels: Take a minimum of 4 soil samples from around the site in the spring and fall and have them tested by an accredited agricultural soil testing lab for chemical composition of plant required nutrients, pH, salt and % organic matter. Test results shall include laboratory recommendations for nutrient applications. Apply fertilizers at rates recommended by the soil test.
 - Make any other soil test and/or plant tissue test that may be indicated by plant conditions that may not be related to soil nutrient levels such as soil contaminated by other chemicals or lack of chemical uptake by the plant.
- Plant pruning: Remove cross over branching, shorten or remove developing co dominant leaders, dead wood and winter-damaged branches. Unless directed by the Owner's Representative, do not shear plants or make heading cuts.
- Restore plants: Reset any plants that have settled or are leaning as soon as the condition is noticed.
- Guying and staking: Maintain plant guys in a taught position. Remove tree guys and staking after the first full growing season unless directed by Owner's Representative.
- Weed control: Keep all beds free of weeds. Hand remove all weeds and any plants that do not appear on the planting plan. Chemical weed control is permitted only with the approval of the Owner's Representative. Schedule weeding as needed but not less 12 times per year.
- Trash removal: Remove all trash and debris from all planting beds and maintain the beds in a neat and tidy appearance. The number of trash and debris removal visits shall be no less than 12 times per year and may coincide with other maintenance visits.
- Plant pest control: Maintain disease, insects and other pests at manageable levels. Manageable levels shall be defined as damage to plants that may be noticeable to a professional but not to the average person. Use least invasive methods to control plant disease and insect outbreaks.
 - The Owner's Representative must approve in advance the use of oil chemical pesticide applications.
- Plant replacement: Replace all plants that are defective as defined in the warranty provisions, as soon as the plant decline is obvious and in suitable weather and season for planting as outlined in above sections. Plants that become defective during the maintenance period shall be covered and replaced under the warranty provisions.
- Mulch: Refresh mulch once a year to maintain complete coverage but do not over mulch. At no time shall the overall mulch thickness be greater than 3 inches. Do not apply mulch within 6 inches of the trunks or stems of any plants. Replacement mulch shall meet the requirements of the original approved material. Mulch shall be no more than one inch on top of the root ball surface.
- Bed edging: Check and maintain edges between mulch and lawn areas in smooth neat lines as originally shown on the drawings.
- Leaf, fruit and other plant debris removal: Remove leaf fall, spent flowers, fruit and plant part accumulations from beds and paved surfaces. Maintain all surface water drains free of debris. Debris removal shall be undertaken at each visit to weed or pick up trash in beds.
- Damage from site use: Repair of damage by site visitors and events, beyond normal wear, are not part of this maintenance. The Owner's Representative may request that the Contractor repair damage beds or plantings for an additional cost. All additional work shall be approved in advance by the Owner's Representative.

END OF SECTION 32 93 00

3.26 END OF WARRANTY FINAL ACCEPTANCE / MAINTENANCE OBSERVATION

- A. At the end of the Warranty and Maintenance period the Owner's Representative shall observe the work and establish that all provisions of the contract are complete and the work is satisfactory.
- If the work is satisfactory, the maintenance period will end on the date of the final observation.
 - If the work is deemed unsatisfactory, the maintenance period will continue of no additional expense to the Owner until the work has been completed, observed, and approved by the Owner's Representative.
- B. FAILURE TO PASS OBSERVATION: If the work fails to pass final observation, any subsequent observations must be rescheduled as per above. The cost to the Owner for additional observations will be charged to the Contractor at the prevailing hourly rate of the Owner's Representative.




planning architecture landscape architecture urban design visual communication

Jacksonville ELM Studio 1301 Riverplace Boulevard Suite 1818 Jacksonville, FL 32207 t 904 296 8066

elmpln.com

AA26000604 - LC26000209

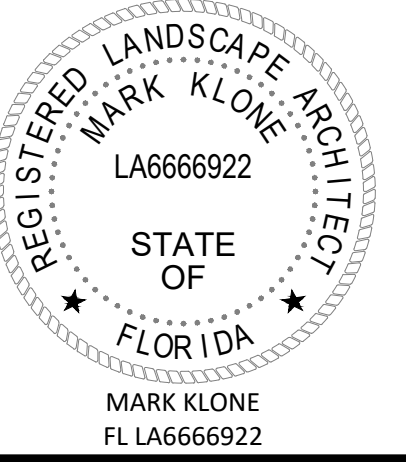

GOLF CLUB OUTDOOR BAR PONTE VEDRA INN & CLUB PONTE VEDRA BEACH, ST. JOHNS COUNTY, FLORIDA

ISSUE DATES

Table with columns: NO., DESCRIPTION, DATE. Multiple empty rows for recording issue dates.

THIS DRAWING IS AN INSTRUMENT OF SERVICE AND THE PROPERTY OF ELM, INC. AND SHALL REMAIN THEIR PROPERTY. THE USE OF THIS DRAWING SHALL BE RESTRICTED TO THE ORIGINAL SITE FOR WHICH IT IS PREPARED, AND PUBLICATION THEREOF IS EXPRESSLY LIMITED TO SUCH USE

PROJ. #: 22-44 DATE: 12.22.2023 DRAWN BY: MCK CHECKED BY: MCK SCALE: AS NOTED

LANDSCAPE SPECIFICATIONS

SHEET NUMBER

L604 Project Status

LAKE VEDRA

PROVIDE AD ALT: REPLACE CANOPY SHADE MATERIAL, PREP & PAINT EXISTING STRUCTURE P-1

SEE LANDSCAPE DRAWINGS FOR SITE MODIFICATIONS

EXISTING GOLF CART PATH
N.I.S.

64'-8" V.I.V.

13'-7 1/2" V.I.F.

EXISTING GOLF CLUBHOUSE
TYPE VB - SPRINKLERED
1-STORY / "B" BUSINESS
12,750 GSF N.I.S.

EXISTING GOLF CART PATH
& CLUBHOUSE DROPOFF
N.I.S.




planning
architecture
landscape architecture
urban design
visual communication

Jacksonville
ELM Studio
1301 Riverplace Boulevard
Suite 1818
Jacksonville, FL 32207
t 904.296.8066

elmplan.com

AA26000604 - LC26000209

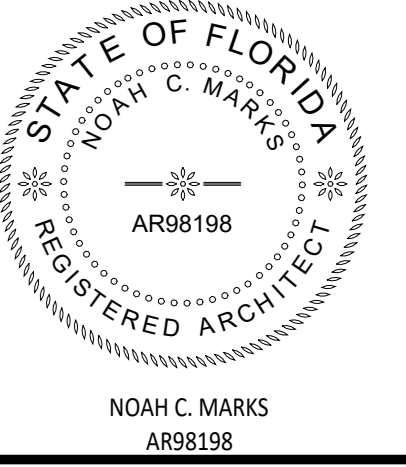

GOLF CLUB PATIO RENOVATION
PONTE VEDRA INN & CLUB
PONTE VEDRA BEACH, FL

ISSUE DATES

NO.	DESCRIPTION	DATE

THIS DRAWING IS AN INSTRUMENT OF SERVICE AND THE PROPERTY OF ELM, INC. AND SHALL REMAIN THEIR PROPERTY. THE USE OF THIS DRAWING SHALL BE RESTRICTED TO THE ORIGINAL SITE FOR WHICH IT IS PREPARED, AND PUBLICATION THEREOF IS EXPRESSLY LIMITED TO SUCH USE.


PROJ. #: 22-44
DATE: 12.22.2023
DRAWN BY: AIW
CHECKED BY:
SCALE: AS NOTED

SITE PLAN

SHEET NUMBER

A100

CONSTRUCTION DOCUMENTS

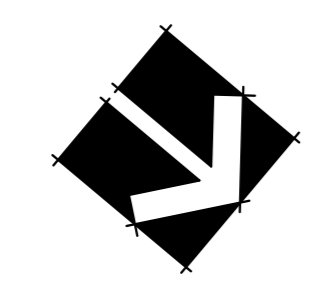

ISSUE DATES

NO.	DESCRIPTION	DATE

THIS DRAWING IS AN INSTRUMENT OF SERVICE AND THE PROPERTY OF ELM, INC. AND SHALL REMAIN THEIR PROPERTY. THE USE OF THIS DRAWING SHALL BE RESTRICTED TO THE ORIGINAL SITE FOR WHICH IT IS PREPARED, AND PUBLICATION THEREOF IS EXPRESSLY LIMITED TO SUCH USE.

PROJ. #:	22-44
DATE:	12.22.2023
DRAWN BY:	AIW
CHECKED BY:	
SCALE:	AS NOTED

DEMO & NEW PLAN

SHEET NUMBER

A101

CONSTRUCTION DOCUMENTS


DEMOLITION NOTES

- DEMOLITION WORK WILL REQUIRE COORDINATION WITH PROPOSED ARCHITECTURAL, STRUCTURAL, AND MEP SYSTEMS. THEREFORE DEMOLITION PLANS MAY NOT REPRESENT OR INCLUDE ALL DEMOLITION REQUIRED. DIMENSIONS SHOWN ARE APPROXIMATE DUE TO VARIATIONS IN EXISTING CONDITIONS AND ARE GIVEN FOR REFERENCE ONLY.
- PRIOR TO COMMENCEMENT OF DEMOLITION, CONTRACTOR SHALL REVIEW LANDSCAPE & ENGINEERING DRAWINGS FOR DESIGN SPECIFICATIONS TO BECOME FAMILIAR WITH THE SITE, AND VERIFY ALL RELEVANT FIELD CONDITIONS. CONTRACTOR SHALL DOCUMENT ASSUMPTIONS REGARDING DEMOLITION ACTIVITIES REQUIRED TO ACHIEVE DESIGN INTENT AND NOTIFY ARCHITECT IMMEDIATELY UPON DISCOVERY OF DISCREPANCIES BETWEEN THESE DRAWINGS AND EXISTING CONDITIONS. EXISTING CONSTRUCTION TO REMAIN WITHIN AND SURROUNDING THE LIMITS OF CONSTRUCTION SHALL BE PROTECTED AS NECESSARY DURING DEMOLITION TO AVOID DAMAGE OR RESTRICTION. CONTRACTOR SHALL BE RESPONSIBLE FOR REPLACING OR REPAIRING ANY ITEMS DAMAGED OR DESTROYED THAT WERE NOT INDICATED AS PART OF THE SCOPE OF DEMOLITION.
- GC TO PROVIDE TEMPORARY SHORING AND STRUCTURAL REINFORCEMENT AS REQUIRED. CONSULT STRUCTURAL ENGINEER AS NECESSARY.
- SEQUENCE DEMOLITION TO MAINTAIN INTEGRITY OF BUILDING ENVELOPE AND PROTECT CONSTRUCTION MATERIALS SENSITIVE TO HUMIDITY. PROVIDE TEMPORARY WEATHERPROOFING WHEN NECESSARY.
- CONTRACTOR SHALL NOTIFY THE ARCHITECT IMMEDIATELY UPON DISCOVERY OF ANY MATERIALS DAMAGED BY WATER INTRUSION. PROVIDE FOR REPAIR AND REPLACEMENT OF DAMAGED MATERIALS.
- CONTRACTOR SHALL NOTIFY THE ARCHITECT IMMEDIATELY SHOULD THE PRESENCE OF HAZARDOUS MATERIALS BE SUSPECTED OR IDENTIFIED DURING THE DEMOLITION ACTIVITIES.


ARCHITECTURAL NOTES

- OPENINGS
- CONTRACTOR SHALL FIELD VERIFY ALL EXISTING WINDOW CONDITIONS AND DIMENSIONS. CONTRACTOR SHALL NOTIFY THE PROJECT COORDINATOR OF ANY DISCREPANCIES PRIOR TO CONSTRUCTION AND FABRICATION. CONTRACTOR TO VERIFY ALL SIZES, TYPES AND QUANTITIES.
 - DOOR SIDELITE SIZING SHALL BE BASED ON THE DEMOLISHED WINDOW BAY. WINDOWS ARE SUBJECT TO VERIFICATION IN THE FIELD BY THE CONTRACTOR. VERIFICATION OF OPENING SIZES, REQUIRED FRAMING AND SUBMITTAL OF SHOP DRAWINGS AND REVIEW BY CONTRACTING OFFICER SHALL BE MADE PRIOR TO THE ORDERING, FABRICATION AND INSTALLATION OF DOORS, WINDOWS AND WINDOW MODIFICATIONS.
 - CONTRACTOR TO PROVIDE ADD ALTERNATIVE FOR THE FOLLOWING SCOPE: FULL HEIGHT DINING ROOM WINDOWS REQUIRE WOOD ROT INVESTIGATION AND RESTORATION INCLUSIVE OF ALL SILLS, JAMBES, AND HEADERS. CONTRACTOR SHALL REMOVE AND REINSTALL OR REPLACE ALL WINDOW COMPONENTS AND HARDWARE TO MATCH EXISTING FINISH AND OPERATIONAL FUNCTIONALITY. WOOD ROT ADJACENT TO WINDOWS & DOORS SHALL BE REPLACED AND FINISHED TO MATCH EXISTING.
 - CONTRACTOR TO PROVIDE ADD ALTERNATIVE FOR THE FOLLOWING SCOPE: ONE (01) WEATHERPROOF LOCKABLE TV CABINET, UV PROTECTED ANTI-REFLECTIVE FRONT GLASS, ONBOARD THERMOSTAT REGULATED ONBOARD FAN, VESA MOUNT COMPATIBLE. PROVIDE 120V DUPLEX AND DATA TO EACH LOCATED ABOVE FIREPLACE. CONTRACTOR TO PROVIDE CABINET, MOUNTING EQUIPMENT. TV OWNER PROVIDED. SPECIFICATIONS TO BE COORDINATED WITH OWNER. PAINT/FINISH FINISH ALL EXPOSED EXISTING MATERIAL AFFECTED BY THE WORK AND ALL NEW WORK. CONTRACTOR SHALL SEAL ALL PENETRATIONS AROUND NEW AND EXISTING DOOR & WINDOW FRAMES PRIOR TO PAINTING WORK.
 - CONTRACTOR SHALL ENSURE THAT THE WEATHER-TIGHT BUILDING ENVELOPE IS MAINTAINED IN THE CASE OF INCLEMENT WEATHER AND FOR SECURITY PURPOSES. CONTRACTOR TO ENSURE ALL PRODUCTS HAVE FLORIDA PRODUCT APPROVAL.

MARK	DESCRIPTION	MANUFACTURER	MODEL	COLOR
FINISH SCHEDULE				
P-1	PAINT	BENJAMIN MOORE	SATIN	SILHOUETTE AF-655
P-2	PAINT	BENJAMIN MOORE	SATIN	MATCH EXISTING EXTERIOR TRIM
P-3	PAINT	TBD	WOOD STAIN	MATCH EXISTING INTERIOR TRIM

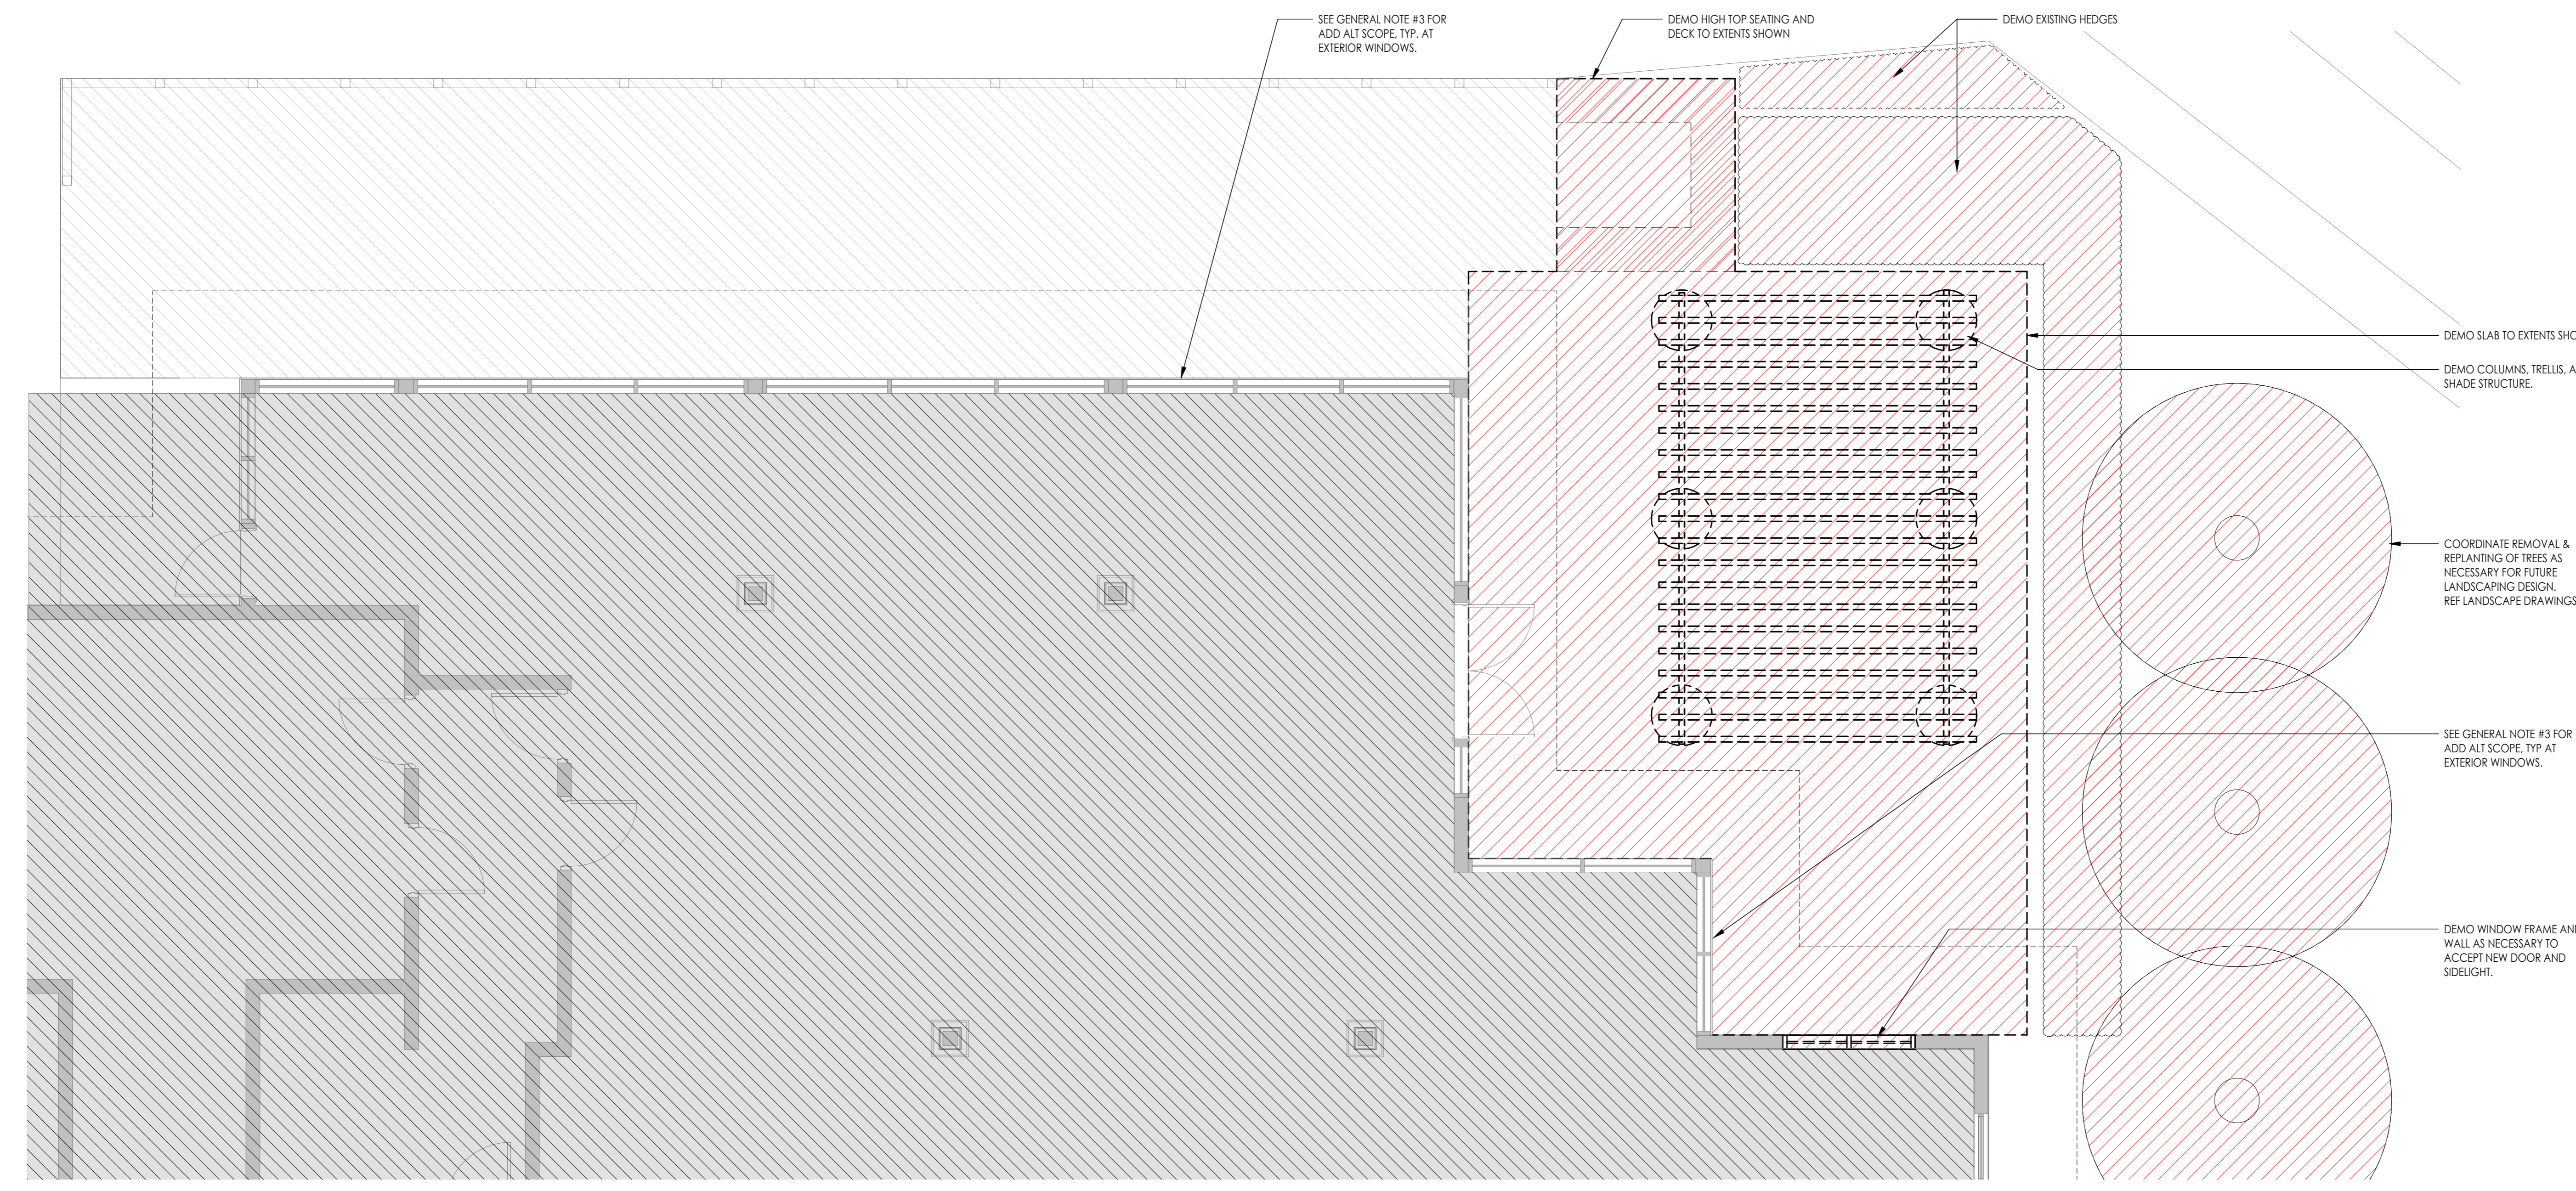

2 DEMO - OVERALL FLOOR PLAN
1/4" = 1'-0"

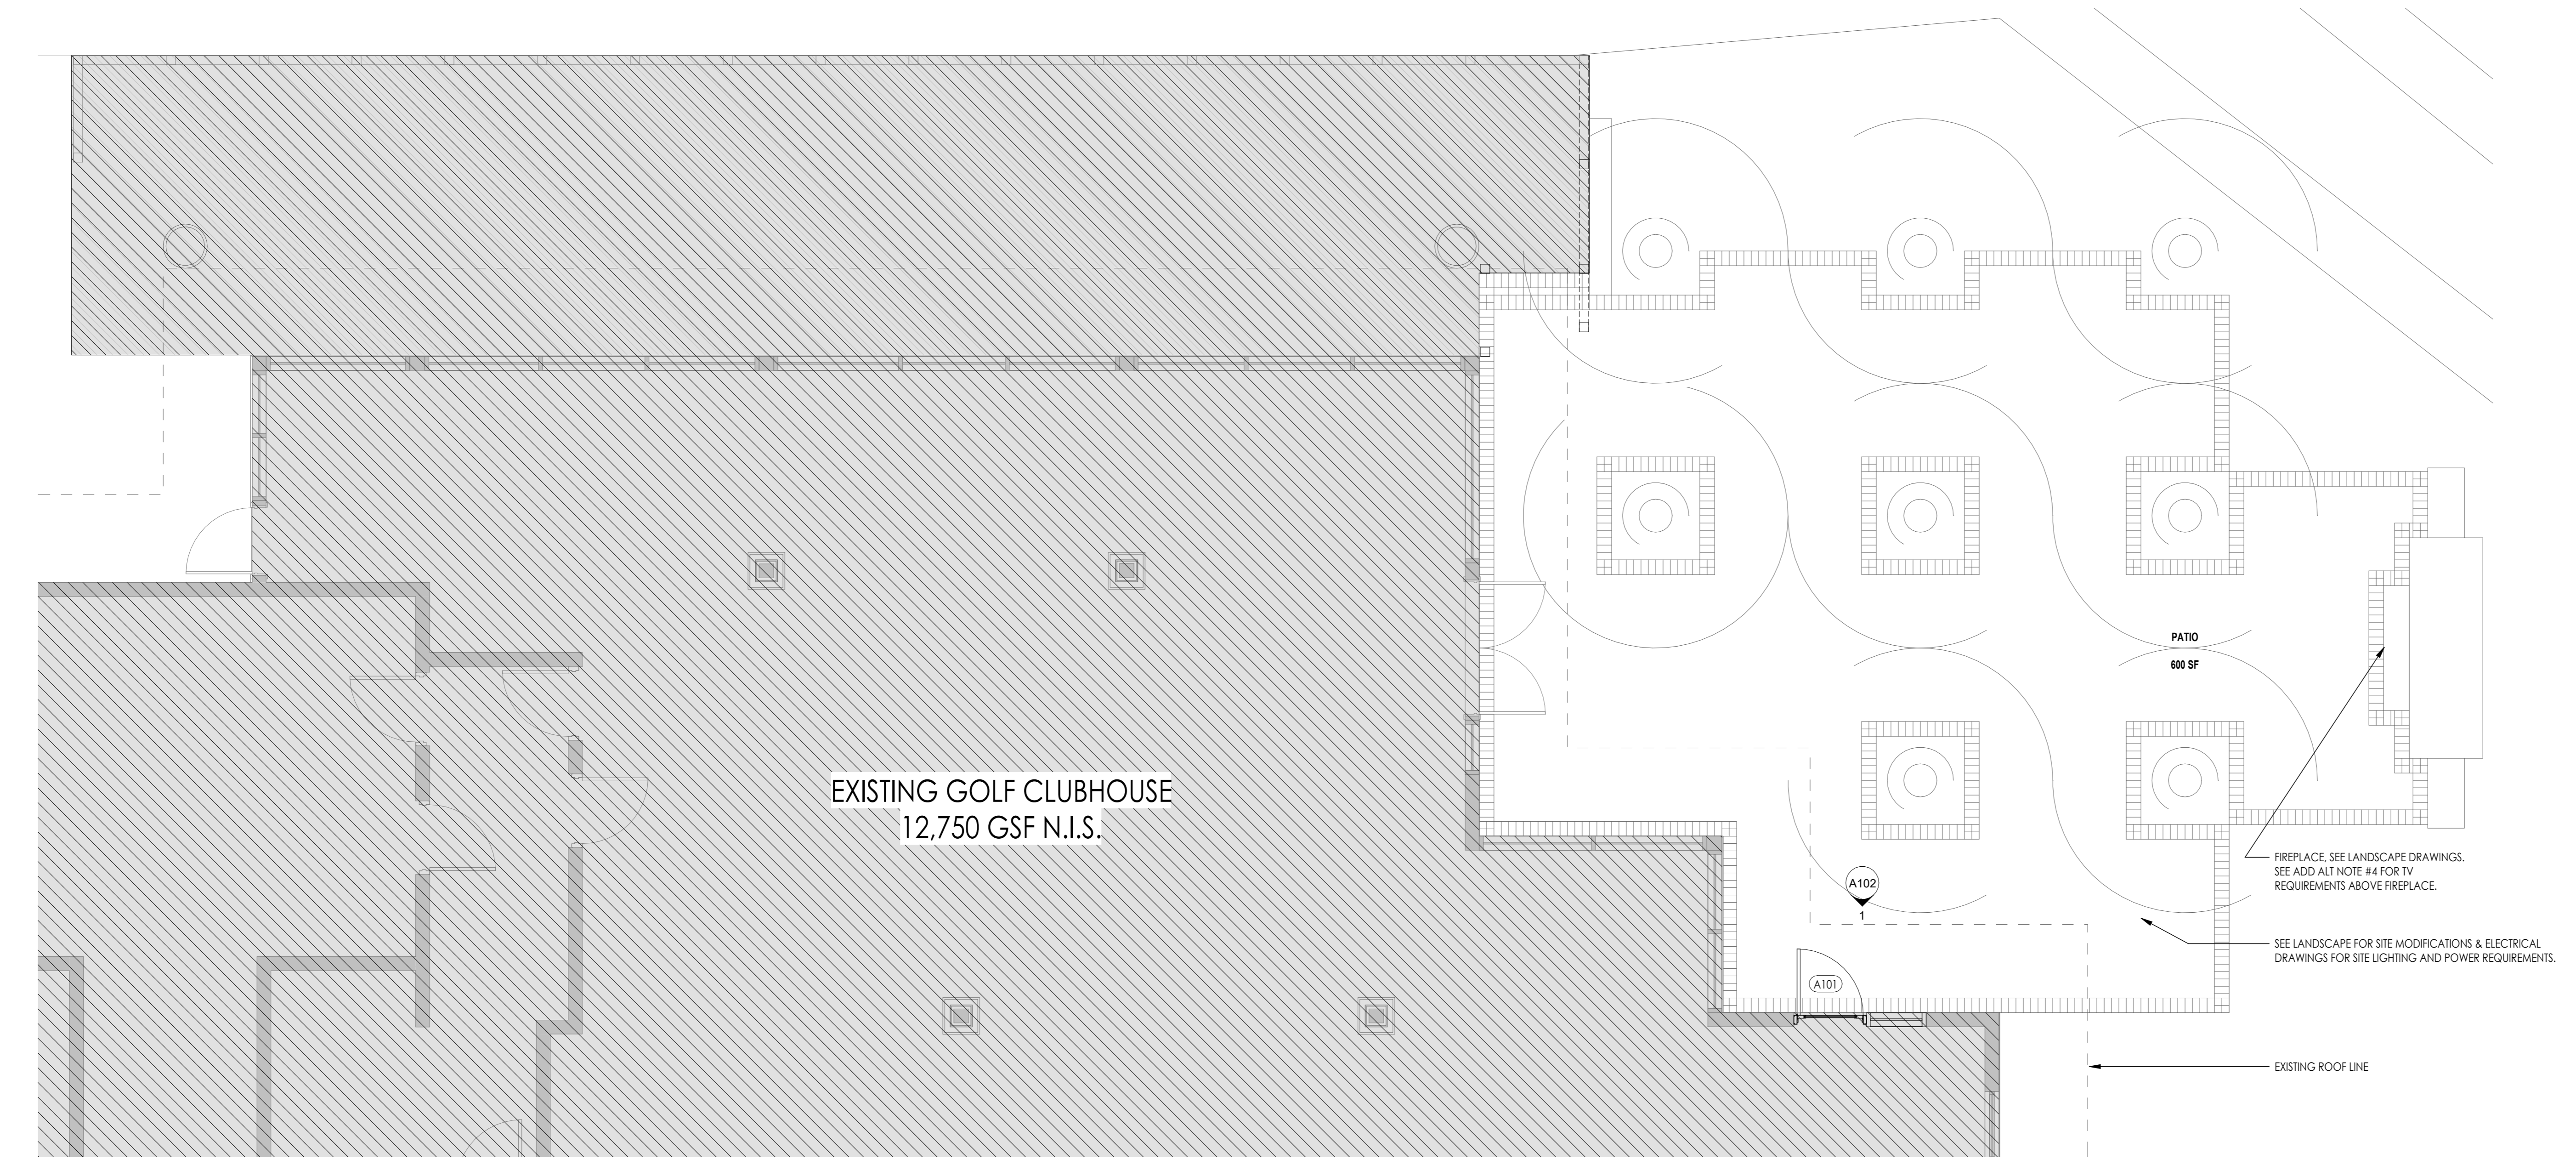

1 NEW - OVERALL FLOOR PLAN OPTION 1
1/4" = 1'-0"




planning
architecture
landscape architecture
urban design
visual communication

Jacksonville
ELM Studio
1301 Riverplace Boulevard
Suite 1818
Jacksonville, FL 32207
t 904.296.8066

elmplanning.com

AA26000604 - LC26000209

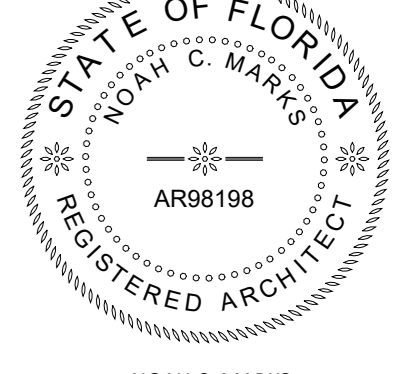

NOAH C. MARKS
AR98198

GOLF CLUB PATIO RENOVATION
 PONTE VEDRA INN & CLUB
 PONTE VEDRA BEACH, FL

ISSUE DATES

NO.	DESCRIPTION	DATE

THIS DRAWING IS AN INSTRUMENT OF SERVICE AND THE PROPERTY OF ELM, INC. AND SHALL REMAIN THEIR PROPERTY. THE USE OF THIS DRAWING SHALL BE RESTRICTED TO THE ORIGINAL SITE FOR WHICH IT IS PREPARED, AND PUBLICATION THEREOF IS EXPRESSLY LIMITED TO SUCH USE.

PROJ. #: 22-44
DATE: 12.22.2023
DRAWN BY: AJW
CHECKED BY:
SCALE: AS NOTED

DETAILS


SHEET NUMBER

A102


CONSTRUCTION DOCUMENTS

DOOR TYPES		FRAME TYPES		DOOR SCHEDULE						
MARK	WIDTH	HEIGHT	THICKNESS		TYPE	MATERIAL	LEAVES	FINISH	TYPE	MATERIAL
A	3'-0"	7'-6"	1 3/4"	A	AL/GL	1	MATCH EXISTING	1	AL	MATCH EXISTING


Hardware: FULL MONITESE HINGES, SINGLE BAR PUSH/PULL SET, CYLINDER LOCK, SURFACE CLOSER, THRESHOLD, GASKETING, RAIN GUARD, SWEEP
 DOOR TO BE UNLOCKED DURING BUSINESS HOURS. DOOR NOT USED AS PATH OF EGRESS.
 ADA THRESHOLD REQUIRED.

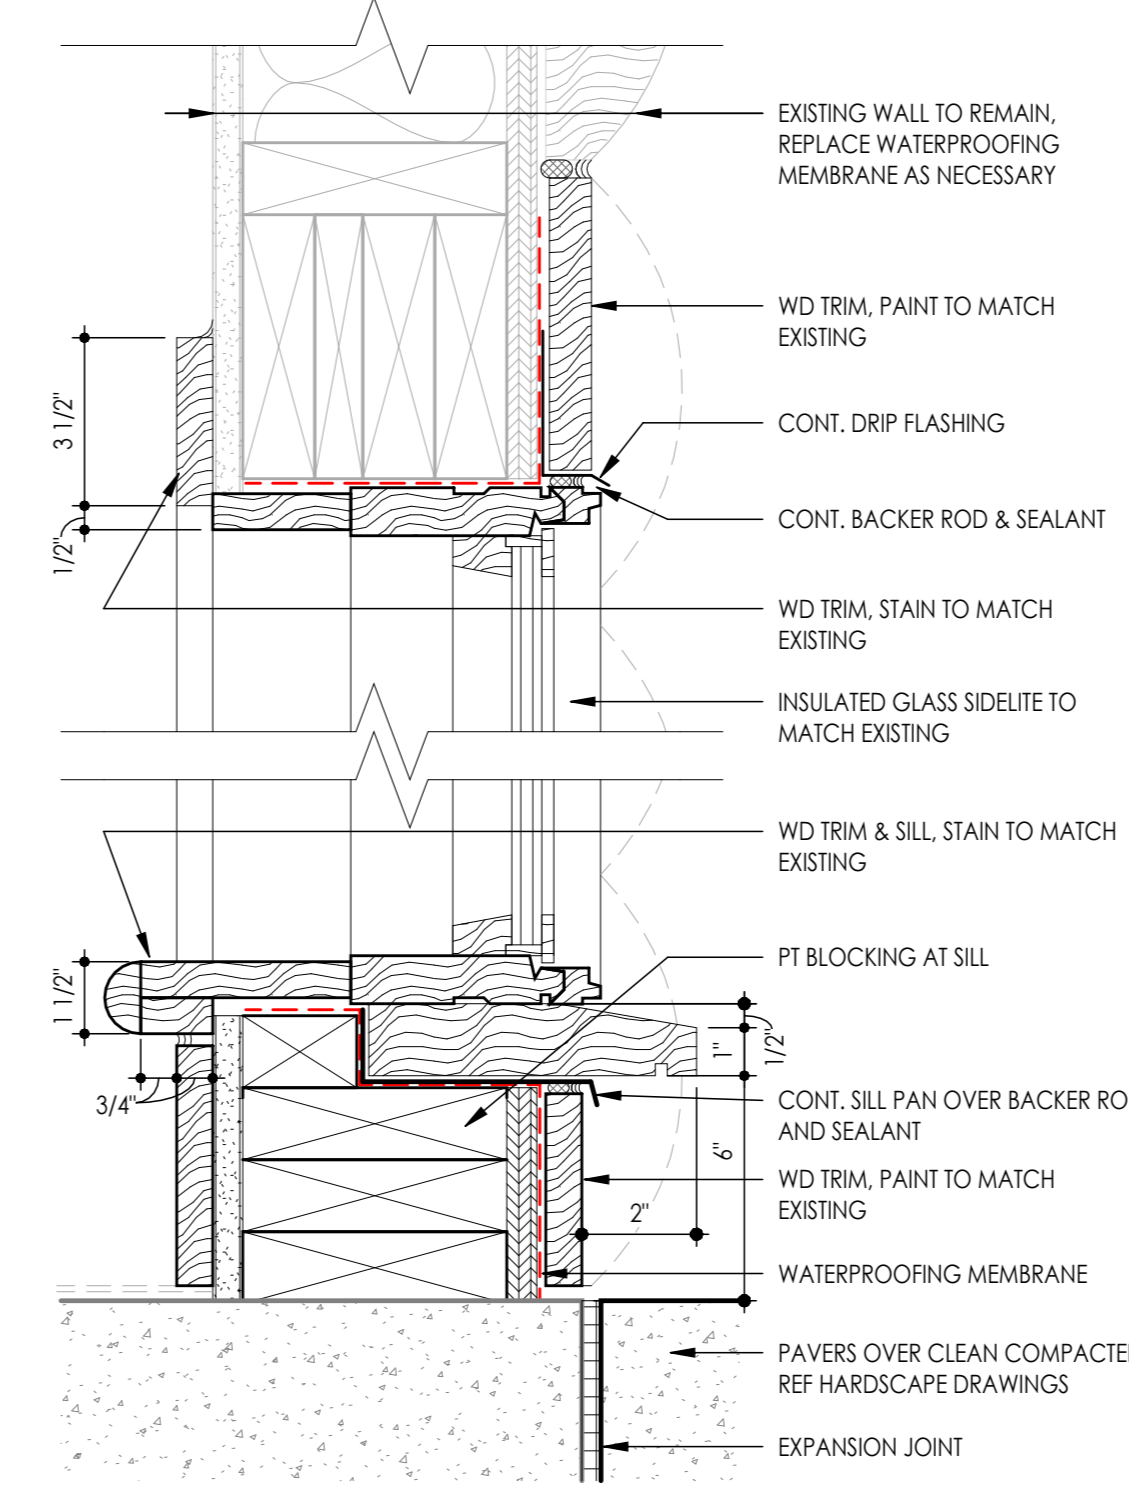


3 SECTION DETAIL AT EXTERIOR WINDOW
3" = 1'-0"

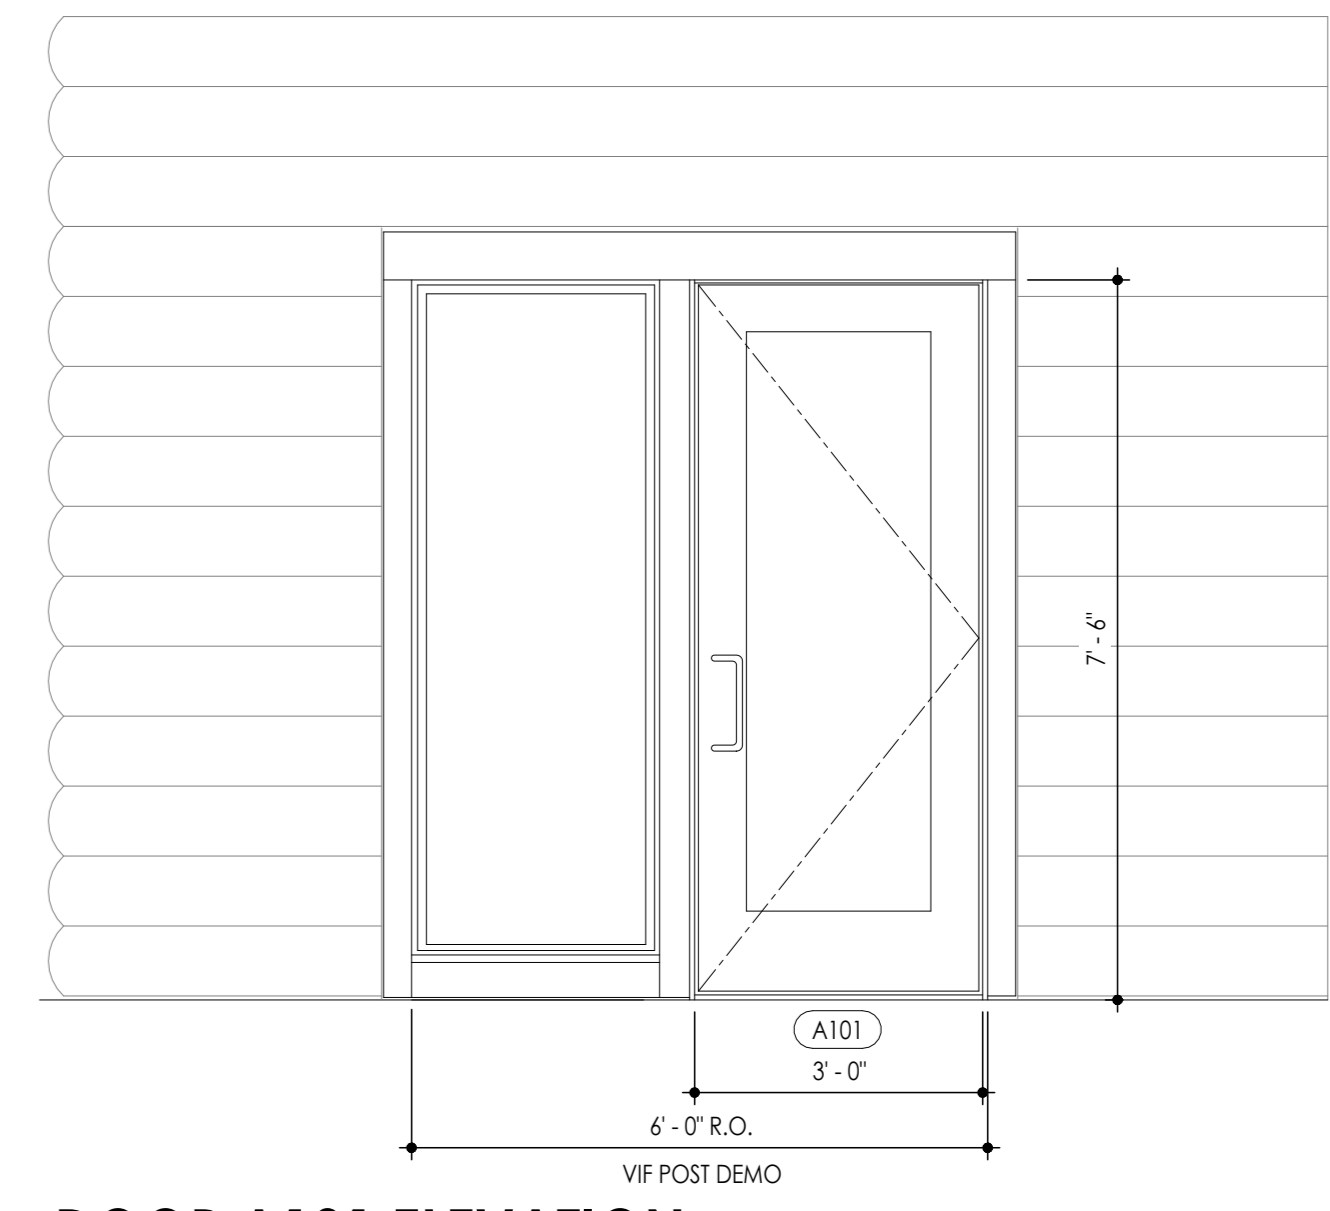

1 DOOR A101 ELEVATION
1/2" = 1'-0"

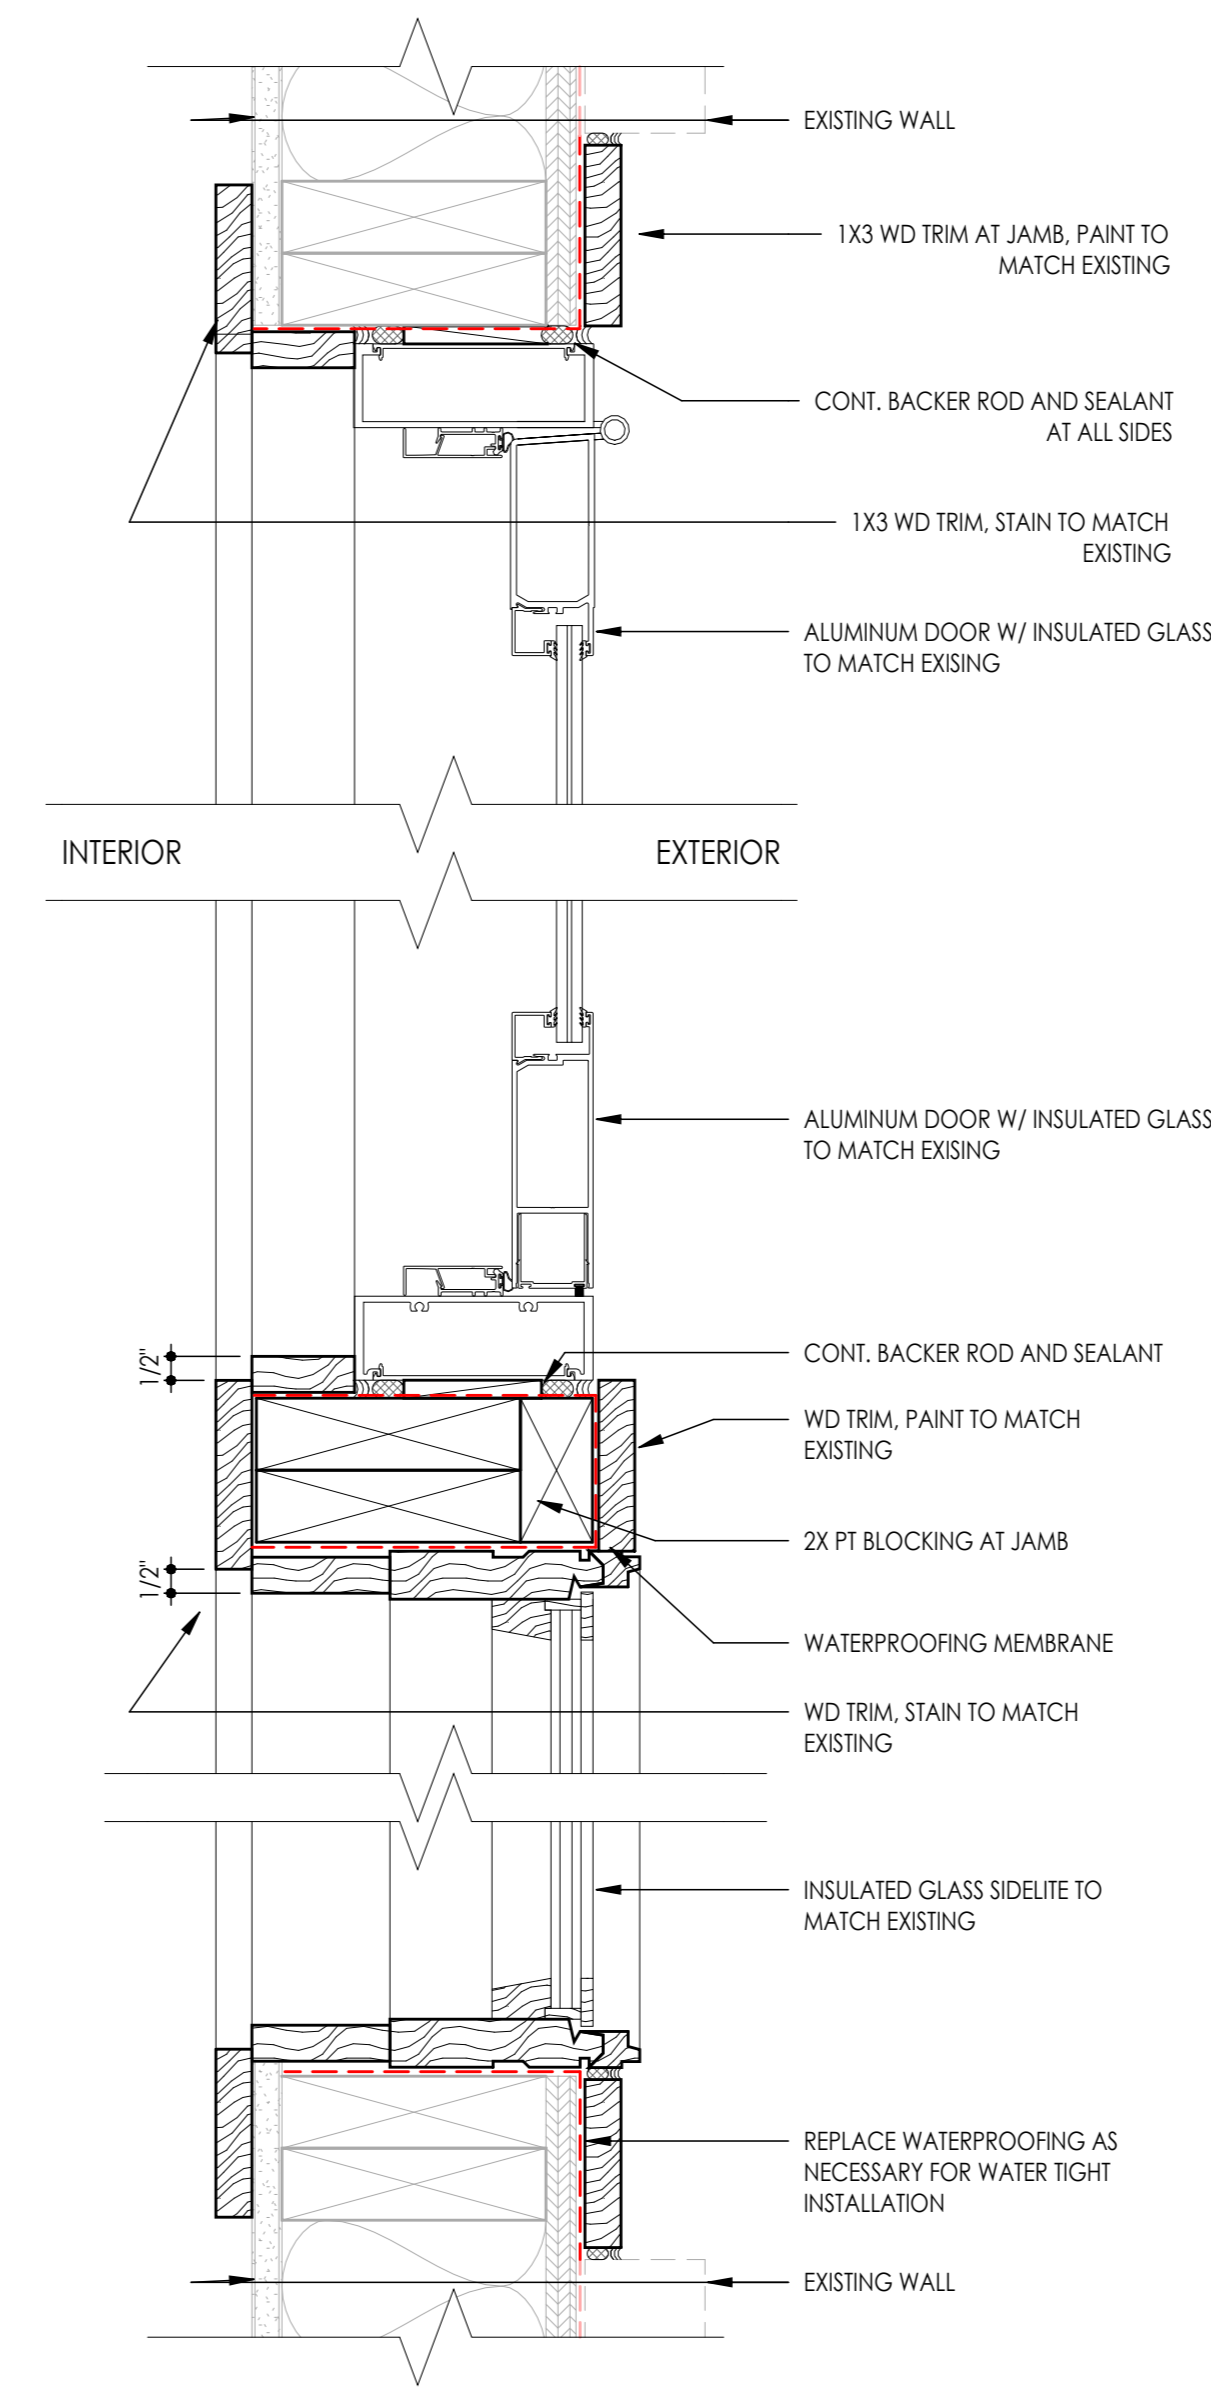

4 PLAN DETAIL AT EXTERIOR DOOR & WINDOW JAMB
3" = 1'-0"

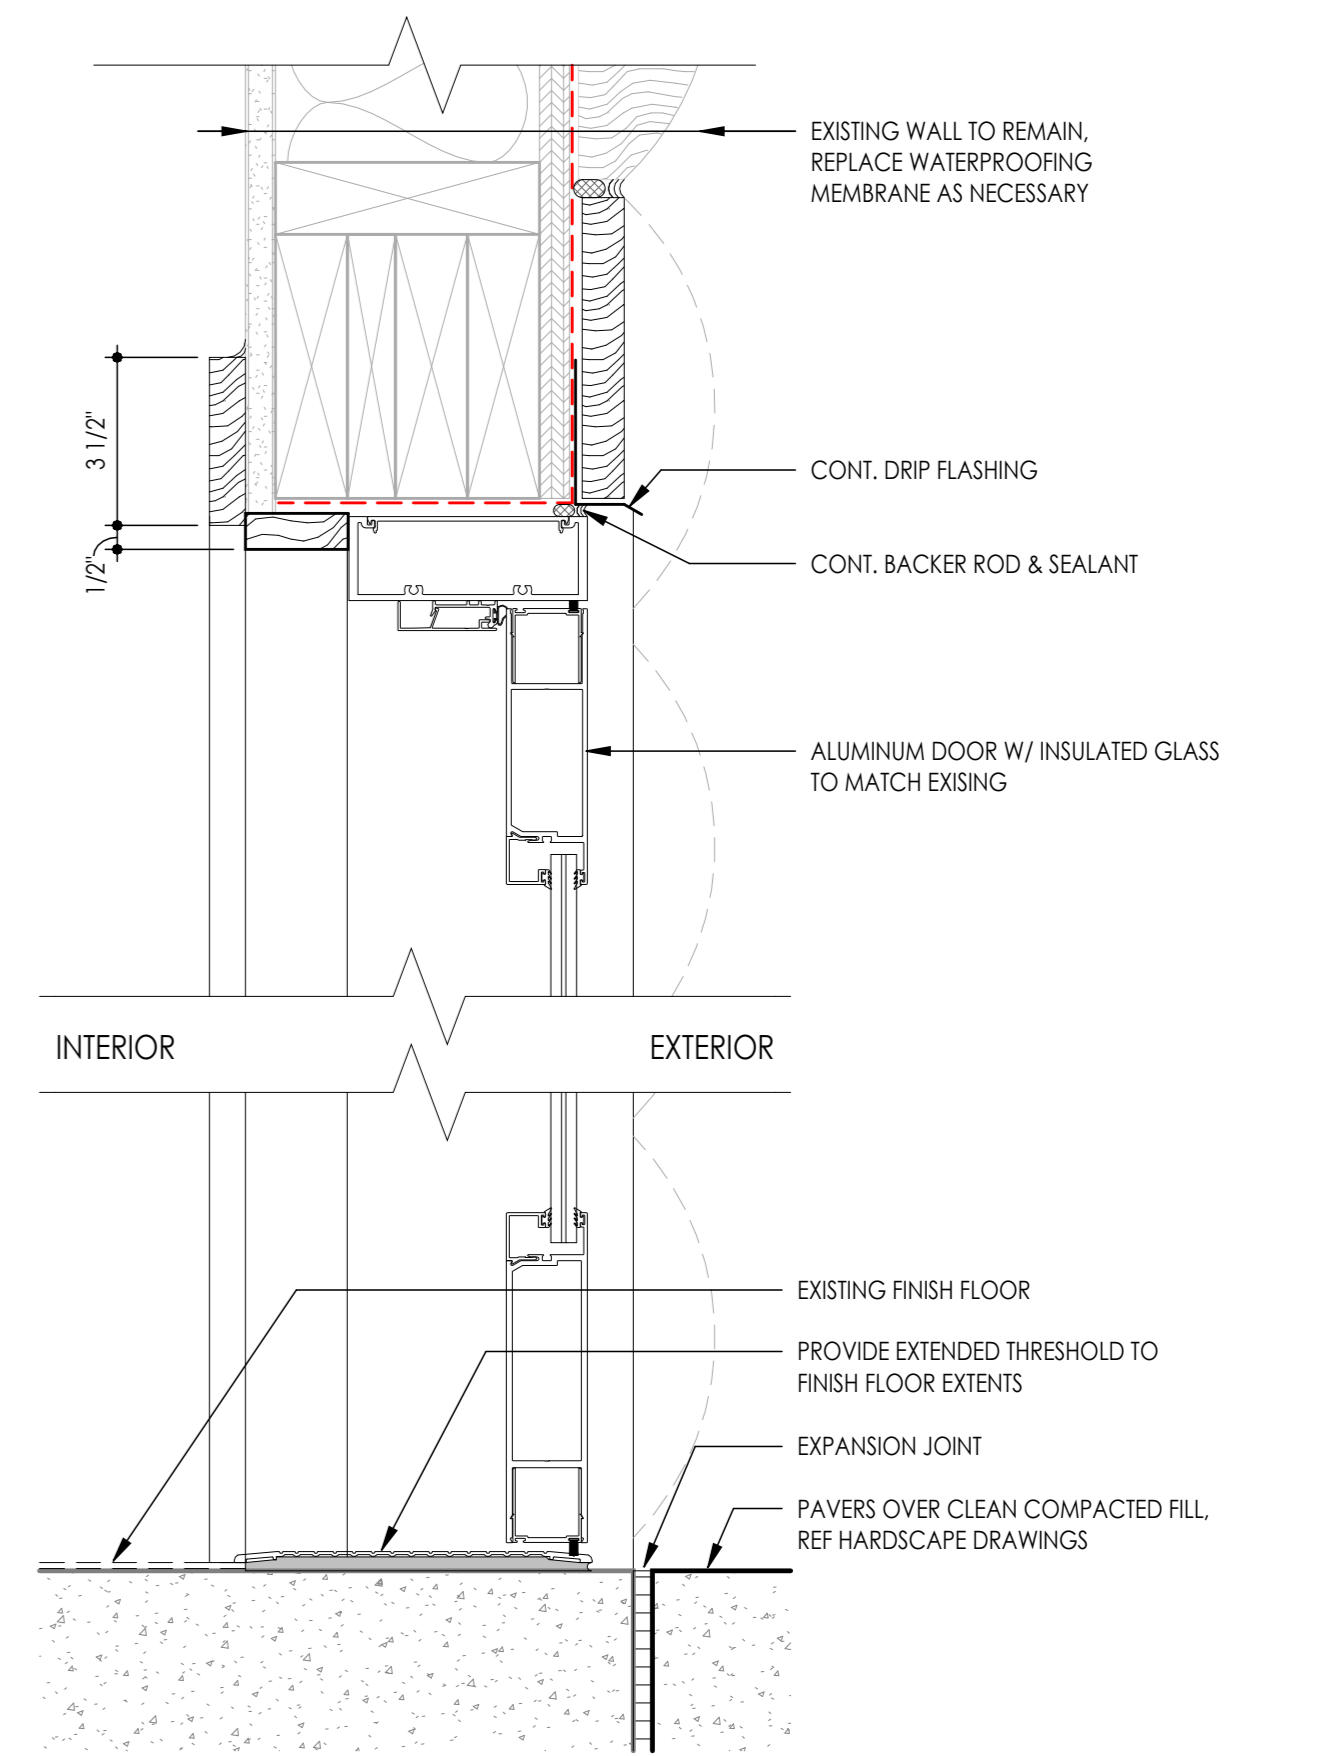


2 SECTION DETAIL AT EXTERIOR DOOR
3" = 1'-0"

12/13/2023 1:37:26 PM

"TO THE BEST OF THE ARCHITECT'S OR ENGINEER'S KNOWLEDGE, THE PLANS AND SPECIFICATIONS COMPLY WITH THE APPLICABLE MINIMUM BUILDING CODES AND THE APPLICABLE FIRE-SAFETY STANDARDS AS DETERMINED BY THE LOCAL AUTHORITY IN ACCORDANCE WITH THIS SECTION AND CHAPTER 633, FLORIDA STATUTES."

PLUMBING SHEET INDEX

SHEET NO.	SHEET TITLE
P101	PLUMBING FLOOR PLAN
P201	LEGEND, SCHEDULE & MISC. DETAILS.

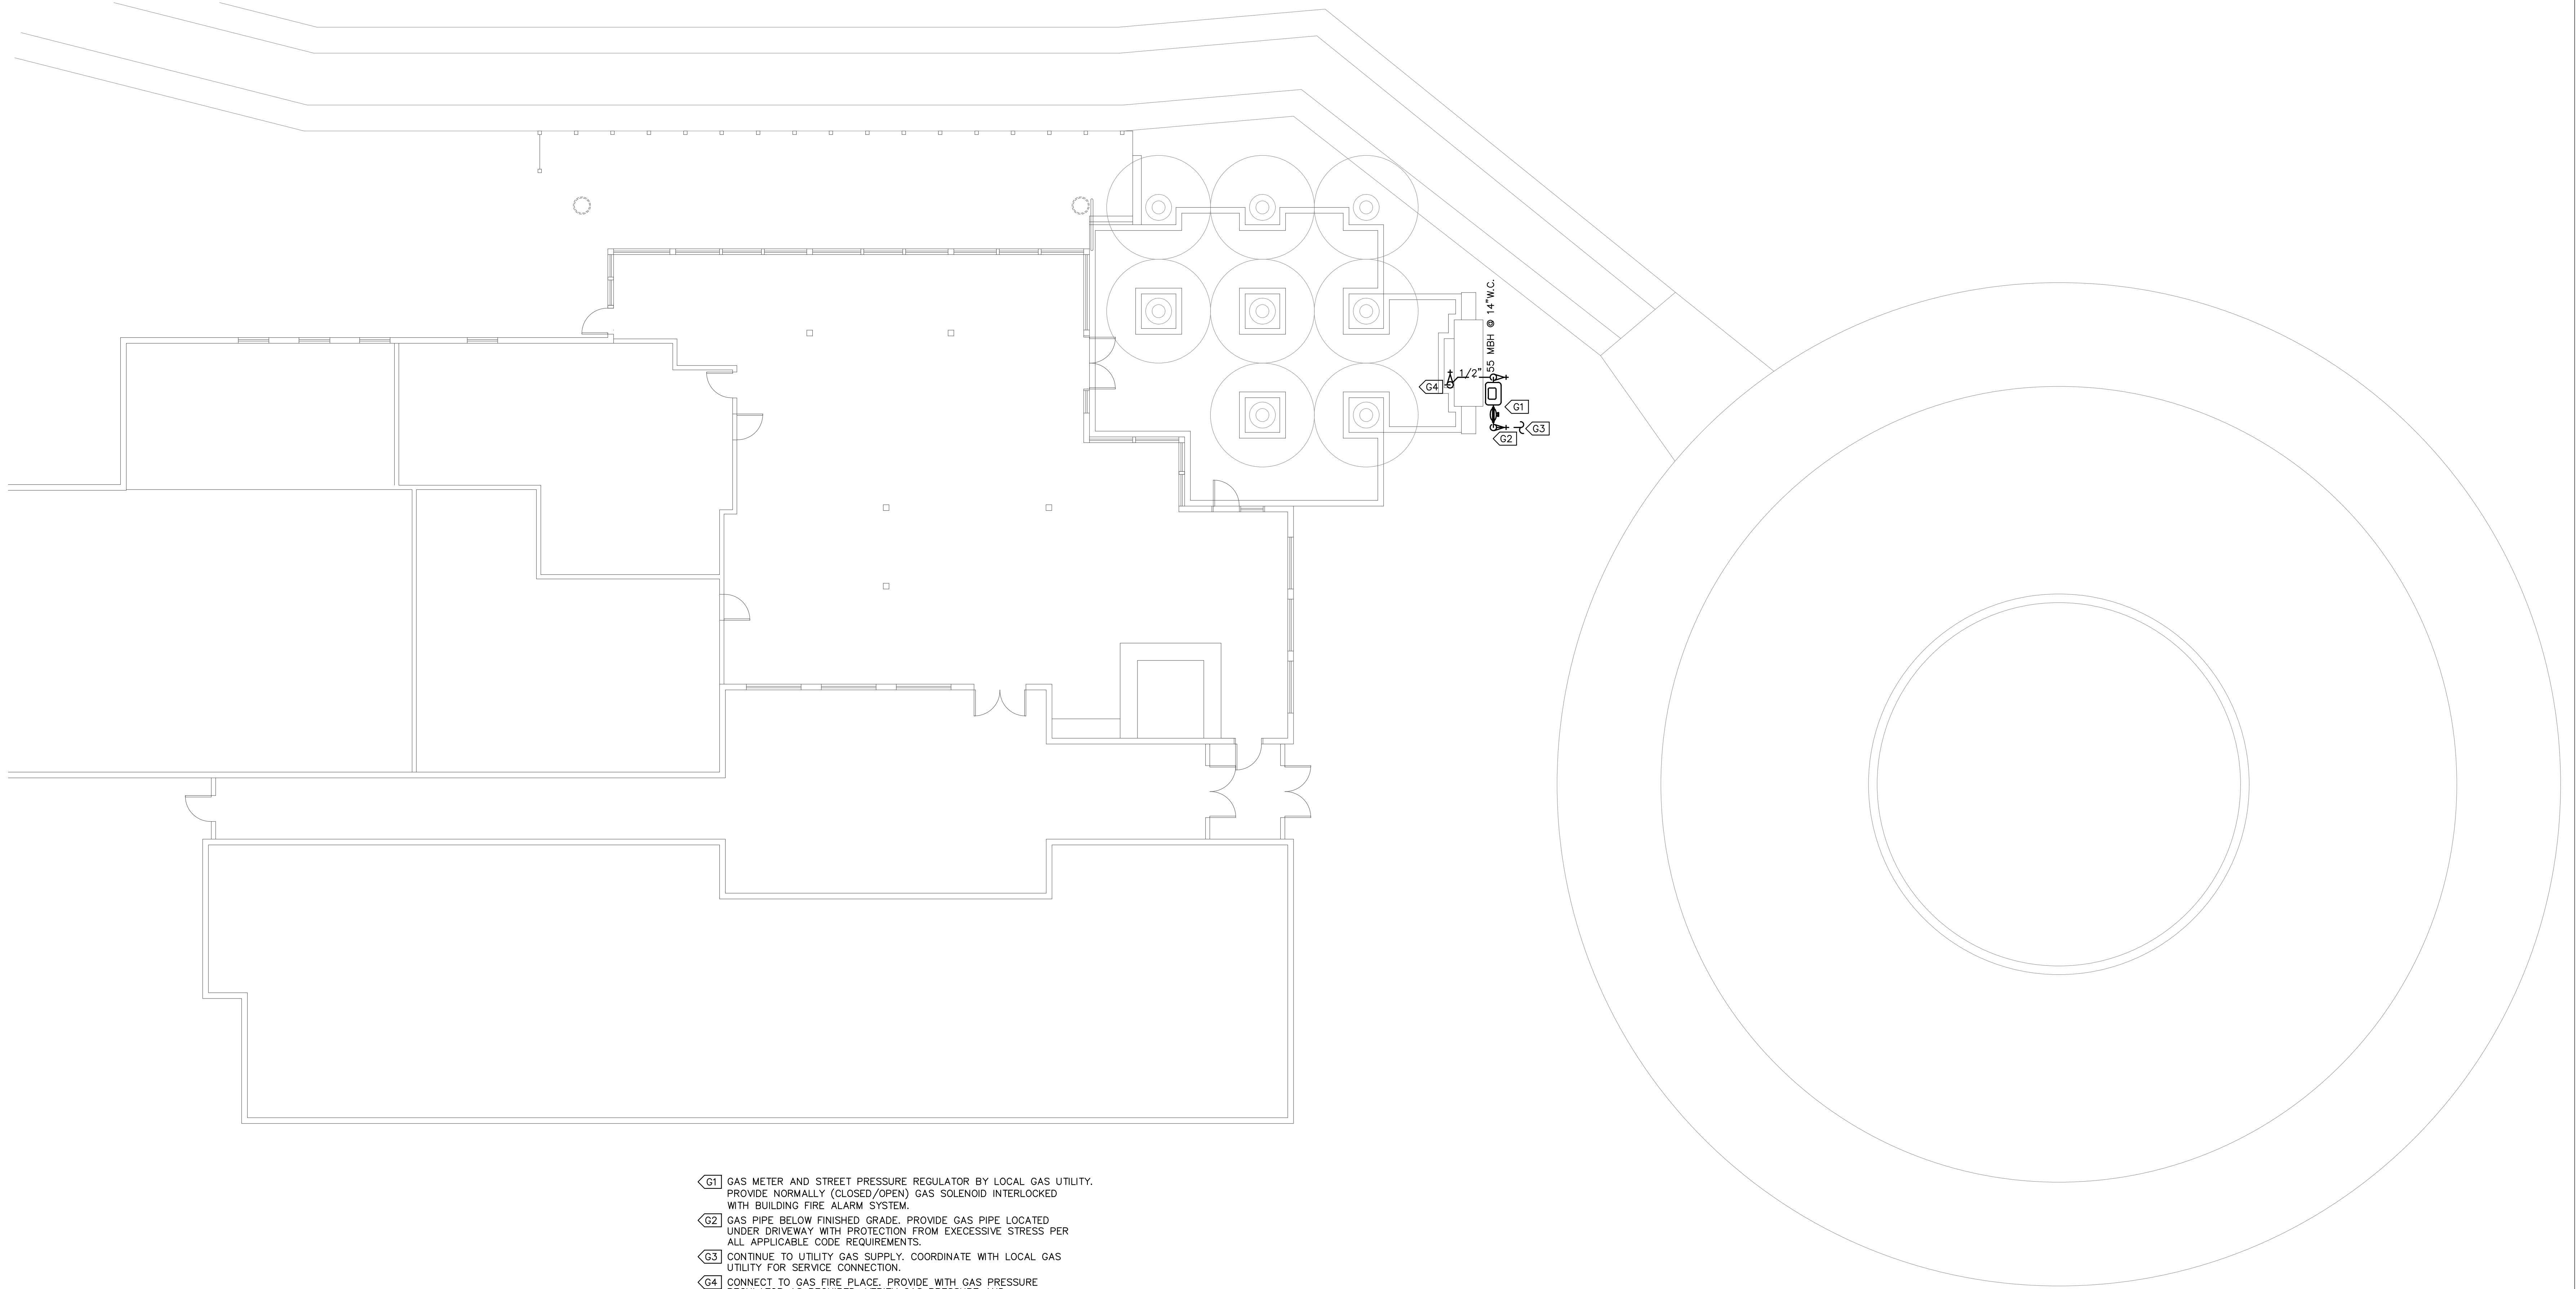

- G1 GAS METER AND STREET PRESSURE REGULATOR BY LOCAL GAS UTILITY. PROVIDE NORMALLY (CLOSED/OPEN) GAS SOLENOID INTERLOCKED WITH BUILDING FIRE ALARM SYSTEM.
- G2 GAS PIPE BELOW FINISHED GRADE. PROVIDE GAS PIPE LOCATED UNDER DRIVEWAY WITH PROTECTION FROM EXCESSIVE STRESS PER ALL APPLICABLE CODE REQUIREMENTS.
- G3 CONTINUE TO UTILITY GAS SUPPLY. COORDINATE WITH LOCAL GAS UTILITY FOR SERVICE CONNECTION.
- G4 CONNECT TO GAS FIRE PLACE. PROVIDE WITH GAS PRESSURE REGULATOR AS REQUIRED. VERIFY GAS PRESSURE AND CONNECTION REQUIREMENTS WITH EQUIPMENT MANUFACTURER.

PLUMBING SITE PLAN
SCALE: 1/8" = 1'-0"

PONTE VEDRA INN & CLUB
GOLF CLUB PATIO RENOVATION
 PONTE VEDRA BEACH, FL

ISSUE DATES		
NO.	DESCRIPTION	DATE

THIS DRAWING IS AN INSTRUMENT OF SERVICE AND THE PROPERTY OF ELM, INC. AND SHALL REMAIN THEIR PROPERTY. THE USE OF THIS DRAWING SHALL BE RESTRICTED TO THE ORIGINAL SITE FOR WHICH IT IS PREPARED, AND PUBLICATION THEREOF IS EXPRESSLY LIMITED TO SUCH USE.

PROJ. #: 12-44
DATE: 12.22.2023
DRAWN BY: CJF
CHECKED BY: LRH
SCALE: AS NOTED

**PLUMBING
SITE
PLAN**

SHEET NUMBER
P101

 POWELL & HINKLE ENGINEERING, P.A. 1409 KINGSLEY AVENUE, BLDG 12A ORANGE PARK, FLORIDA 32073 (904) 264-5570 FAX:(904) 278-2646	ROBERT L. HINKLE	PE	29302
	GALTON C. MOK	PE	33192
	LANE R. HINKLE	PE	48076
	THOMAS M. ELDER	PE	56121
	RICHARD A. MATHEWS	PE	59418
	DAVID R. SPELL JR.	PE	64729
	JAMES L. HENNESSEY	PE	83241

12/7/23
3813P101

PLUMBING SPECIFICATIONS

- SCOPE: PROVIDE A COMPLETE PLUMBING SYSTEM AS SHOWN ON DRAWINGS AND MEETING REQUIREMENTS OF APPLICABLE STATE AND LOCAL CODES. OBTAIN ALL REQUIRED PERMITS AND CERTIFICATES.
- GUARANTEE: PROVIDE ALL NEW MATERIALS AND EQUIPMENT, AND GUARANTEE SAME AGAINST DEFECTS FOR A PERIOD OF ONE YEAR FROM DATE OF ACCEPTANCE. AS FAR AS PRACTICAL, SIMILAR PRODUCTS SHALL BE BY ONE MFG.
- CUTTING & PATCHING: ASSUME LIABILITY FOR CUTTING AND PATCHING. COORDINATE WITH BUILDING ENGINEER AND REVIEW EXISTING STRUCTURAL PLANS PRIOR TO ANY CUTTING OR CORE DRILLING. PROVIDE REQUIRED CHASES, SLOTS AND OPENINGS FOR REQUIRED PIPE SLEEVES THROUGH WALLS. CUT CONCRETE FLOOR SLAB WHERE REQUIRED FOR LOCATION OF UNDER FLOOR SANITARY PIPING. COMPLETE ALL BACKFILL OF EXCAVATIONS AND COMPLETE ALL CONCRETE FLOOR SLAB WORK, INCLUDING AREAS LEFT OPEN FOR FUTURE SERVICE CONNECTIONS, TO MATCH SURROUNDING FLOOR LEVEL AND FINISH.
- FIXTURES: SHALL BE AS SCHEDULED ON THE DRAWINGS. FIXTURE TRIM AND FITTINGS SHALL BE C.P. BRASS INCLUDING PIPING SERVING FIXTURES EXPOSED BEYOND FACE OF FINISHED WALL. PROVIDE STOPS IN WATER SUPPLIES TO EACH AND EVERY FIXTURE. FIXTURE MOUNTING HEIGHT SHALL BE AS SHOWN ON THE ARCH. DRAWINGS.
- CONNECTIONS TO EQUIPMENT FURNISHED AND INSTALLED BY OTHERS: COMPLETE ALL ROUGH-IN AND FINAL CONNECTIONS TO LAVATORY AND SHOP EQUIPMENT FURNISHED AND INSTALLED BY OTHERS. SEE ARCHITECTURAL DRAWINGS FOR DETAILS OF EQUIPMENT AND LOCATION.
- GAS PIPING: GAS PIPING ABOVE GRADE SHALL BE SCHEDULE 40 BLACK STEEL WITH BLACK 150 POUND MALLEABLE IRON SCREW FITTINGS. BELOW GRADE PIPING OUTSIDE BUILDING SHALL BE SCHEDULE 80 BLACK STEEL PROTECTED BY APPROVED COAL TAR SHELLAC WITH COAL TAR BASE WRAPPING. BELOW GRADE PIPING INSIDE BUILDING SHALL BE INSTALLED IN SCHEDULE 40 BLACK STEEL CONDUIT VENTED TO EXTERIOR OF BUILDING. CONDUIT SHALL BE PROTECTED BY APPROVED COAL TAR SHELLAC WITH COAL TAR BASE WRAPPING.
- PIPE HANGERS: PIPE HANGERS SHALL BE GALVANIZED STEEL CLEVIS HANGERS SELECTED WITHIN THE MANUFACTURER'S PUBLISHED LOAD RATINGS AND SHALL BE AUTO-GRIP, FEE AND MASON, OR GRNELL. HANGERS FOR COPPER PIPE SHALL BE EITHER COPPER-PLATED TYPE OR THERE SHALL BE A SHIELD OF 4 POUNDS SHEET LEAD TO COMPLETELY SURROUND THE PIPE TO PREVENT DIRECT CONTACT WITH THE HANGER. SUPPORTS FOR PIPES WITH VAPOR BARRIER TYPE COVERING SHALL NOT CONTACT THE PIPE BUT SHALL SURROUND THE UNBROKEN COVERING. PROVIDE GALVANIZED STEEL SHIELDS WITH MITERED CORNERS PROPERLY FORMED TO THE JACKET OUTSIDE DIAMETER BETWEEN HANGER CLEVISES AND THE LOWER 1/3 OF THE CIRCUMFERENCE.
- SECONDARY PIPE SUPPORTS: MAKESHIFT, FIELD DEVISED METHODS OF PLUMBING PIPE SUPPORT, SUCH AS WITH THE USE OF SCRAP FRAMING MATERIALS, ARE NOT ALLOWED. SUPPORT AND POSITIONING OF PIPING SHALL BE BY MEANS OF ENGINEERED METHODS THAT COMPLY WITH IAPMO PS 42-96. THESE SHALL BE HUBBARD ENTERPRISES/HOLDRITE SUPPORT SYSTEMS OR OWNER-APPROVED EQUIVALENT. FOR PLENUM APPLICATIONS USE PIPE SUPPORTS THAT MEET ASTM E-84 25/50 STANDARDS, SUCH AS THE HUBBARD ENTERPRISES/HOLDRITE FLAME FIGHTER™ OR OWNER-APPROVED EQUIVALENT. FOR VERTICAL MID-SPAN SUPPORTS OF PIPING 4" AND UNDER, USE HUBBARD ENTERPRISES/HOLDRITE STOUT BRACKETS™ WITH HUBBARD ENTERPRISES/HOLDRITE STOUT CLAMPS OR TWO-HOLE PIPE CLAMPS (MSS TYPE 26).
- PIPE SLEEVES: PROVIDE PIPE SLEEVES OR CORE BORE FOR ALL PIPES PASSING THROUGH CONCRETE OR MASONRY WALLS. SLEEVES THROUGH FLOOR SLABS OR FIRE WALLS SHALL BE GALVANIZED STEEL PIPE OF PROPER SIZE. FILL ALL SPACES BETWEEN PIPING AND SLEEVES PASSING THROUGH FIRE-RATED WALLS, FLOORS, OR CEILING WITH MATERIAL CAPABLE OF MAINTAINING THE FIRE-RESISTANCE RATING OF THE WALL, FLOOR OR CEILING. USE METACALK 9500W-1 OR APPROVED EQUAL CAULKING MATERIAL FOR PVC AND CPVC PIPING.
- ESCUTCHEONS: PROVIDE ESCUTCHEONS ON ALL FINISHED SURFACES WHERE PIPING PENETRATE. FASTEN SECURELY TO PIPE OR PIPE COVERING.
- TESTING: TEST ALL GAS PIPING AFTER OUTLET FITTINGS ARE CONNECTED AND ENTIRE PIPING SYSTEM HAS BEEN CLEANED. PRESSURIZE THE SYSTEM WITH COMPRESSED AIR TO A PRESSURE OF 1.5 TIMES THE OPERATING PRESSURE OR 125 PSIG, WHICHEVER IS HIGHER. HOLD TEST PRESSURES FOR AT LEAST 2 HOURS. REMAKE ALL LEAKING JOINTS AND RE-TEST. THESE TESTS ARE MINIMUM AND ARE NOT INTENDED TO BE LIMITING WHERE ADDITIONAL TESTING METHODS ARE REQUIRED BY GOVERNING AUTHORITY. TEST EACH FIXTURE FOR SOUNDNESS, STABILITY OF SUPPORT, AND SATISFACTORY OPERATION OF ALL ITS PARTS.

GAS RISER DIAGRAM
SCALE: 1/8" = 1'-0"


- G1 GAS METER AND STREET PRESSURE REGULATOR BY LOCAL GAS UTILITY. PROVIDE NORMALLY (CLOSED/OPEN) GAS SOLENOID INTERLOCKED WITH BUILDING FIRE ALARM SYSTEM.
- G2 GAS PIPE BELOW FINISHED GRADE. PROVIDE GAS PIPE LOCATED UNDER DRIVEWAY WITH PROTECTION FROM EXCESSIVE STRESS PER ALL APPLICABLE CODE REQUIREMENTS.
- G3 CONTINUE TO UTILITY GAS SUPPLY. COORDINATE WITH LOCAL GAS UTILITY FOR SERVICE CONNECTION.
- G4 CONNECT TO GAS FIRE PLACE. PROVIDE WITH GAS PRESSURE REGULATOR AS REQUIRED. VERIFY GAS PRESSURE AND CONNECTION REQUIREMENTS WITH EQUIPMENT MANUFACTURER.

PLUMBING EQUIPMENT SCHEDULE


E-1 EQUIPMENT PROVIDED BY OTHER, CONTRACTOR TO PROVIDE AND INSTALL ALL ACCESSORIES REQUIRED FOR A COMPLETE OPERATIONAL INSTALLATION (i.e. VALVES, REGULATORS, ETC.).

BUILDING GAS DEMAND

MARK	FIXTURE	CONN.	MBH EACH	QTY. EACH	MBH ALL
GFP-1	GAS FIRE PLACE	3/4"	55	1	55
TOTAL MBH					55
REQ'D. PIPE SIZE					1/2"
SYSTEM SIZED FOR 14" W.C. WITH 3" W.C. PRESSURE DROP (0.6 SPECIFIC GRAVITY) PER TABLES 402.4 OF THE 2020 FLORIDA FUEL GAS CODE.					
0.5 PSI GAS PIPE SIZED FOR A TOTAL DEVELOPED LENGTH (TDL) OF 50'.					
MBH RATING FOR EQUIPMENT IS DETERMINED BY THE MANUFACTURER.					

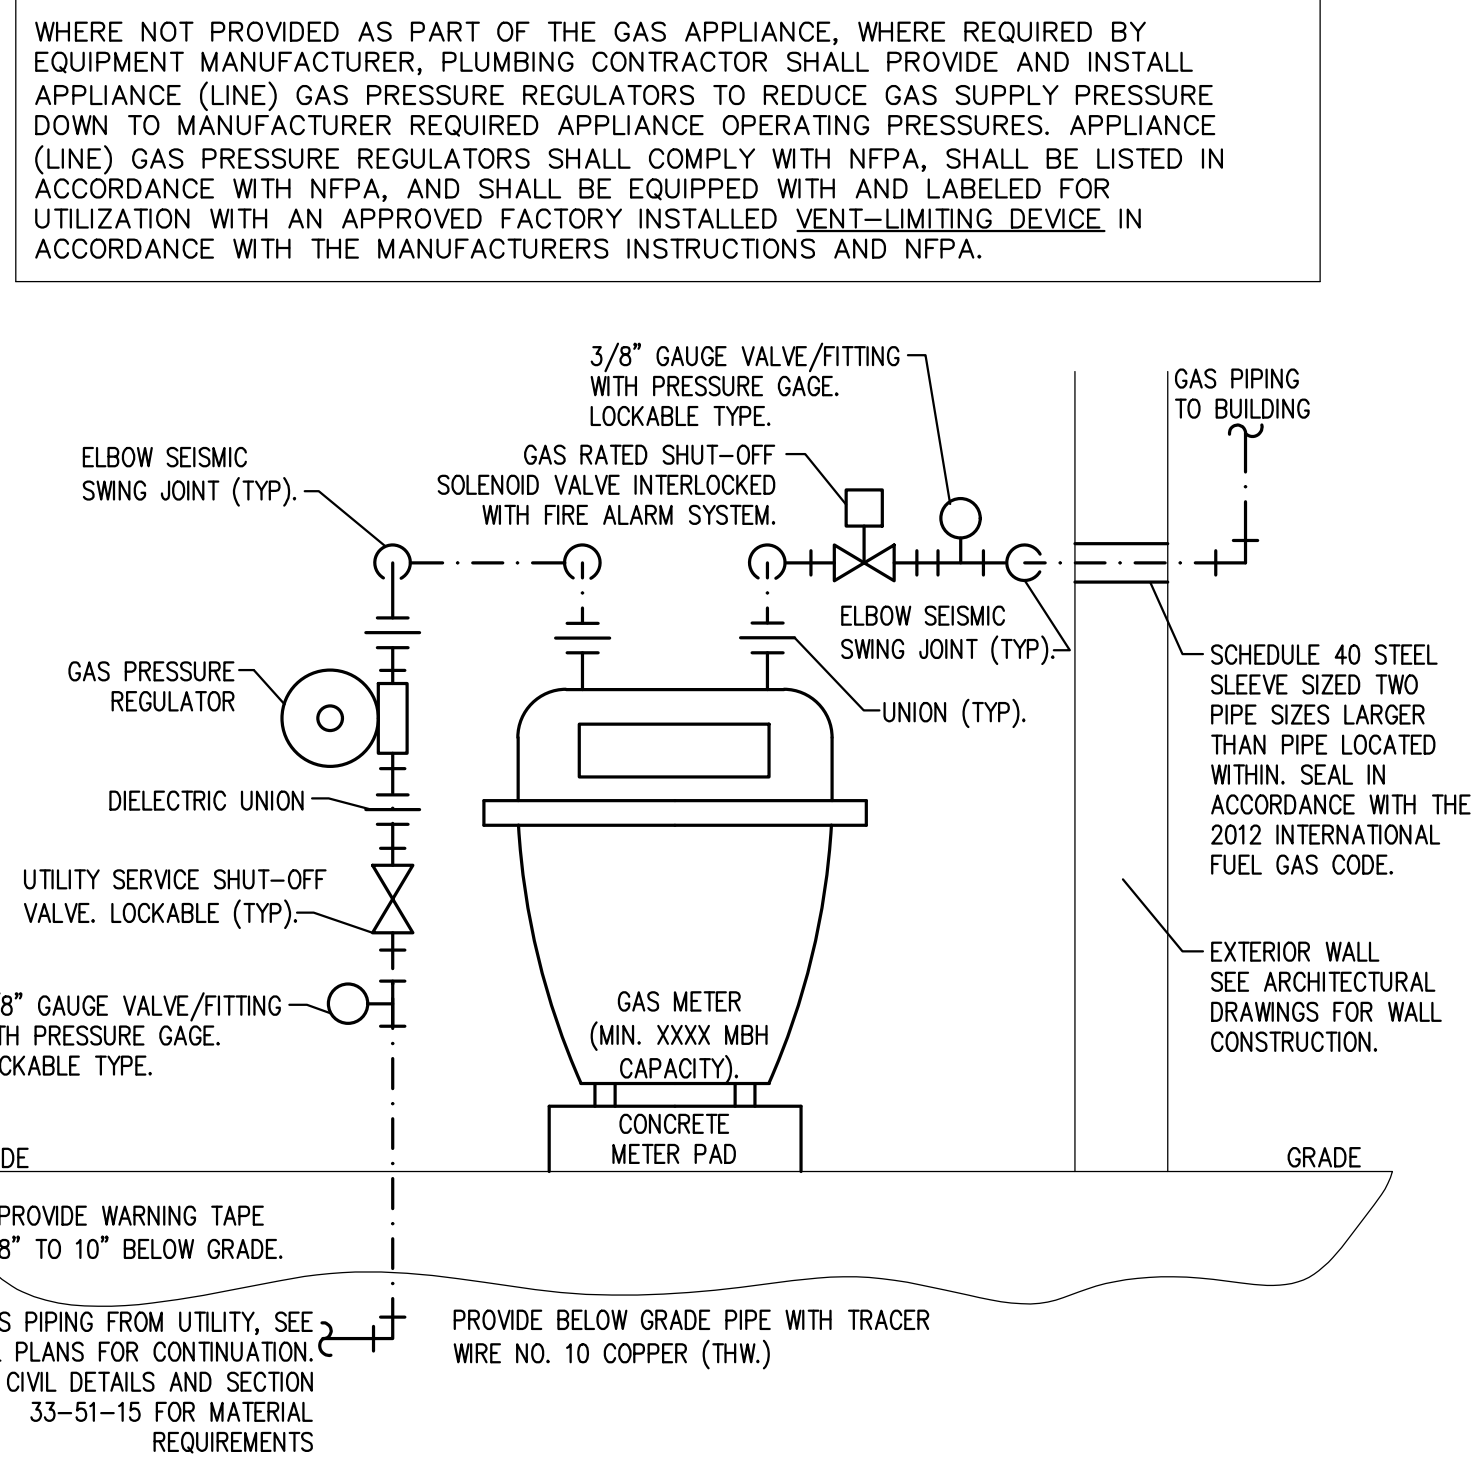

DETAIL - GAS SERVICE ENTRANCE
NOT TO SCALE

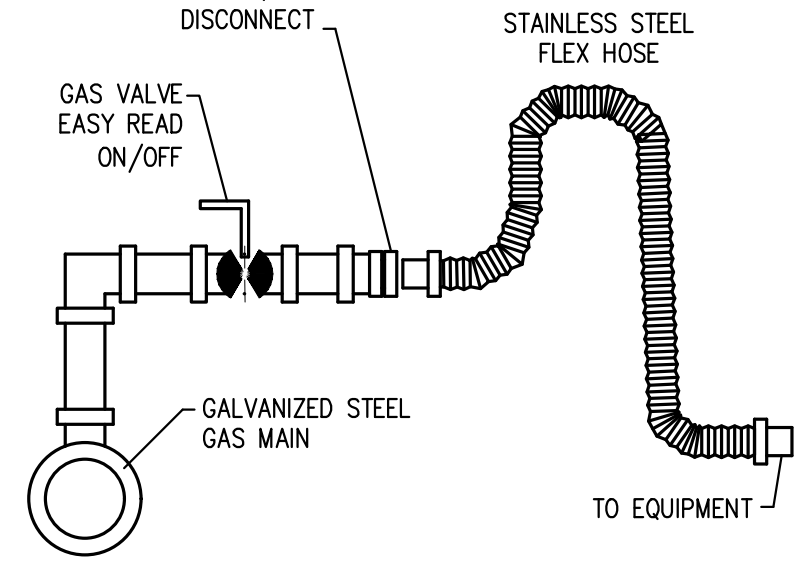

EQUIPMENT GAS CONNECTION
SCALE: NTS

- LEGEND**
- | | | | |
|-------|-------------------------------------|------|-------------------------|
| —○—□— | FLOOR DRAIN | ○—○ | PIPE RISERS (DROP) |
| —●— | FLOOR CLEANOUT | ○—○ | PIPE RISERS (UP) |
| —○— | WALL CLEANOUT | —○— | PIPE END (CAPPED) |
| —○— | TRAPPED DRAIN | —S— | SANITARY SEWER LINE |
| —T— | TRAP | —V— | VENT LINE |
| — | INV. EL. | —V— | VENT THRU ROOF |
| — | COLD WATER | —H— | WALL HYDRANT |
| —U— | UNION | S.A. | SHOCK ABSORBER |
| —B— | BALL VALVE (EXCEPT OTHERWISE NOTED) | A.P. | ACCESS PANEL |
| —V— | VALVE (NORMAL CLOSE) | — | EXISTING SANITARY SEWER |
| —P— | PRESSURE RELIEF VALVE | — | EXISTING VENT |
| — | EXISTING COLD WATER | — | DEMOLITION |
| — | EXISTING HOT WATER | — | CHECK VALVE |
| — | CONTROL VALVE/REGULATOR | — | GAS |
| — | STRAINER/FILTER | | |

PLUMBING GENERAL NOTES

- SEE SPECIFICATION FOR ADDITIONAL INFORMATION AND REQUIREMENTS.
- COORDINATE HVAC EQUIPMENT AND DUCT LOCATION WITH HVAC CONTRACTOR. SEE MECH DWGS. FOR ADDITIONAL INFORMATION.
- DO NOT INSTALL PIPING ABOVE ELECTRICAL PANELS OR EQUIPMENT. COORDINATE ELECTRICAL PANEL AND EQUIPMENT LOCATION WITH ELECTRICAL CONTRACTOR.
- RUN ALL HORIZONTAL COLD & HOT WATER PIPING ABOVE CEILING UNLESS OTHERWISE NOTED.
- EXTERIOR HOSE BIBS TO BE LOCATED 18" ABOVE GRADE UNLESS OTHERWISE NOTED.
- INSTALL ALL WORK IN A NEAT AND WORKMANLIKE MANNER, USING ONLY WORKMEN THOROUGHLY QUALIFIED IN THE TRADE OR DUTIES THEY ARE TO PERFORM. **ROUGH WORK WILL BE REJECTED.**
- MAINTAIN A MINIMUM 10' CLEARANCE BETWEEN HVAC EQUIPMENT FRESH AIR INTAKES AND SANITARY VENTS.
- FIELD VERIFY ALL EXISTING PIPING AND PIPING CONNECTION SIZES AND LOCATIONS. EXCEPT OTHERWISE NOTED ON THE DRAWING, EXISTING CONCEALED PIPING NOT CONNECTED TO NEW PLUMBING SYSTEM OR FIXTURES SHALL BE CAPPED BEHIND FINISHED WALL OR BELOW FLOOR AND ABANDONED IN PLACE.
- PROPERLY CONNECT NEW PLUMBING SYSTEM AND FIXTURES TO EXISTING SYSTEM. PROVIDE NEW FITTINGS AS REQUIRED FOR PROPER CONNECTION.
- FIELD VERIFY EXISTING BUILDING STRUCTURAL. NOTIFY GENERAL CONTRACTOR FOR RESOLUTION IF EXISTING BUILDING STRUCTURE IMPEDES PLUMBING INSTALLATION. SEE STRUCTURAL DRAWINGS FOR ADDITIONAL INFORMATION AND INSTRUCTION.
- DOMESTIC WATER SHUT-OFF VALVES LOCATED ABOVE DRYWALL CEILING SHALL BE GROUPED TOGETHER TO PROVIDE ACCESS FROM SINGLE ACCESS PANELS IF POSSIBLE. PROVIDE WITH IDENTIFICATION TAG INDICATING AREAS THE VALVE CONTROLS.
- COORDINATE ALL LATERAL CONNECTIONS WITH CIVIL ENGINEERING DRAWINGS. ANY CONFLICTS TO BE RESOLVED PRIOR TO START OF CONSTRUCTION.
- CLEANOUTS ON 6" AND SMALLER PIPING SHALL BE PROVIDED WITH A CLEARANCE OF NOT LESS THAN 18" FOR RODDING. CLEANOUTS ON 8" AND LARGER PIPING SHALL BE PROVIDED WITH A CLEARANCE OF NOT LESS THAN 36" FOR RODDING.

PLUMBING DEMOLITION GENERAL NOTES

- CONTRACTOR SHALL VERIFY ALL EXISTING CONDITIONS AND DIMENSIONS IN THE FIELD PRIOR TO COMMENCING ANY WORK. ANY DISCREPANCIES BETWEEN DRAWINGS AND EXISTING CONDITIONS ARE TO BE REPORTED TO THE ARCHITECT/ENGINEER IN WRITING PRIOR TO STARTING WORK ON A GIVEN ITEM AND BEFORE INCURRED ANY ADDITIONAL COSTS.
- SPECIFIED DEMOLITION NOTES ARE NOT TO BE CONSIDERED ALL INCLUSIVE OR COMPLETE IN THEMSELVES. THE CONTRACTOR SHALL PROVIDE ALL DEMOLITION INCIDENTAL TO AND/OR REQUIRED BY NEW AND RENOVATED CONSTRUCTION WHETHER OR NOT SPECIFICALLY NOTED ON THE DRAWINGS AND INCLUDING, BUT NOT LIMITED TO, THE FOLLOWING: REMOVAL OF PLUMBING FIXTURES, TRIM, SUPPLIES, TRAPS, VALVES, CLEANOUTS, DRAINS, WATER HEATERS, RELATED PIPING AND ACCESSORIES THAT MIGHT REASONABLY BE REQUIRED TO BE REMOVED IN PREPARATION FOR THE INSTALLATION OF NEW CONSTRUCTION, SPECIFIED FIXTURES OR EQUIPMENT FURNISHED BY OTHERS REQUIRING PLUMBING SERVICES.
- PRIOR TO COMMENCEMENT OF WORK, THE CONTRACTOR SHALL FIELD VERIFY LOCATIONS, SIZES AND INVERT ELEVATIONS OF ALL EXISTING PLUMBING UTILITIES PERTINENT TO THE SCOPE OF WORK.
- DEMOLITION SHALL BE PERFORMED IN SUCH A MANNER THAT WILL NOT DAMAGE ADJOINING SURFACES OR EQUIPMENT INDICATED TO REMAIN.
- WHERE DEMOLITION WOULD AFFECT THE STRUCTURAL INTEGRITY OF THE BUILDING, THE CONTRACTOR SHALL NOTIFY THE ARCHITECT/ENGINEER PRIOR TO PROCEEDING WITH DEMOLITION.
- THE PLUMBING CONTRACTOR SHALL REMOVE THE EXISTING FIXTURES, RELATED PIPING AND ACCESSORIES AS NOTED. CAP AND CONCEAL ALL SANITARY VENT AND WATER PIPING BELOW FLOOR, ABOVE CEILING AND/OR IN WALLS AS REQUIRED AND NOTED. REMOVE ALL PIPING NOT REQUIRED FOR RENOVATION AND CAP AT NEAREST ACTIVE MAIN LINE. NO PIPING SHALL BE LEFT ABANDONED. REMOVED FIXTURES AND TRIM SHALL REMAIN THE PROPERTY OF THE OWNER. VERIFY WITH THE OWNER IF REMOVED FIXTURES AND TRIM ARE TO BE REMOVED FROM THE SITE OR RETURNED TO THE BUILDING STOCK.
- THE EXISTING SYSTEMS OPERATION SHALL BE MAINTAINED IN RENOVATED AND ADJACENT AREAS UNTIL THE NEW SYSTEMS ARE OPERATIONAL. CONTRACTOR SHALL INCLUDE IN HIS BID ALL COSTS ASSOCIATED WITH KEEPING THE EXISTING SYSTEMS ON LINE.



planning
architecture
landscape architecture
urban design
visual communication

Jacksonville
ELM Studio
1301 Riverplace Boulevard
Suite 1818
Jacksonville, FL 32207
t 904 296 8066
elmplan.com

PONTE VEDRA INN & CLUB
GOLF CLUB PATIO RENOVATION
PONTE VEDRA BEACH, FL

ISSUE DATES

NO.	DESCRIPTION	DATE

THIS DRAWING IS AN INSTRUMENT OF SERVICE AND THE PROPERTY OF ELM, INC. AND SHALL REMAIN THEIR PROPERTY. THE USE OF THIS DRAWING SHALL BE RESTRICTED TO THE ORIGINAL SITE FOR WHICH IT IS PREPARED, AND PUBLICATION THEREOF IS EXPRESSLY LIMITED TO SUCH USE.

PROJ. #: 12-44
DATE: 12.22.2023
DRAWN BY: CJF
CHECKED BY: LRH
SCALE: AS NOTED

LEGEND,
SCHEDULE &
MISC.
DETAILS

SHEET NUMBER
P201



planning
architecture
landscape architecture
urban design
visual communication

Jacksonville
ELM Studio
1301 Riverplace Boulevard
Suite 1818
Jacksonville, FL 32207
t 904 296 8066
elmpln.com

PONTE VEDRA INN & CLUB
GOLF CLUB PATIO RENOVATION
PONTE VEDRA BEACH, FL

ISSUE DATES		
NO.	DESCRIPTION	DATE

THIS DRAWING IS AN INSTRUMENT OF SERVICE AND THE PROPERTY OF ELM, INC. AND SHALL REMAIN THEIR PROPERTY. THE USE OF THIS DRAWING SHALL BE RESTRICTED TO THE ORIGINAL SITE FOR WHICH IT IS PREPARED, AND PUBLICATION THEREOF IS EXPRESSLY LIMITED TO SUCH USE.

PROJ. #: 12-44
DATE: 12.22.2023
DRAWN BY: MH
CHECKED BY: TME
SCALE: AS NOTED

PART SITE
PLAN-ELECTRICAL
LEGEND &
NOTES


SHEET NUMBER
E101

MARK	DESCRIPTION	MANUFACTURER	VOLT	LED SOURCE		INPUT WATTS	MTG./INSTALLATION (UNLESS INDICATED OTHERWISE)	NOTES
				LUMENS	TEMP. (°C)			
L1	LED DECORATIVE STRING FIXTURES	TOKISTAR LIGHTING# EXBK-18-VIIV-S14-F	120	-	3K	1.8	POLE	②③

- NOTES:
- THE FIXTURE CATALOG NUMBERS GIVEN MAY NOT CONTAIN ALL PARTS & PIECES REQUIRED, CONTRACTOR TO INCLUDE ALL PARTS REQUIRED FOR A FULLY FUNCTIONING FIXTURE INCLUDING (BUT NOT LIMITED TO) HOUSINGS, TRIMS, REFLECTORS, BALLAST, TRANSFORMER(S), DRIVERS, LAMPS etc... IN-ADDITION DIMMER SWITCHES SHALL BE COMPATIBLE WITH FIXTURE PROVIDED.
 - SEE MOUNTING DETAIL FOR ADDITIONAL REQUIREMENTS.
 - PROVIDE A SEPARATE PRICE FOR PROVIDING AND INSTALLING FESTOON LIGHTING AS DESCRIBED. TITLE 'FESTOON LIGHTING', BRANCH CIRCUIT/FLUSH BOXES/CONTROL SHOULD BE INCLUDED IN BASE BID.

SHEET NO.	SHEET TITLE
E1.01	PARTIAL SITE PLAN- ELECTRICAL, NOTES & LEGEND
E1.02	POWER RISER, PNL SCH. SPEC AND DETAILS

- ELECTRICAL LEGEND
- FESTOON LIGHTS (BID ALTERNATE)
 - CIRCUIT/CONDUIT UNDERFLOOR/GRADE W/GROUND
 - CIRCUIT/ CONDUIT W/GROUND
 - BRANCH CIRCUIT HOMERUN W/GROUND
 - SWITCH SINGLE POLE
 - DUPLEX RECEPTACLE GF/ WP IN-USE ENCLOSURE
 - PANELBOARD (PNL)
 - JUNCTION BOX
 - COMM OUTLET
 - TV OUTLET
- ABBREVIATIONS
- AFF ABOVE FINISHED FLOOR/GRADE
 - GF1 GROUND FAULT INTERRUPT
 - GND GROUND
 - TBB TELEPHONE BACKBOARD
 - WP WEATHERPROOF
 - XFMR TRANSFORMER

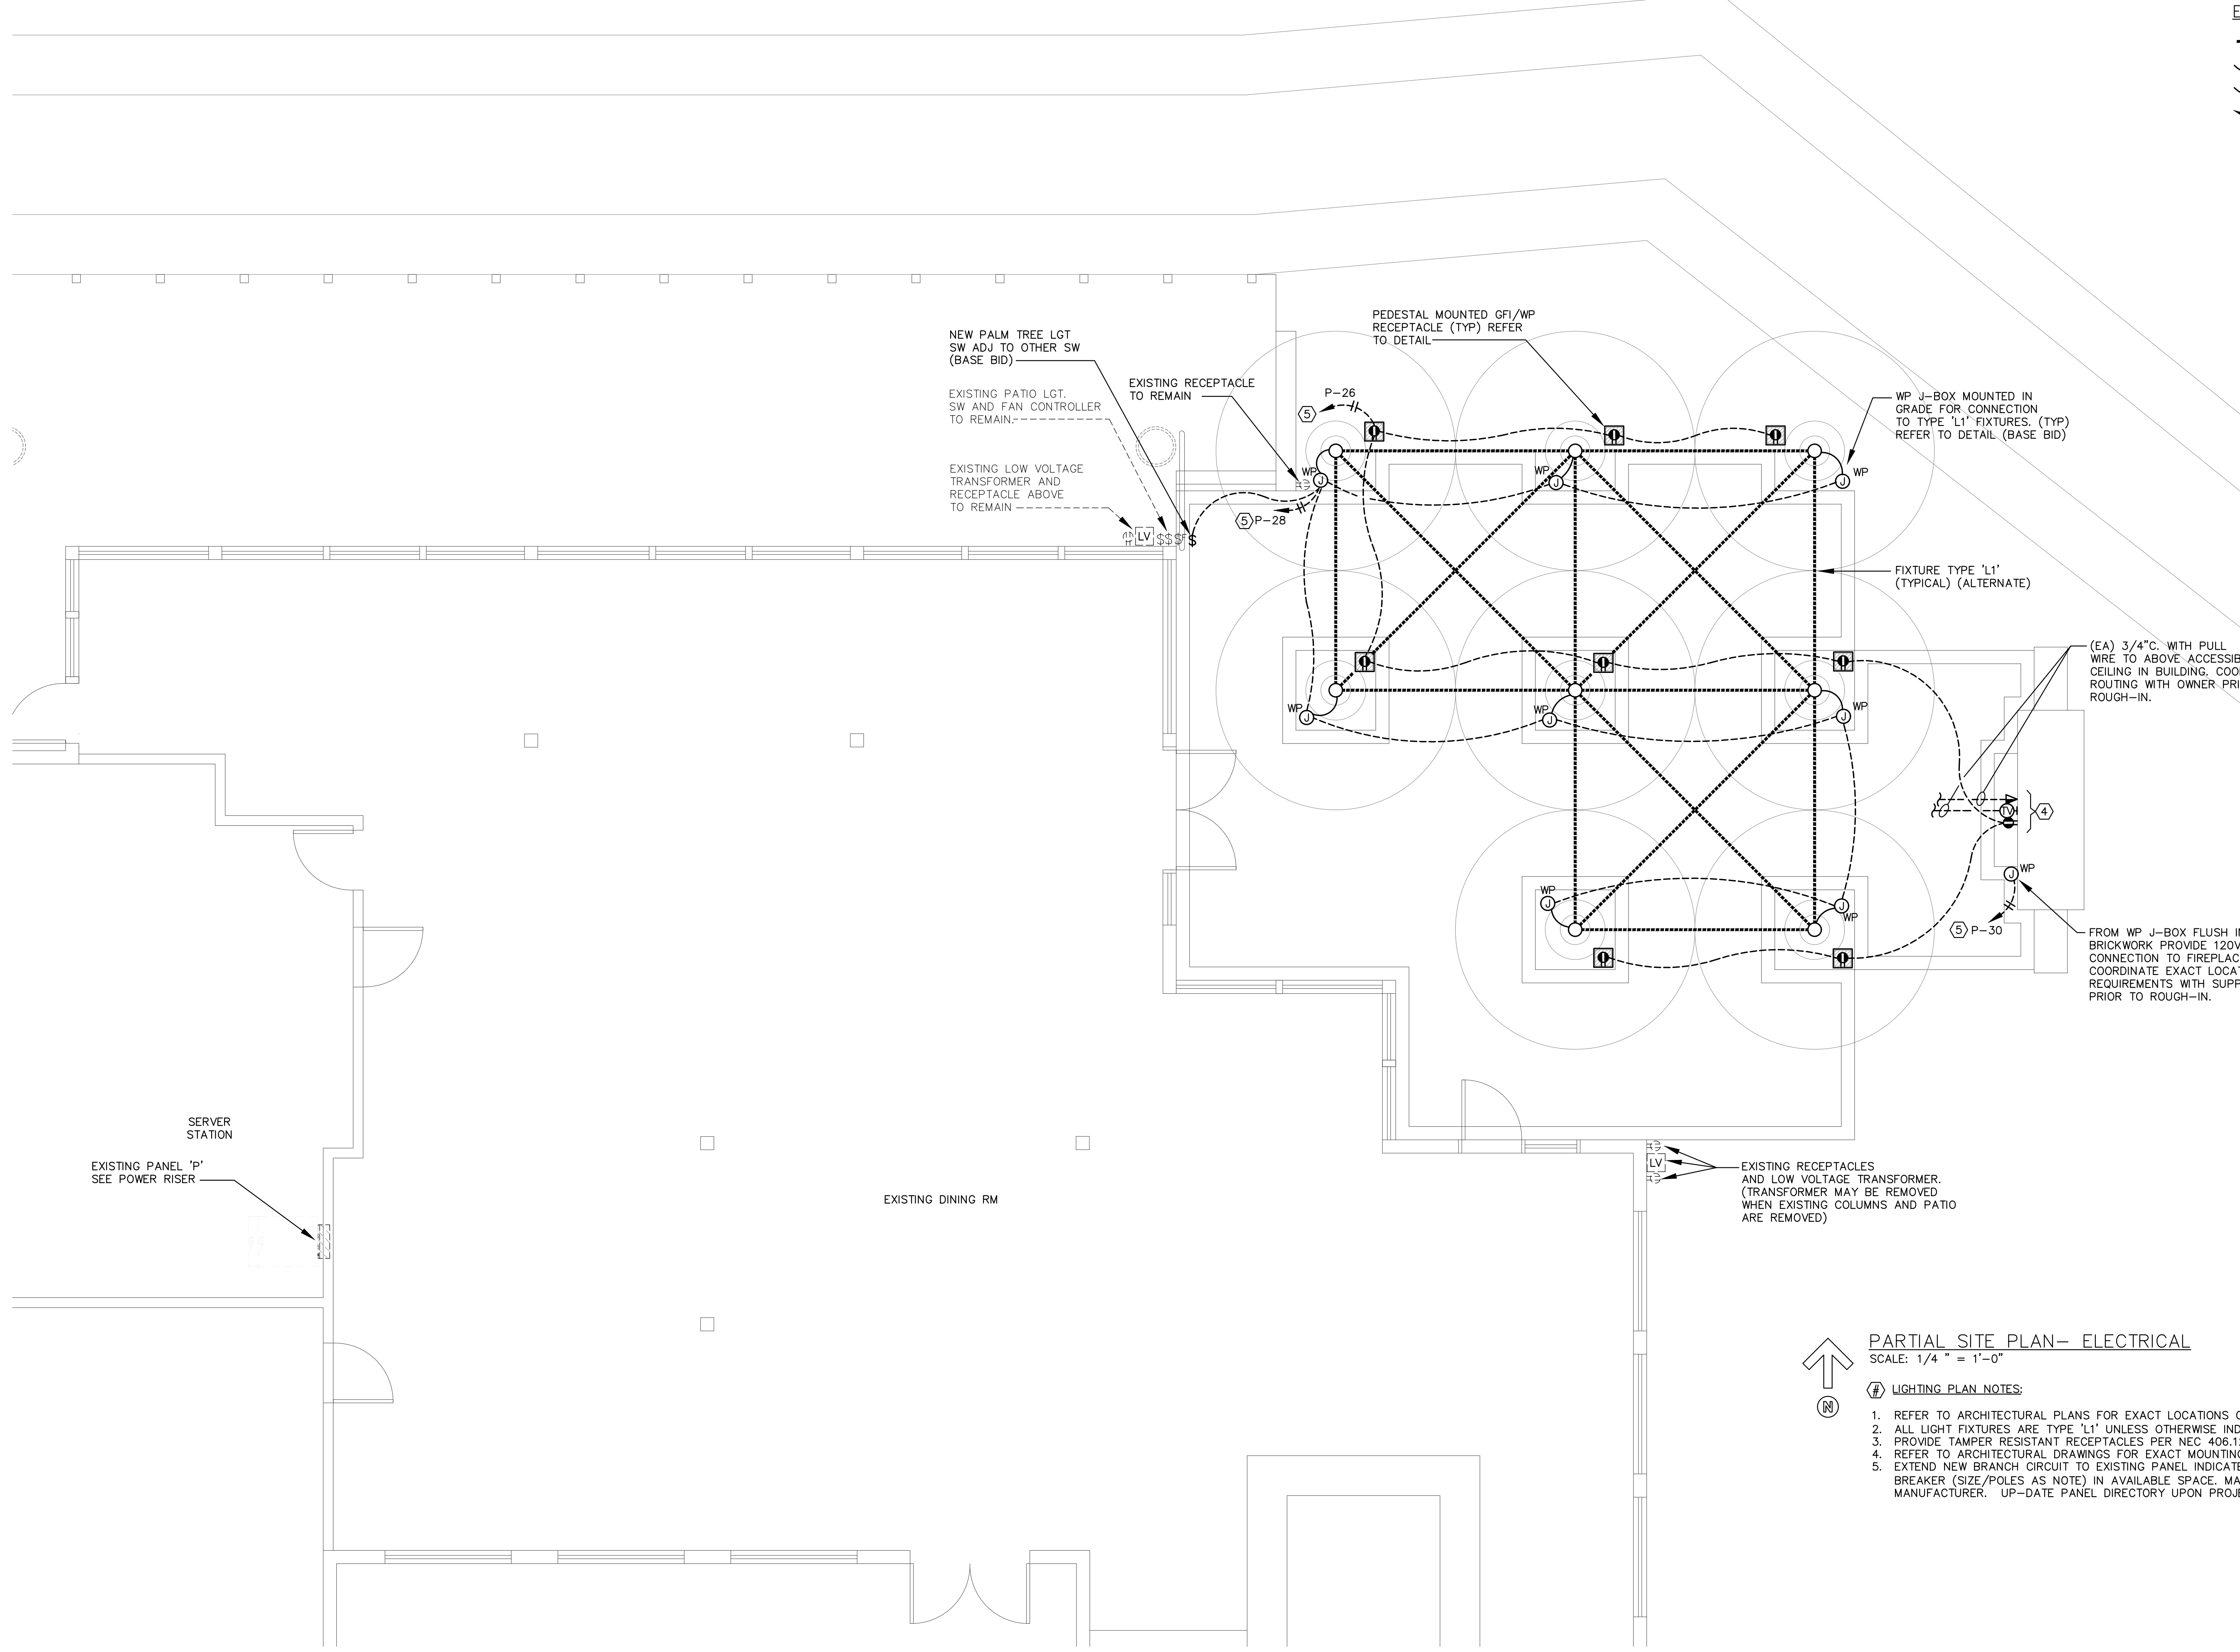

PARTIAL SITE PLAN- ELECTRICAL
SCALE: 1/4" = 1'-0"

LIGHTING PLAN NOTES:


- REFER TO ARCHITECTURAL PLANS FOR EXACT LOCATIONS OF ALL LIGHT FIXTURES/POLE.
- ALL LIGHT FIXTURES ARE TYPE 'L1' UNLESS OTHERWISE INDICATED.
- PROVIDE TAMPER RESISTANT RECEPTACLES PER NEC 408.12.
- REFER TO ARCHITECTURAL DRAWINGS FOR EXACT MOUNTING LOCATION PRIOR TO ROUGH.
- EXTEND NEW BRANCH CIRCUIT TO EXISTING PANEL INDICATED AND PROVIDE NEW CIRCUIT BREAKER (SIZE/POLES AS NOTE) IN AVAILABLE SPACE. MATCH EXISTING BREAKER MANUFACTURER. UP-DATE PANEL DIRECTORY UPON PROJECT COMPLETION.

12/18/23
3813E101

POWELL & HINKLE ENGINEERING, P.A. 1409 KINGSLEY AVENUE, BLDG 12A ORANGE PARK, FLORIDA 32073 (904) 264-5570 FAX:(904) 278-2646	ROBERT L. HINKLE PE 29302 GALTON C. MOK PE 33192 LANE R. HINKLE PE 48076 THOMAS M. ELDER PE 56121 RICHARD A. MATTHEWS PE 59418 DAVID R. SPELL JR. PE 04729 JAMES L. HENNESSEY PE 83241
--	--

ELECTRICAL SPECIFICATION

- SCOPE: PROVIDE A COMPLETE ELECTRICAL SYSTEM AS SHOWN AND MEET THE REQUIREMENTS OF APPLICABLE STATE AND LOCAL CODES INCLUDING BUT NOT LIMITED TO CURRENT VERSIONS OF THE FLORIDA BUILDING CODE, AND THE NATIONAL ELECTRICAL CODE (NEC). OBTAIN AND PAY FOR ALL PERMITS, INSPECTIONS AND CONNECTIONS NECESSARY FOR THIS WORK.
- SITE INSPECTION: VISIT AND THOROUGHLY INSPECT SITE BEFORE SUBMITTING BID. ASSUME RESPONSIBILITY FOR MEETING ALL EXISTING SITE CONDITIONS AFFECTING THE WORK.
- GUARANTEE: PROVIDE ALL NEW MATERIALS AND EQUIPMENT, AND GUARANTEE SAME FOR ONE YEAR FROM DATE OF ACCEPTANCE.
- SUBMITTALS: SUBMIT SHOP DRAWINGS, CATALOG SHEETS, OR OTHER DESCRIPTIVE DATA WITH SUFFICIENT INFORMATION TO ESTABLISH DESIGN, QUALITY AND PERFORMANCE. MANUFACTURER CATALOG SHEETS SUBMITTED WITHOUT SPECIFIC MODEL NUMBERS INDICATED WILL BE REJECTED. DATA SHALL DESCRIBE APPARATUS, EQUIPMENT, PANELS, FIXTURES, AND OTHER ITEMS REQUIRING DESCRIPTIVE LITERATURE. SUBMITTALS SHALL INCLUDE THE FOLLOWING:
 - LIGHT FIXTURES
 - PANELBOARDS
 - SAFETY SWITCHES
 - TRANSFORMERS
 - MOTOR STARTERS
 - WIRING DEVICES
- INSTANTANEOUS TRIP SETTING SHALL BE NOT GREATER THAN 25MS. CIRCUIT BREAKERS SHALL BE MOLDED CASE, WITH QUICK-MAKE AND QUICK-BREAK ACTION FOR BOTH MANUAL AND AUTOMATIC OPERATION, WITH THERMAL MAGNETIC TRIP ELEMENTS. SAFETY SWITCHES SHALL BE QUICK-MAKE, QUICK-BREAK TYPE, IN GENERAL PURPOSE OR WEATHER PROOF ENCLOSURE. PROVIDE PROPERLY SIZED FUSES WHERE INDICATED ON THE DRAWINGS. (MATCH EXISTING)
- WIRING DEVICES: WALL SWITCHES SHALL BE QUIET AC TYPE, 120/277V, 20A, COLOR AS DIRECTED BY ARCHITECT. RECEPTACLES SHALL BE DUPLEX, 120V, 20A, 3 WIRE GROUNDING TYPE, COLOR AS DIRECTED BY ARCHITECT. WALL PLATES FOR SWITCHES, RECEPTACLES, AND TELEPHONE/DATA OUTLETS SHALL BE PLASTIC, COLOR AS DIRECTED BY ARCHITECT. DUPLEX RECEPTACLE TO BE INSTALL WITH THE GROUND ON BOTTOM.
- LIGHTING FIXTURES: LIGHTING FIXTURES SHALL BE FURNISHED AS SCHEDULED AND SHALL BE FACTORY WIRED, ASSEMBLED WITH FACTORY INSTALLED OPTIONS AS SPECIFIED. LOW VOLTAGE (24V) FIXTURES SHALL BE PROVIDED WITH MANUFACTURER RECOMMENDED LINE-VOLTAGE DRIVER(S) AS REQUIRED TO MINIMIZE DRIVER QUANTITIES AND MAXIMUM FIXTURE (RUN) LENGTH(S). DRIVERS SHALL BE MATCHED WITH CONTROL METHOD SHOWN. WHERE EMERGENCY LIGHT FIXTURES ARE INDICATED, FIXTURES SHALL BE PROVIDED WITH A UL LISTED, FACTORY INSTALLED BATTERY/INVERTER AS REQUIRED TO FUNCTION AS AN EMERGENCY LIGHTING SOURCE (UNIT EQUIPMENT) AS REQUIRED BY CODE.
- ELECTRICAL CONDUIT: INSTALL ALL WIRING IN MINIMUM SIZE 1/2" CONDUIT. EMT SHALL BE USED GENERALLY FOR INTERIOR WIRING, M/C CABLE MAY BE USED AS PERMITTED BY CODE, HOWEVER IN ALL CASES WHERE M/C IS USED IT SHALL BE PROVIDED WITH ONE (1) ADDITIONAL CONDUCTOR (CAPPED AT BOTH ENDS) FOR USE AS A SPARE. FLEXIBLE STEEL CONDUIT SHALL BE USED FOR FINAL CONNECTION TO ALL MOTORIZED EQUIPMENT. UNDERGROUND CONDUIT SHALL BE PVC.
- OUTLET BOXES: OUTLET BOXES FOR SWITCHES, RECEPTACLES AND TELEPHONE/DATA OUTLETS IN FINISHED WALLS SHALL BE STANDARD GANG TYPE (1-1/2" DEEP) WITH COVERS SIZED FOR BOX. WALL SWITCH OUTLETS SHALL BE FLUSH MOUNTED 48 INCHES ABOVE FLOOR TO TOP. RECEPTACLE AND TELEPHONE/DATA OUTLET BOXES SHALL BE FLUSH MOUNTED 15 INCHES ABOVE FLOOR TO BOTTOM, UNLESS OTHERWISE NOTED.
- WIRE AND CABLE: ALL WIRING SHALL BE COPPER WITH THHN OR XHHW INSULATION. WIRING SUBJECTED TO ELEVATED TEMPERATURES SHALL BE DERATED AS REQUIRED BY THE NEC. WIRE SIZES NO. 6 AND LARGER SHALL BE STRANDED.
- BRANCH CIRCUITS: INSTALL ALL WIRING IN CONDUIT AS SHOWN. NO SMALLER THAN NO. 12 SHALL BE USED FOR ANY BRANCH CIRCUIT. WIRING FOR MOTORS, HEATING AND OTHER MISCELLANEOUS EQUIPMENT SHALL BE INSTALLED IN ACCORDANCE WITH THE DRAWINGS, ALTHOUGH NOT SHOWN AND NOT REQUIRED BY CODE. ALL BRANCH CIRCUITS SHALL BE PROVIDED WITH A PROPERLY SIZED EQUIPMENT GROUNDING CONDUCTOR.
- TELEPHONE/DATA CONDUIT SYSTEM: PROVIDE EMPTY CONDUITS, OUTLETS AND BACKBOARDS AS SHOWN. INSTALL PULL WIRE IN EACH CONDUIT. PROVIDE EACH OUTLET WITH BLANK COVER PLATE.
- TESTING AND MARKING: COMPLETELY TEST AND MARK ALL WIRING AND EQUIPMENT INSTALLED AND LEAVE THE INSTALLATION IN PERFECT WORKING ORDER.

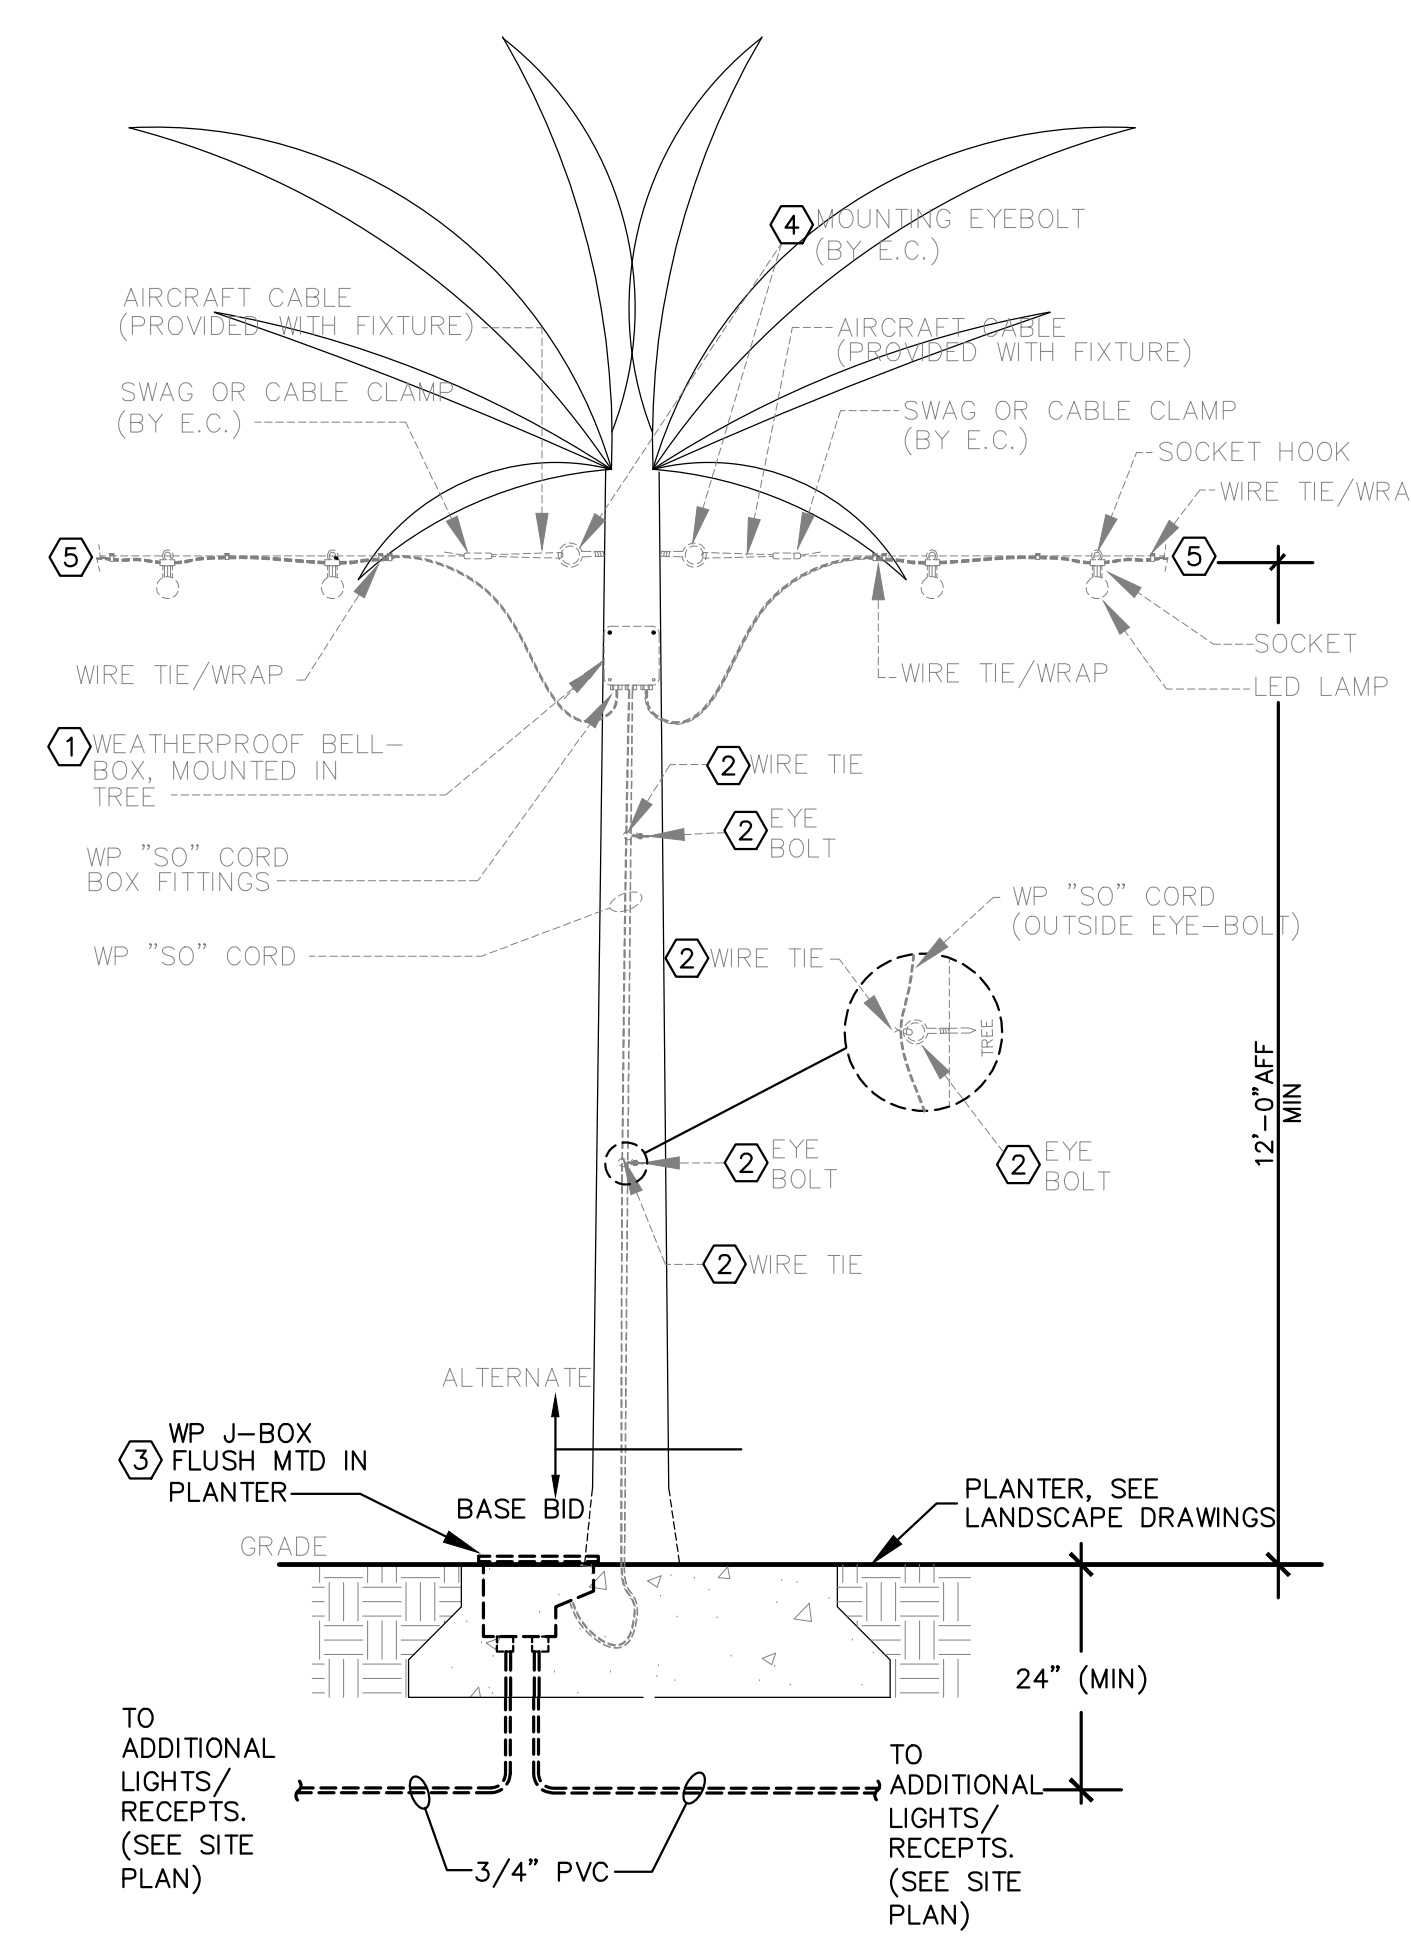

FESTOON/STRING LIGHT MOUNTING DETAIL
NO SCALE

DETAIL NOTES:


- PROVIDE STAINLESS STEEL STAND OFF TYPE, HANGER BOLTS TO ATTACH J-BOX TO TREE. CAST LIGHTING CATALOG #CTREEH1 OR APPROVED EQUAL. NO OTHER SCREW FINISHES OR MATERIALS IN CONTACT WITH THE TREE WILL BE ALLOWED. MOUNTING J-BOX DIRECTLY TO THE TREE USING TIE STRAPS AROUND THE TREE SHALL NOT BE ALLOWED. (ALTERNATE)
- CORD SHALL BE SECURED TO TREE USING STAINLESS STEEL EYE BOLTS SCREWED DIRECTLY INTO TREE. SECURE CORD TO OUTSIDE OF EYE BOLTS USING BLACK, UV STABILIZED, TIE STRAPS. DO NOT RUN CORD THROUGH EYE BOLTS AS FUTURE TREE GROWTH WILL DAMAGE CORDS. WHERE POSSIBLE, ROUTE ALL CONDUITS WHERE IT IS LEAST VIEWABLE FROM PUBLIC (ALTERNATE)
- (BASE BID) WP J-BOX FLUSH MOUNTED IN PLANTER. CONTRACTOR SHALL HAND DIG AND STAY CLEAR OF EXISTING TREE ROOTS. DO NOT CUT ROOTS. COORDINATE WITH TREE SUPPLIER AND LANDSCAPE ARCHITECT PRIOR TO ROUGH-IN.
- STAINLESS STEEL EYEBOLT SCREWED DIRECTLY INTO TREE. ALL HOLES ARE TO BE PRE-DRILLED. COORDINATE ENTIRE INSTALLATION WITH LANDSCAPE ARCHITECT AND TREE SUPPLIER PRIOR TO ANY WORK. FIXTURE (CONDUCTORS) CAN NOT BE SUPPORTED BY TREE PER NEC 225.26. (ALTERNATE)
- REFER TO SITE PLAN FOR STRING LIGHT LENGTHS AND SPECIFICATIONS.

PRIOR TO ANY WORK, SUBMIT ALL MOUNTING HARDWARE TO TREE SUPPLIER / ARBORIST FOR APPROVAL TO INSURE HARDWARE IS COMPATIBLE WITH TREES AND WILL NOT HARM THE TREES IN ANYWAY. SUPPLIER/ARBORIST TO APPROVE ALL HARDWARE IN WRITING PRIOR TO ANY WORK. (ALTERNATE)


SERVING	FLUSH MOUNTED 208Y/120 V, 3 PH, 4 W, 125 AMP, MAIN LUGS			EXISTING PANEL TO REMAIN		
	AMG KVA	AMP	CKT	PHASE	CKT AMP	KVA
EXISTING LOAD	EX 0.5	20	1	A B C	2	20
↓	↓	↓	↓	↓	4	20
↓	↓	↓	↓	↓	6	20
↓	↓	↓	↓	↓	8	20
↓	↓	↓	↓	↓	10	20
↓	↓	↓	↓	↓	12	20
↓	↓	↓	↓	↓	14	20
↓	↓	↓	↓	↓	16	20
↓	↓	↓	↓	↓	18	20
↓	↓	↓	↓	↓	20	20
↓	↓	↓	↓	↓	22	20
↓	↓	↓	↓	↓	24	20
EXISTING LOAD	EX 0.5	20	23			
↓	↓	↓	↓	↓	25	26
↓	↓	↓	↓	↓	26	20
SPACE ONLY	-	-	-	↓	27	28
SPACE ONLY	-	-	-	↓	29	30
KVA LOAD-13.8 (EST)						

⑦ PANEL SCHEDULE(S) NOTES:

- EXISTING GE PANEL TO REMAIN.
- PROVIDE (GF1) TYPE BREAKER.

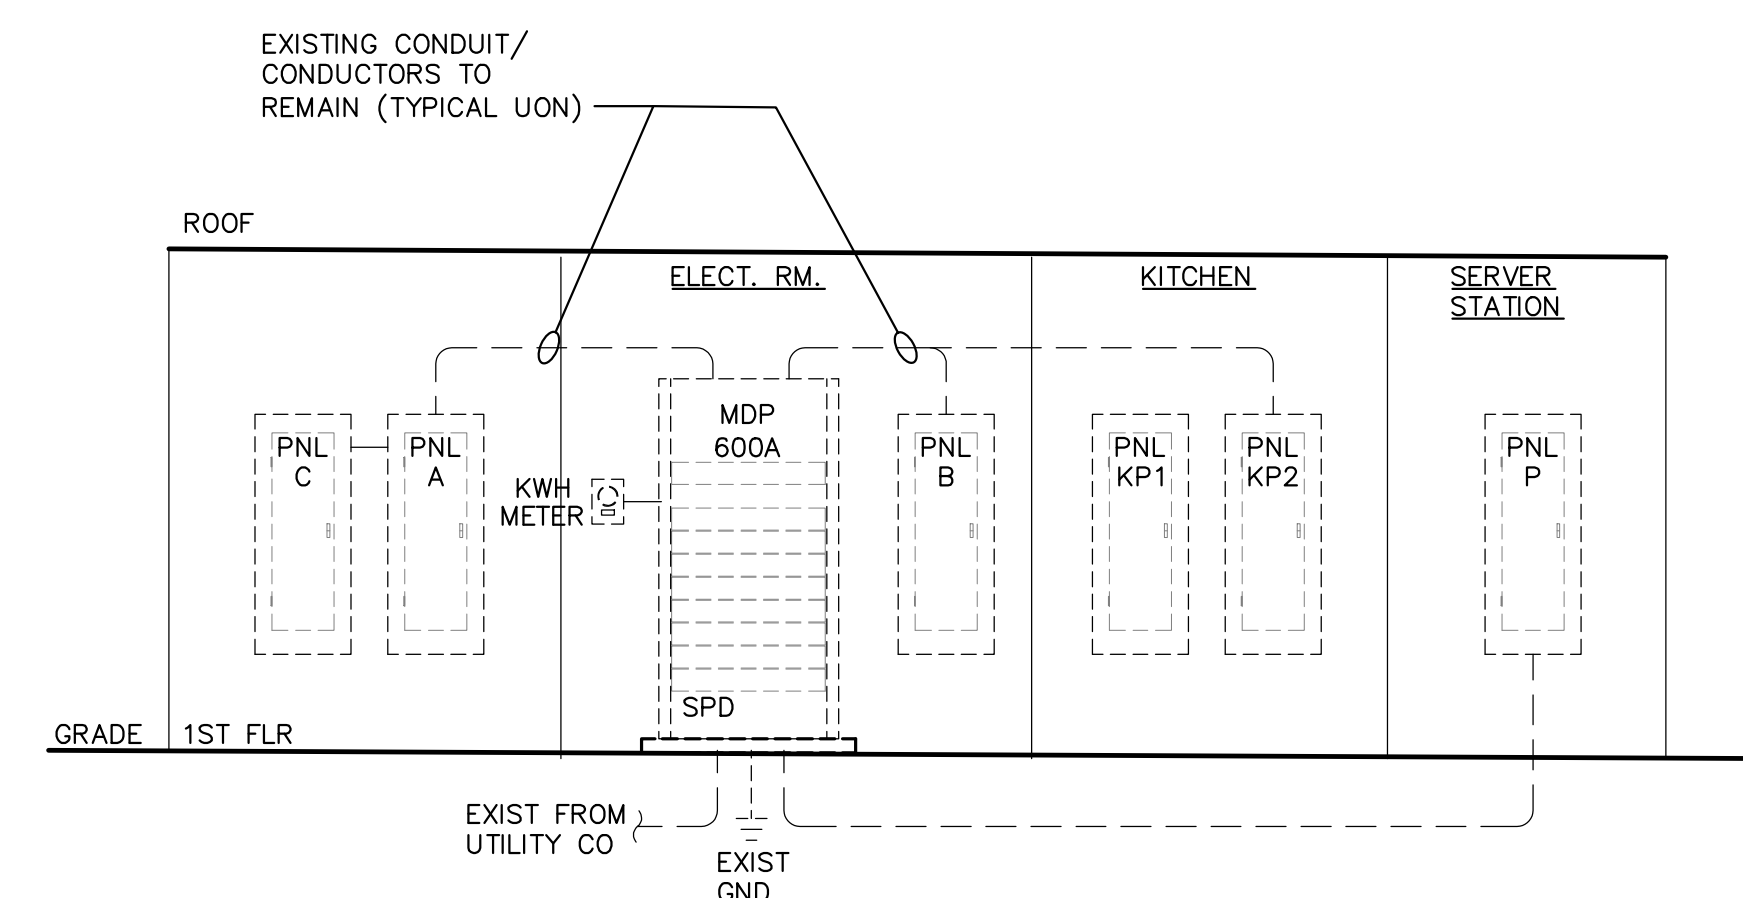

EXISTING POWER RISER
NO SCALE

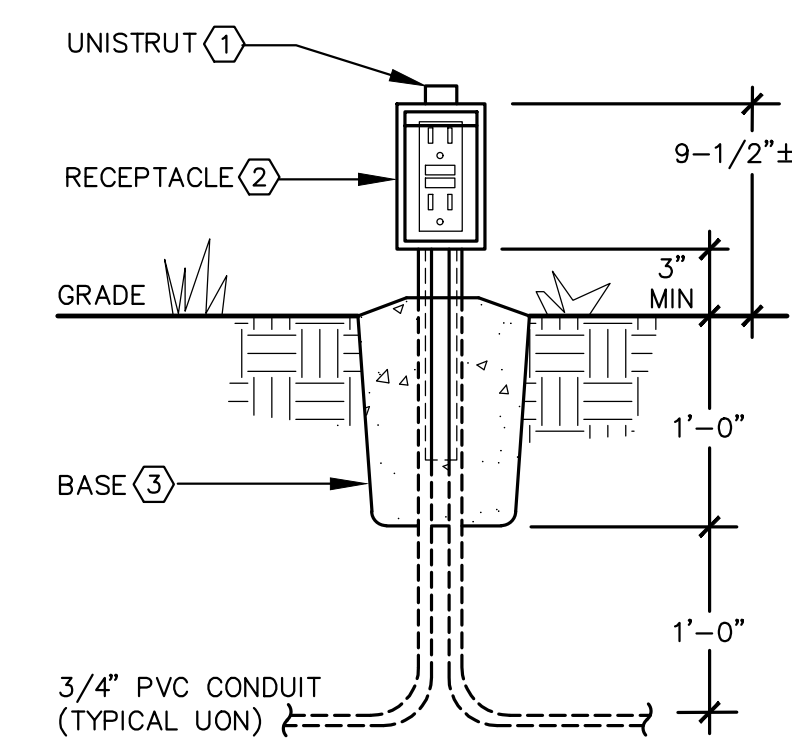

⑧ GROUND MOUNTED IN-USE RECEPTACLE DETAIL
NO SCALE

⑨ POWER POST DETAIL NOTES:

- PROVIDE GALVANIZED UNISTRUT DIRECTLY MOUNTED IN CONCRETE BASE FOR RECEPTACLE. SEE SITE PLAN FOR EXACT MOUNTING LOCATION.
- PROVIDE MARINE GRADE, SINGLE-GANG JBOX MOUNTED TO UNISTRUT WITH DUPLEX GF1 RECEPTACLE (NO DAISY CHAIN) AND WEATHER PROTECTED COVER (HUBBELL CATALOG #RW51040 OR APPROVED EQUAL).
- PROVIDE SLOPED 3000psi CONCRETE BASE TO DRAIN WATER AWAY FROM POST. MIX CONCRETE WITH COLOR PIGMENT TO MATCH LANDSCAPE.
- LOCATE PER SITE PLANS, SEE E101



planning
architecture
landscape architecture
urban design
visual communication

Jacksonville
ELM Studio
1301 Riverplace Boulevard
Suite 1818
Jacksonville, FL 32207
t 904 296 8066
elmpplan.com

PONTE VEDRA INN & CLUB
GOLF CLUB PATIO RENOVATION
PONTE VEDRA BEACH, FL

NO.	DESCRIPTION	DATE

PROJ. #: 12-44
DATE: 12.22.2023
DRAWN BY: MH
CHECKED BY: TME
SCALE: AS NOTED

POWER RISER
PANEL SCH.
SPECIFICATIONS
AND DETAILS

SHEET NUMBER
E102

	POWELL & HINKLE ENGINEERING, P.A.	ROBERT L. HINKLE	PE 29302
	1409 KINGSLEY AVENUE, BLDG 12A	GALTON C. MOK	PE 33192
	ORANGE PARK, FLORIDA 32073	LANE R. HINKLE	PE 48076
	(904) 264-5570 FAX:(904) 278-2646	THOMAS M. ELDER	PE 56121
		RICHARD A. MATTHEWS	PE 59418
		DAVID R. SPELL JR.	PE 04720
		JAMES L. HENNESSEY	PE 83241

12/18/23
3813E101



Map created with St. Johns County's iMap

DISCLAIMER:
 This map is for reference use only. Data provided are derived from multiple sources with varying levels of accuracy. The St. Johns County GIS Division disclaims all responsibility for the accuracy or completeness of the data shown hereon.

Date Created: 4/10/2024

FUTURE LAND-USE MAP

April 10, 2024

Ponte Vedra Inn & Club Golf Club Patio




NORTH

THIS MATERIAL REPRESENTS DEVELOPMENT CONCEPTS AND ARCHITECTURAL AND OTHER DESIGN CONCEPTS BEING CONSIDERED AT THE TIME IT WAS PRODUCED. THIS INFORMATION IS SUBJECT TO REVISIONS AND MODIFICATIONS WITHOUT NOTICE. ALL ORAL AND WRITTEN INFORMATION, DESCRIPTIONS, PLANS, COPY, GRAPHICS, PHOTOGRAPHY, CHARTS, GRAPHS AND RENDERINGS MAY BE MODIFIED AT ANY TIME AND SHOULD NOT BE RELIED UPON AS FINAL.

planning
 architecture
 landscape architecture
 urban design
 visual communication



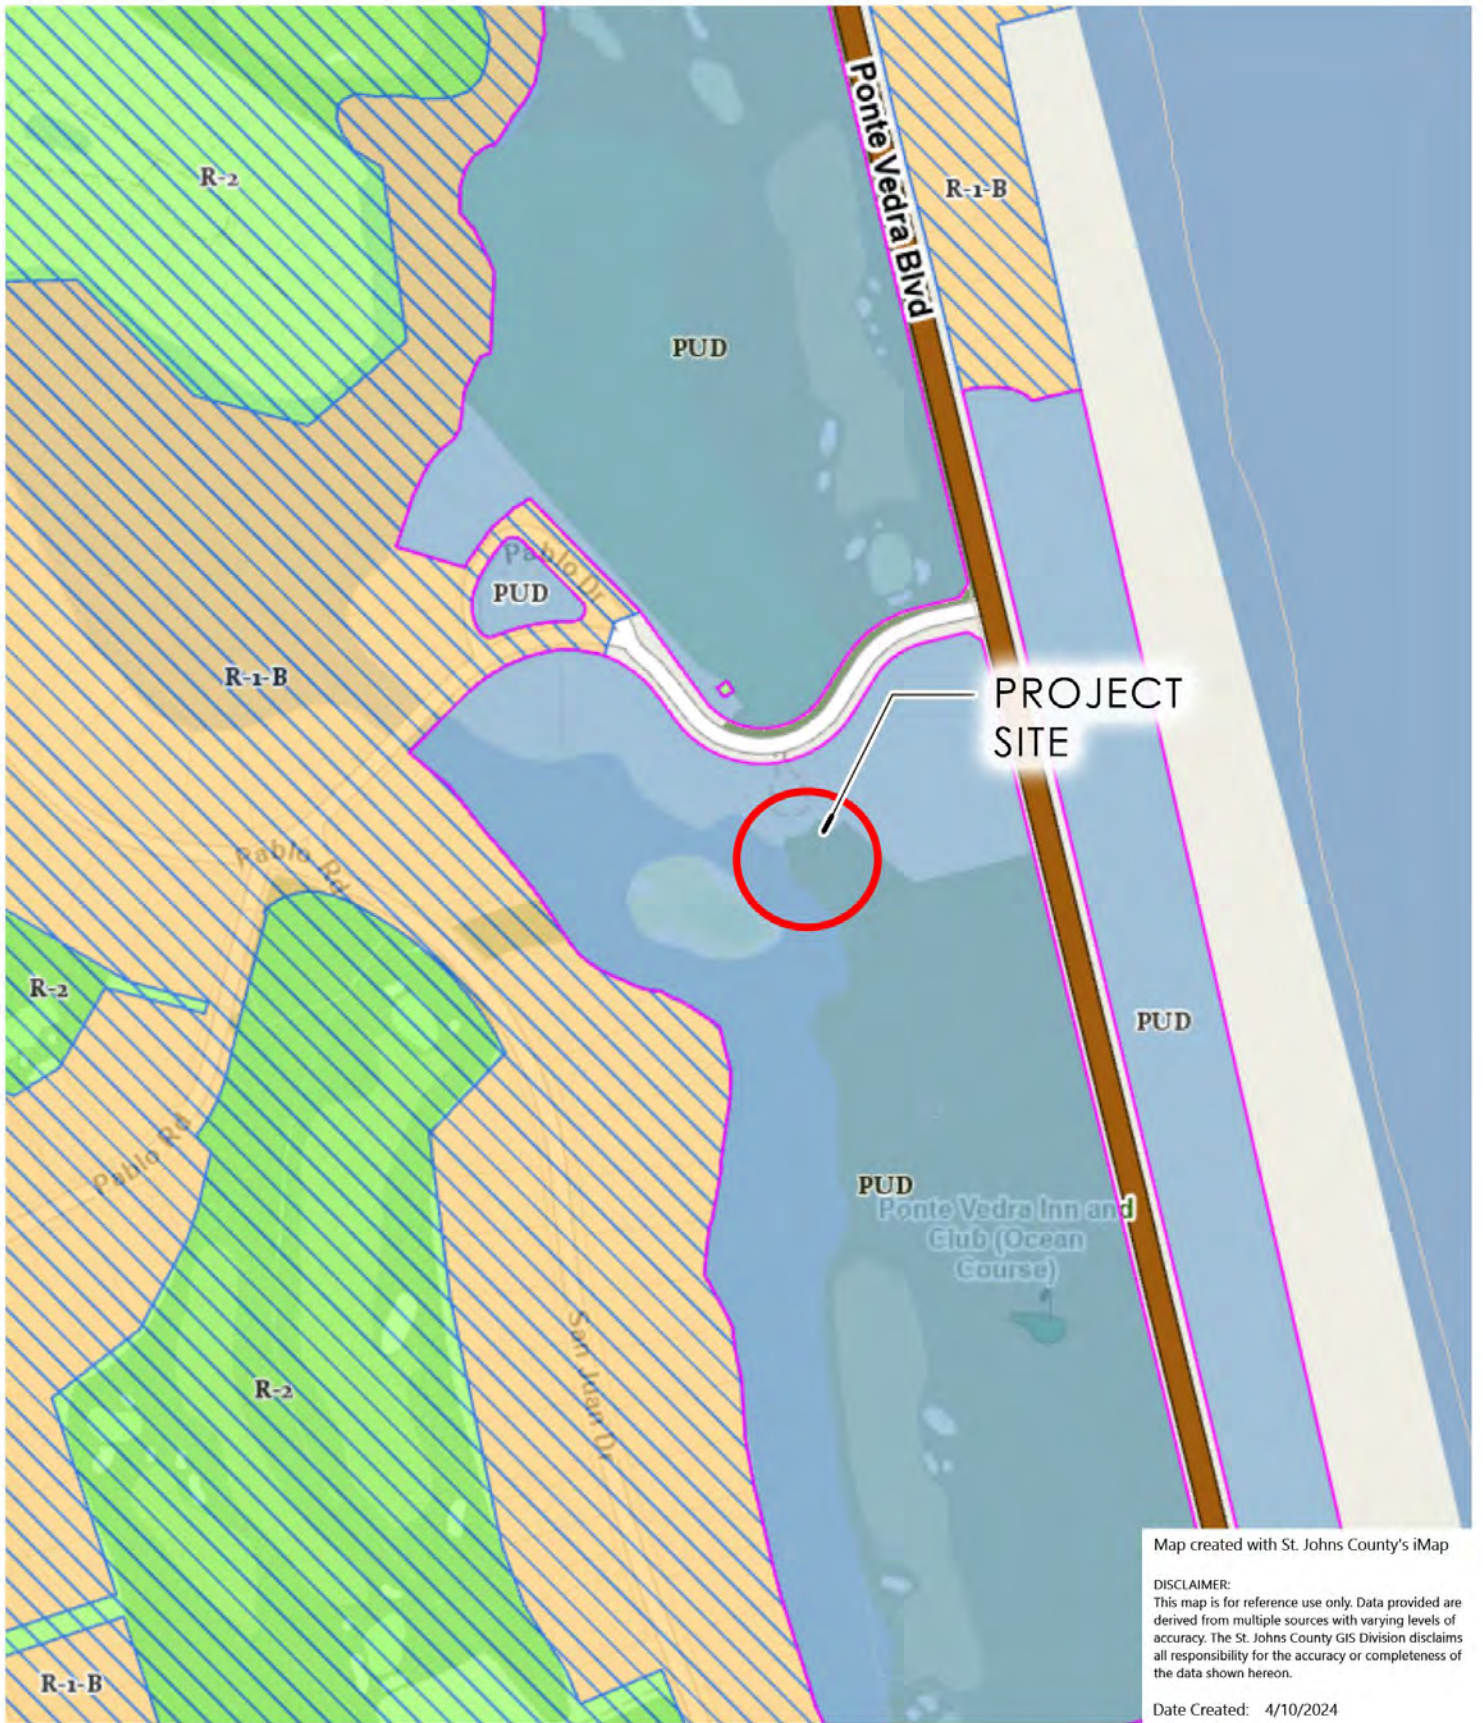

ZONING MAP

April 10, 2024

Ponte Vedra Inn & Club Golf Club Patio



THIS MATERIAL REPRESENTS DEVELOPMENT CONCEPTS AND ARCHITECTURAL AND OTHER DESIGN CONCEPTS BEING CONSIDERED AT THE TIME IT WAS PRODUCED. THIS INFORMATION IS SUBJECT TO REVISIONS AND MODIFICATIONS WITHOUT NOTICE. ALL ORAL AND WRITTEN INFORMATION, DESCRIPTIONS, PLANS, COPY, GRAPHICS, PHOTOGRAPHY, CHARTS, GRAPHS AND RENDERINGS MAY BE MODIFIED AT ANY TIME AND SHOULD NOT BE RELIED UPON AS FINAL.

planning
architecture
landscape architecture
urban design
visual communication





PROJECT
SITE

Map created with St. Johns County's iMap

DISCLAIMER:
This map is for reference use only. Data provided are derived from multiple sources with varying levels of accuracy. The St. Johns County GIS Division disclaims all responsibility for the accuracy or completeness of the data shown hereon.

Date Created: 4/10/2024

AERIAL MAP

Ponte Vedra Inn & Club Golf Club Patio

April 10, 2024




NORTH

THIS MATERIAL REPRESENTS DEVELOPMENT CONCEPTS AND ARCHITECTURAL AND OTHER DESIGN CONCEPTS BEING CONSIDERED AT THE TIME IT WAS PRODUCED. THIS INFORMATION IS SUBJECT TO REVISIONS AND MODIFICATIONS WITHOUT NOTICE. ALL ORAL AND WRITTEN INFORMATION, DESCRIPTIONS, PLANS, COPY, GRAPHICS, PHOTOGRAPHY, CHARTS, GRAPHS AND RENDERINGS MAY BE MODIFIED AT ANY TIME AND SHOULD NOT BE RELIED UPON AS FINAL.

planning
architecture
landscape architecture
urban design
visual communication



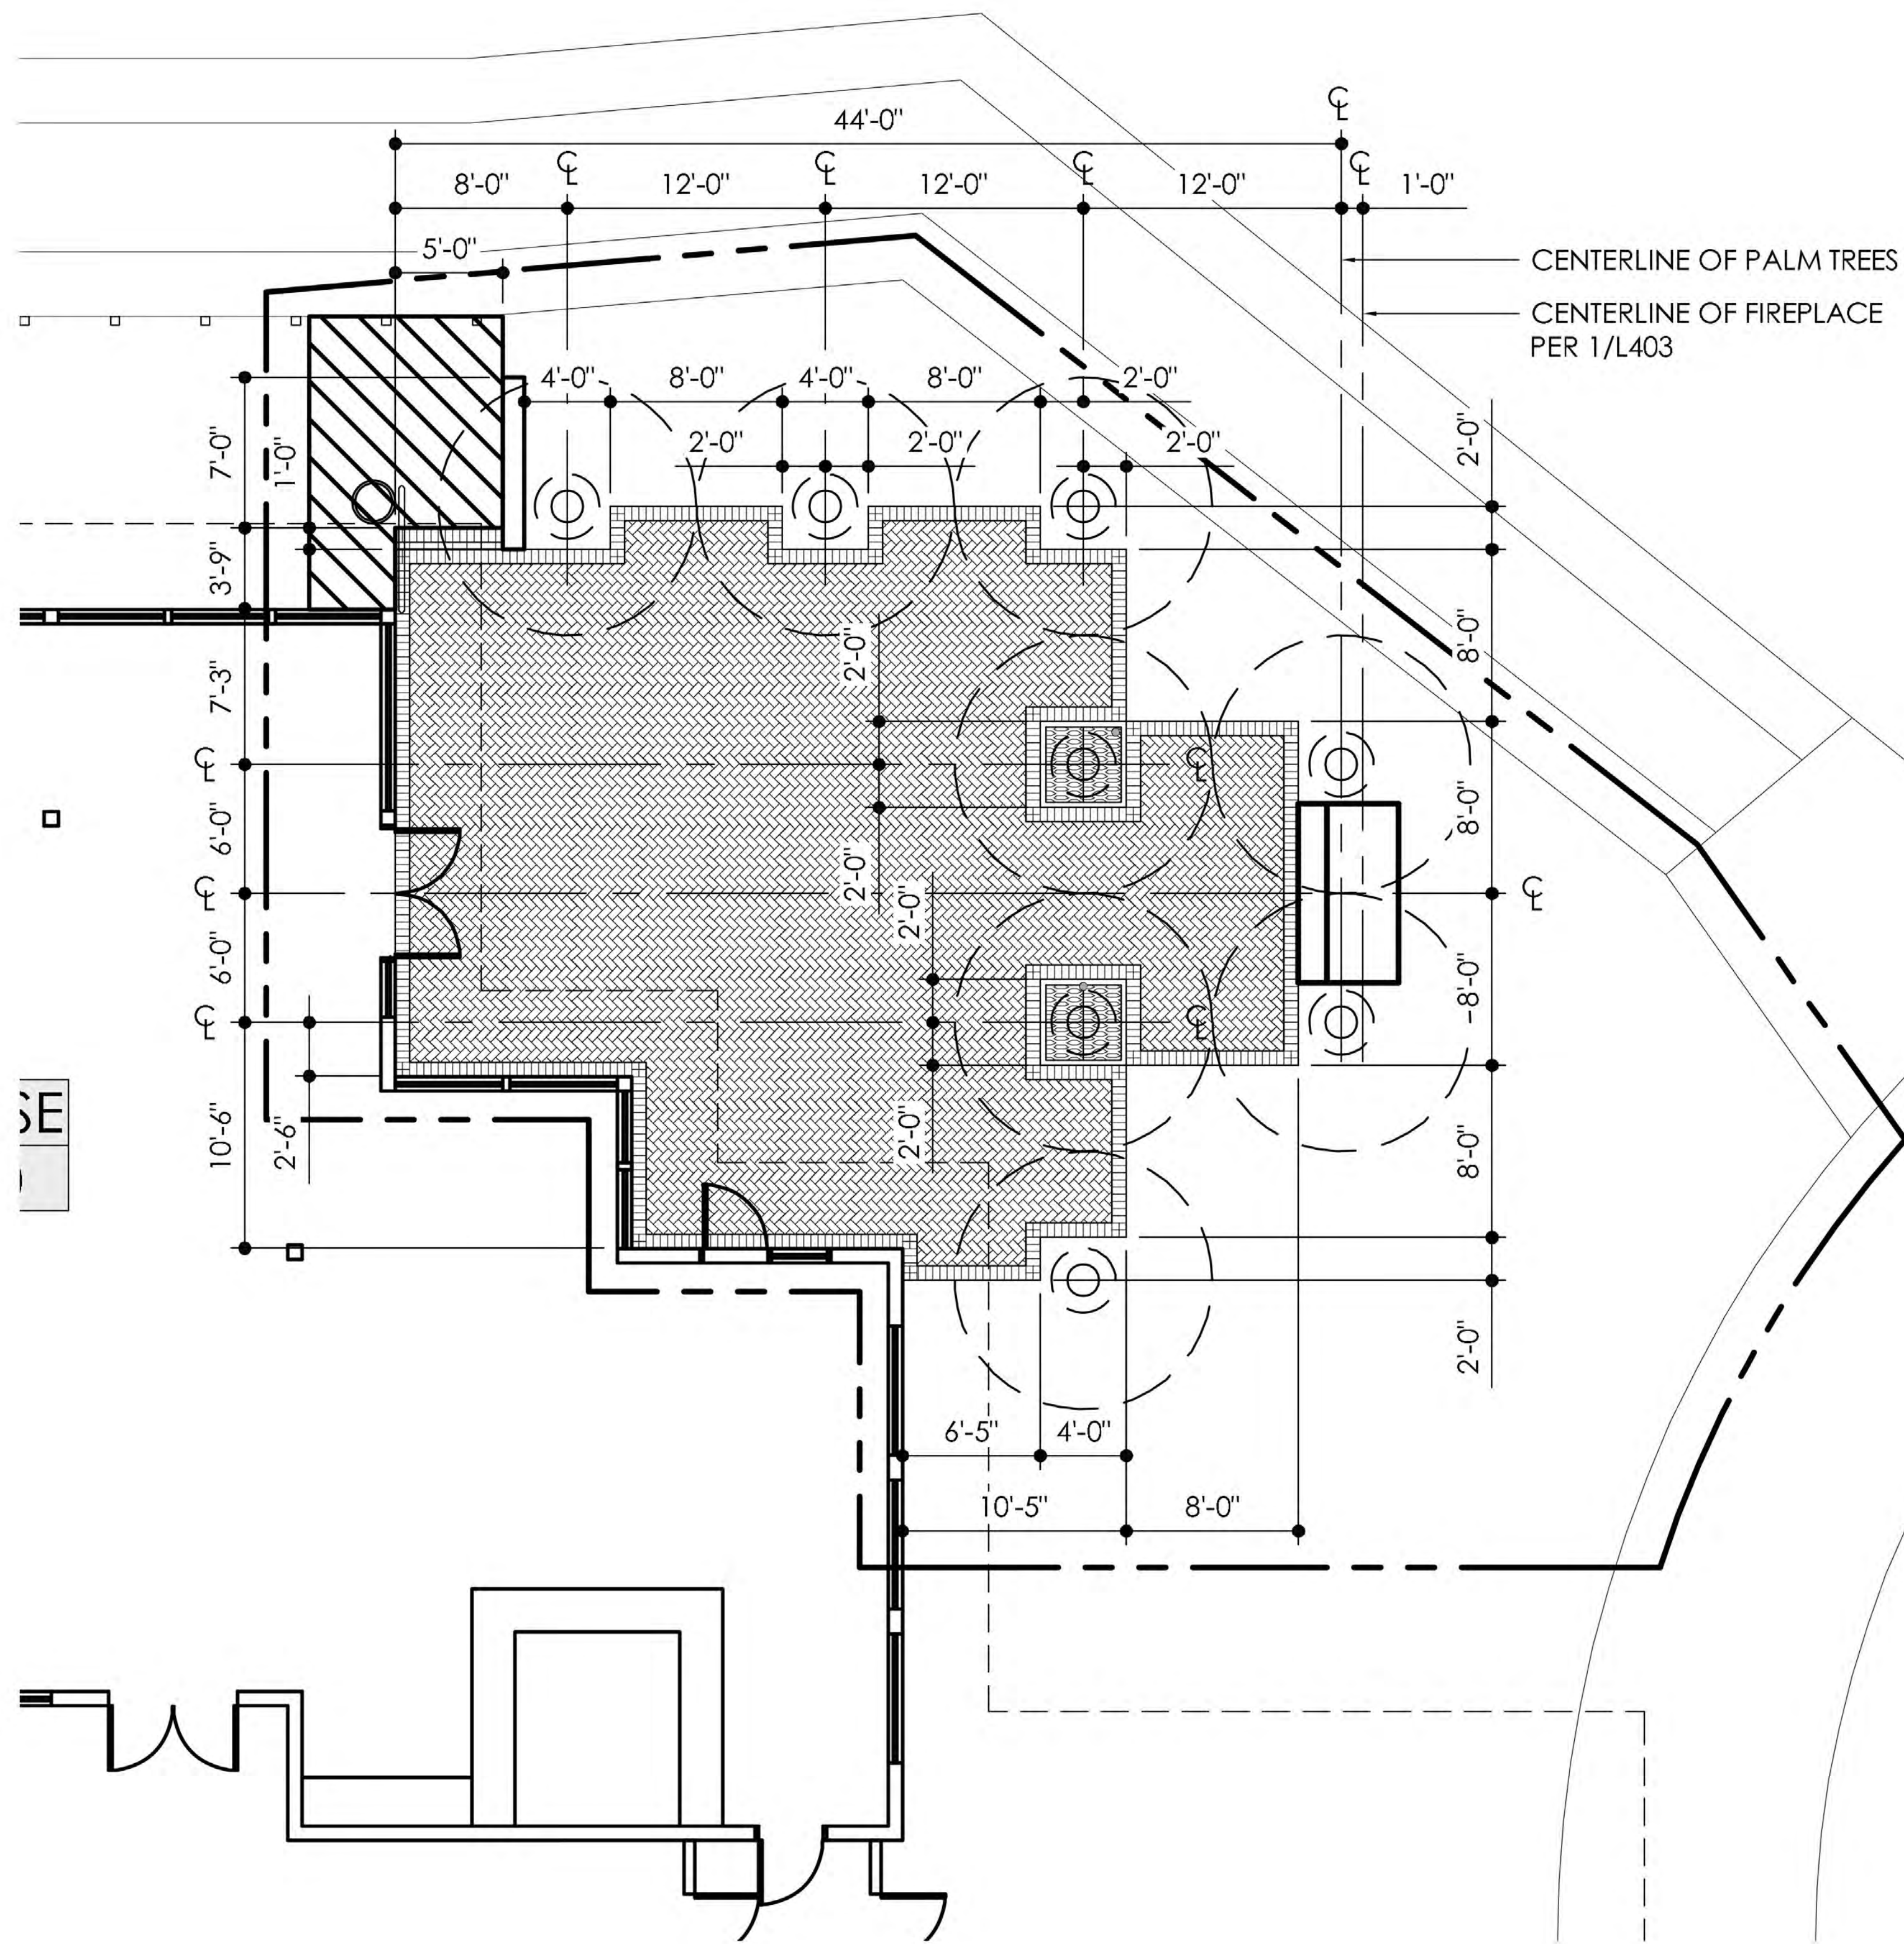

4" X 8" CONCRETE PAVER
 HERRINGBONE PATTERN
 COLOR: HERITAGE (PRIMARY COLOR) 2%-5% RANDOM
 MIX OF CHARCOAL AND TAN BY TREMRON (OR SIMILAR)
 MATCH EXISTING PAVER PATTERNS AND MIX USED FOR
 OTHER PATIO AREAS



MATCH PAVER
 COLOR/STYLE


PAVER AREA BEHIND PONTE VEDRA HISTORIC INN, NEAR THE 1ST TEE FOR THE
 OCEAN GOLF COURSE

2 LAYOUT PLAN
 1" = 10'-0"


GOLF CLUB OUTDOOR BAR RENOVATION

Proposed Materials

THIS MATERIAL REPRESENTS DEVELOPMENT CONCEPTS AND ARCHITECTURAL AND OTHER DESIGN CONCEPTS BEING CONSIDERED AT THE TIME IT WAS PRODUCED. THIS INFORMATION IS SUBJECT TO REVISIONS AND MODIFICATIONS WITHOUT NOTICE. ALL ORAL AND WRITTEN INFORMATION, DESCRIPTIONS, PLANS, COPY, GRAPHICS, PHOTOGRAPHY, CHARTS, GRAPHS AND RENDERINGS MAY BE MODIFIED AT ANY TIME AND SHOULD NOT BE RELIED UPON AS FINAL.

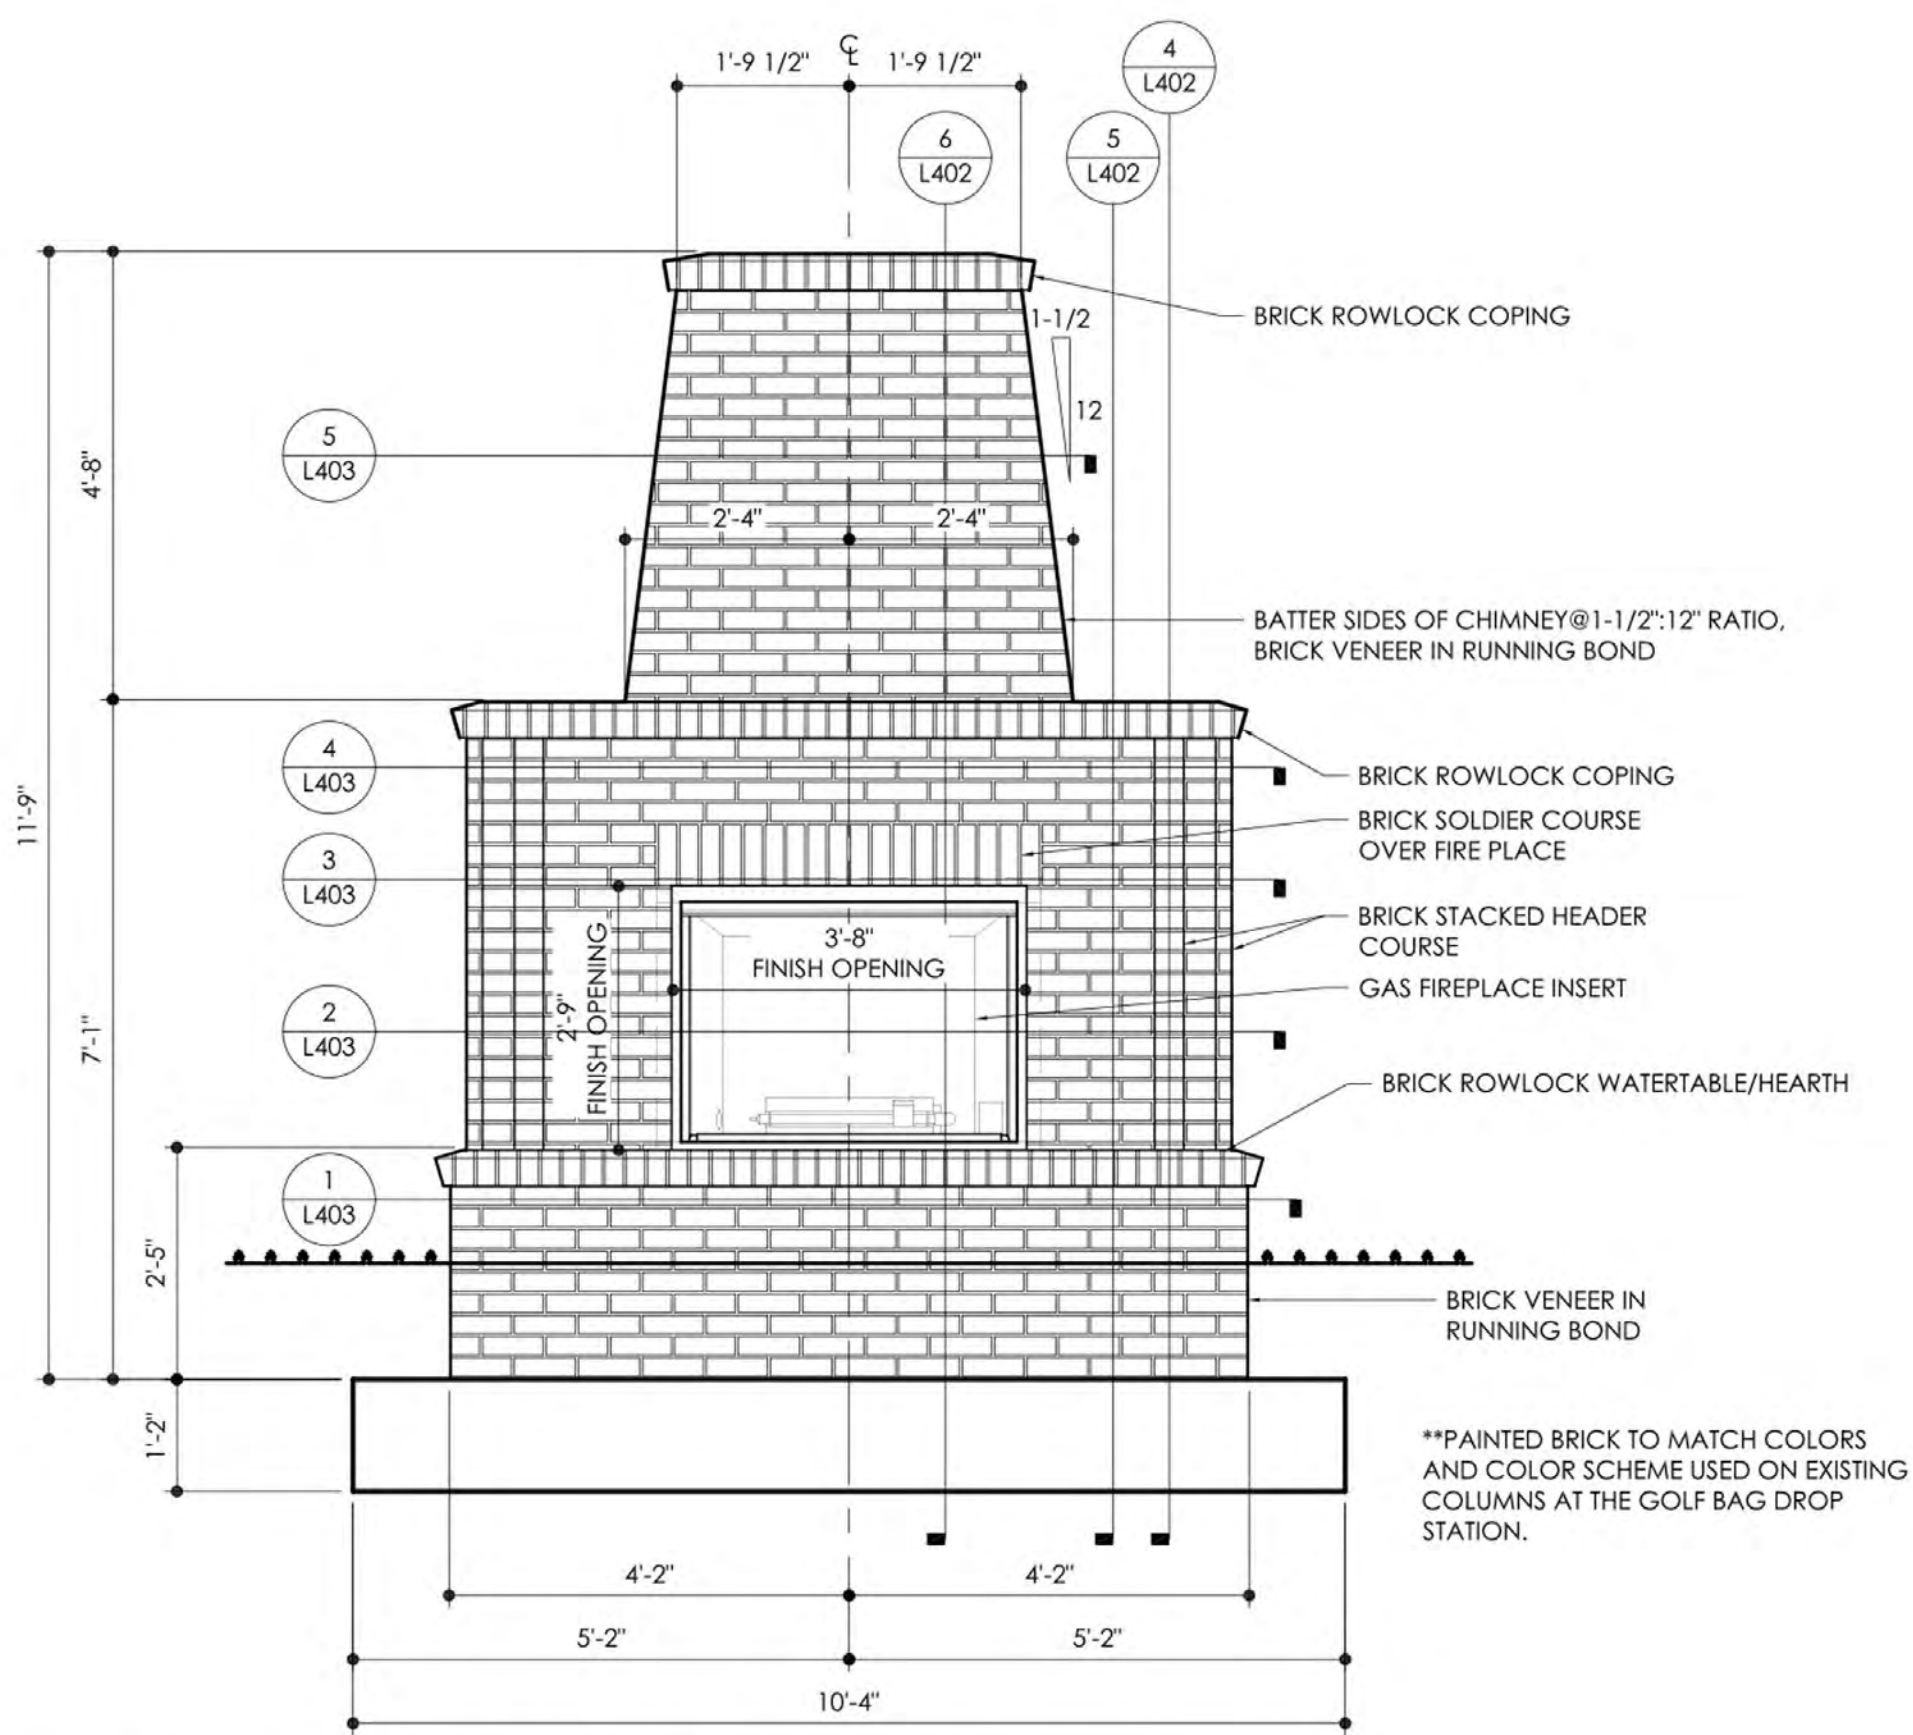


1 FIREPLACE - FRONT ELEVATION
1/2" = 1'-0"

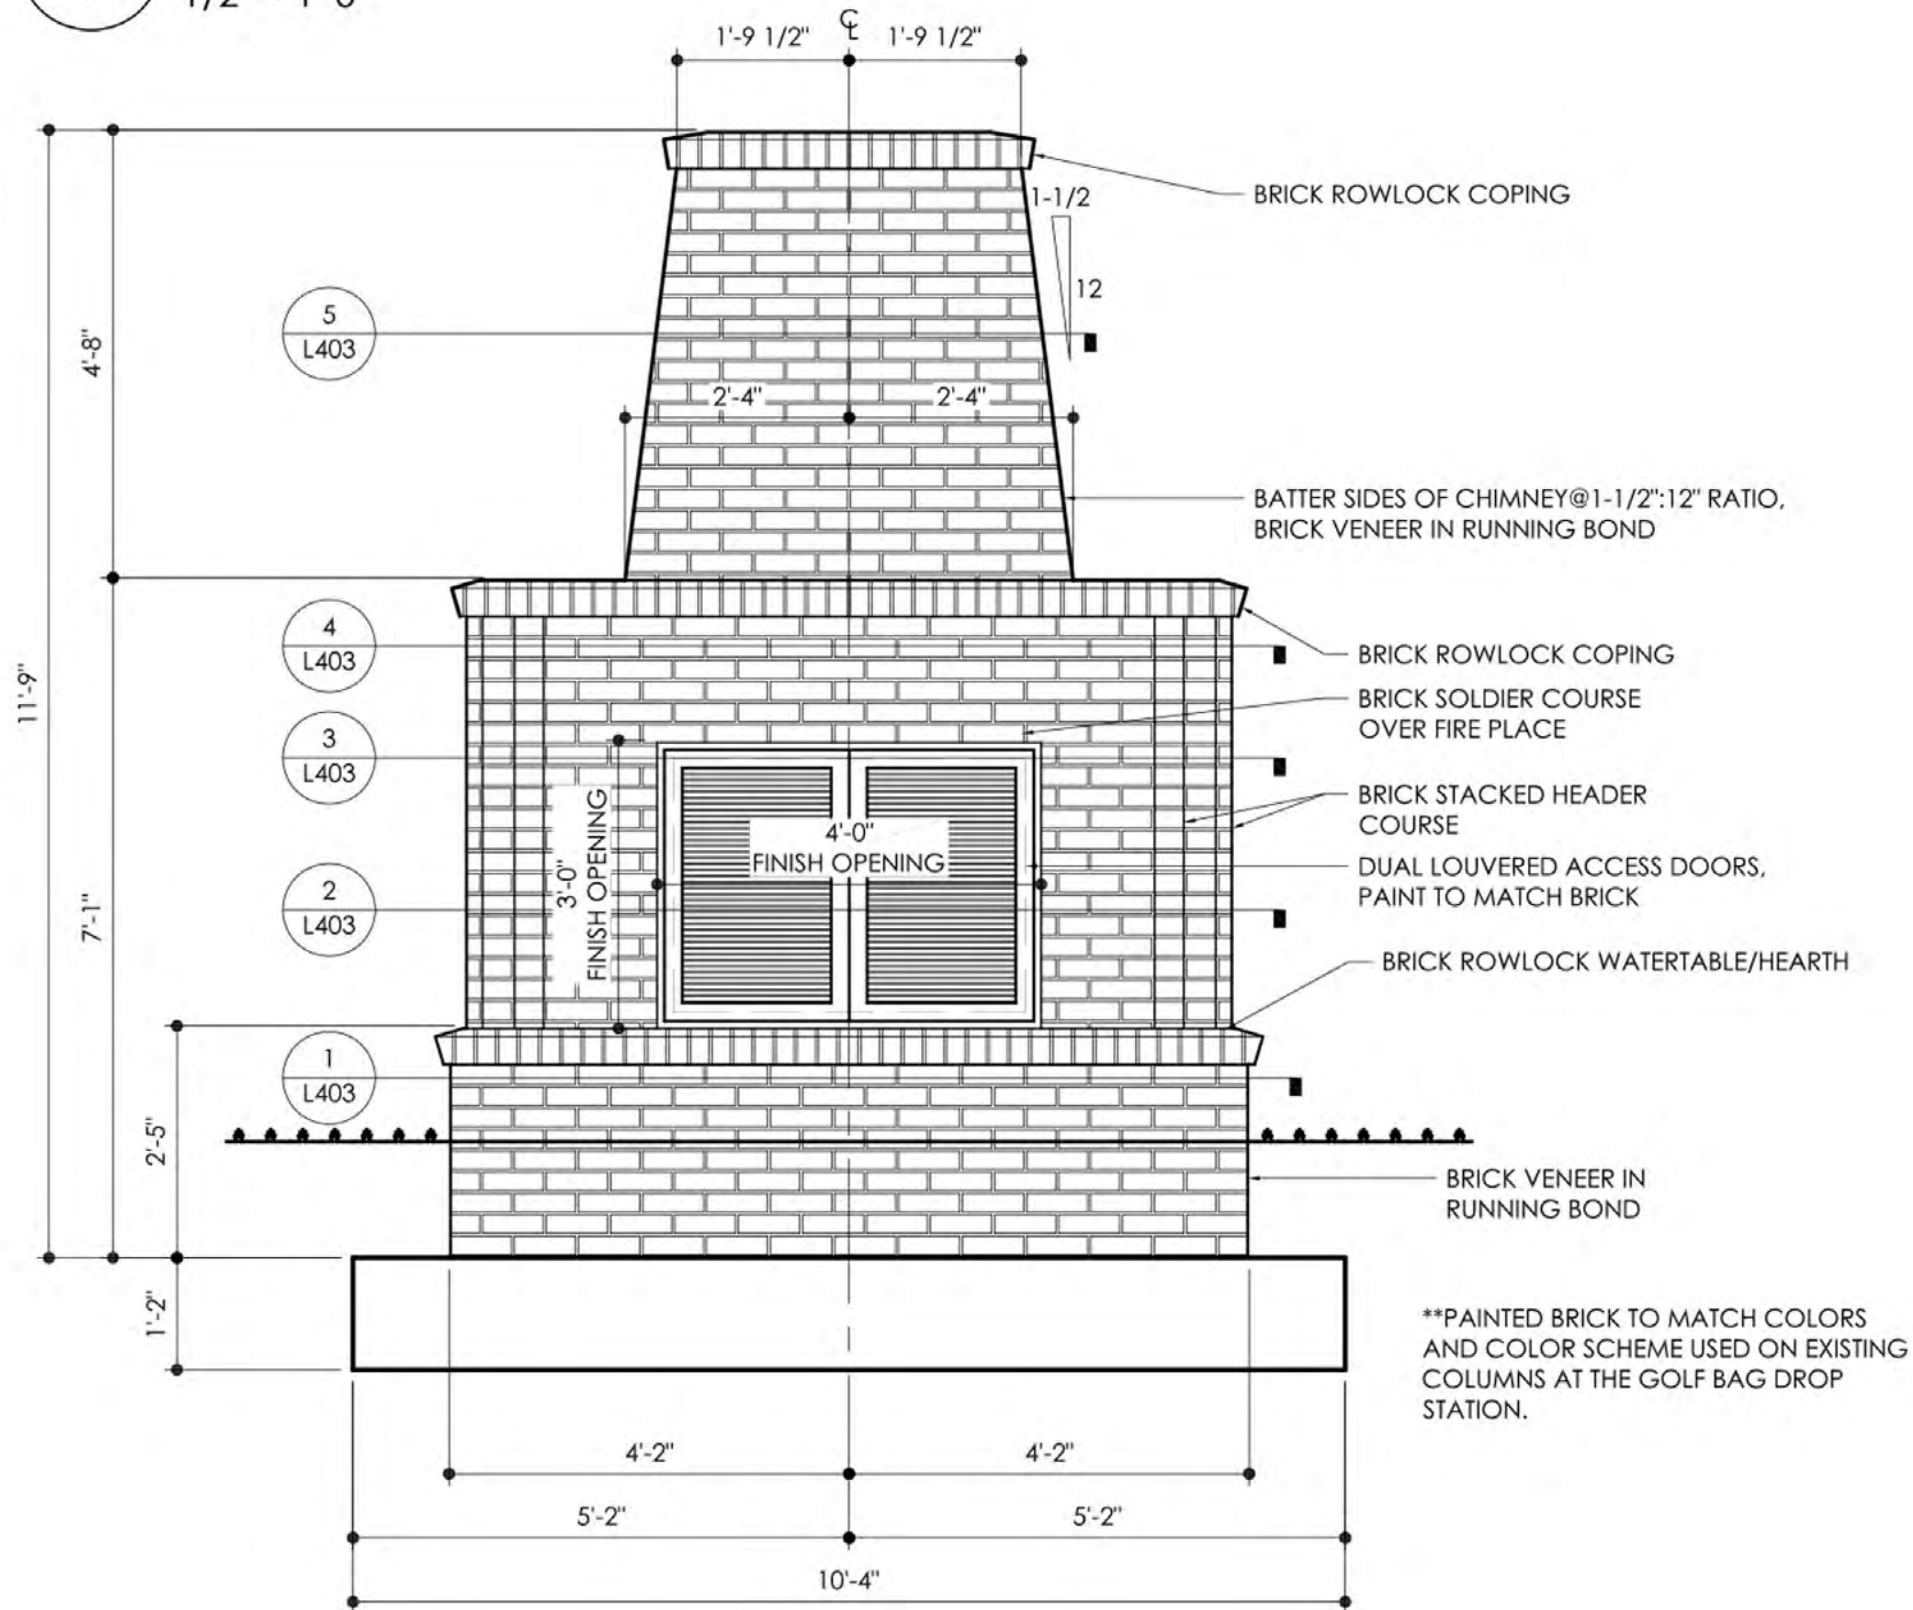

2 FIREPLACE - REAR ELEVATION
1/2" = 1'-0"




FIREPLACE PAINT TO MATCH EXISTING PAINT COLOR SCHEME FOR GOLF BAG DROP COLUMNS. CURRENTLY WHITE OR OFF-WHITE. COLOR TO BE MATCHED BY CONTRACTOR AT TIME OF PAINTING.

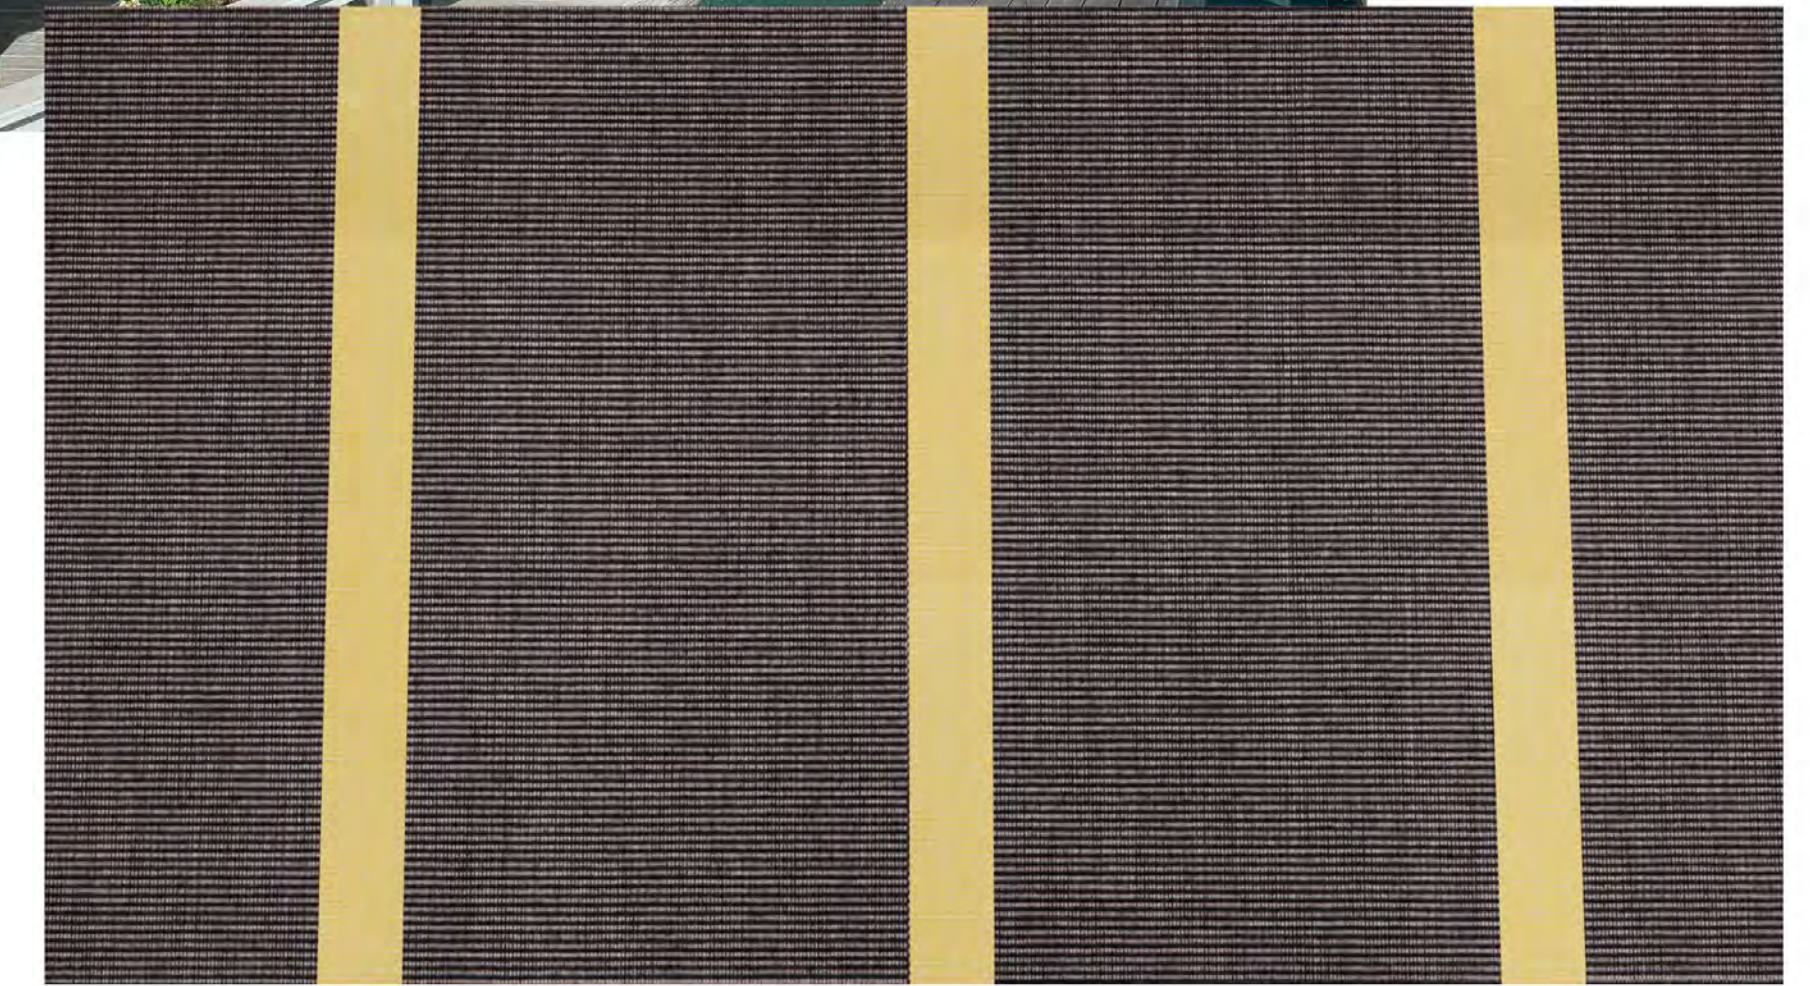

ADD ALTERNATE PATIO AWNING REPLACEMENT.

GOLF CLUB OUTDOOR BAR RENOVATION

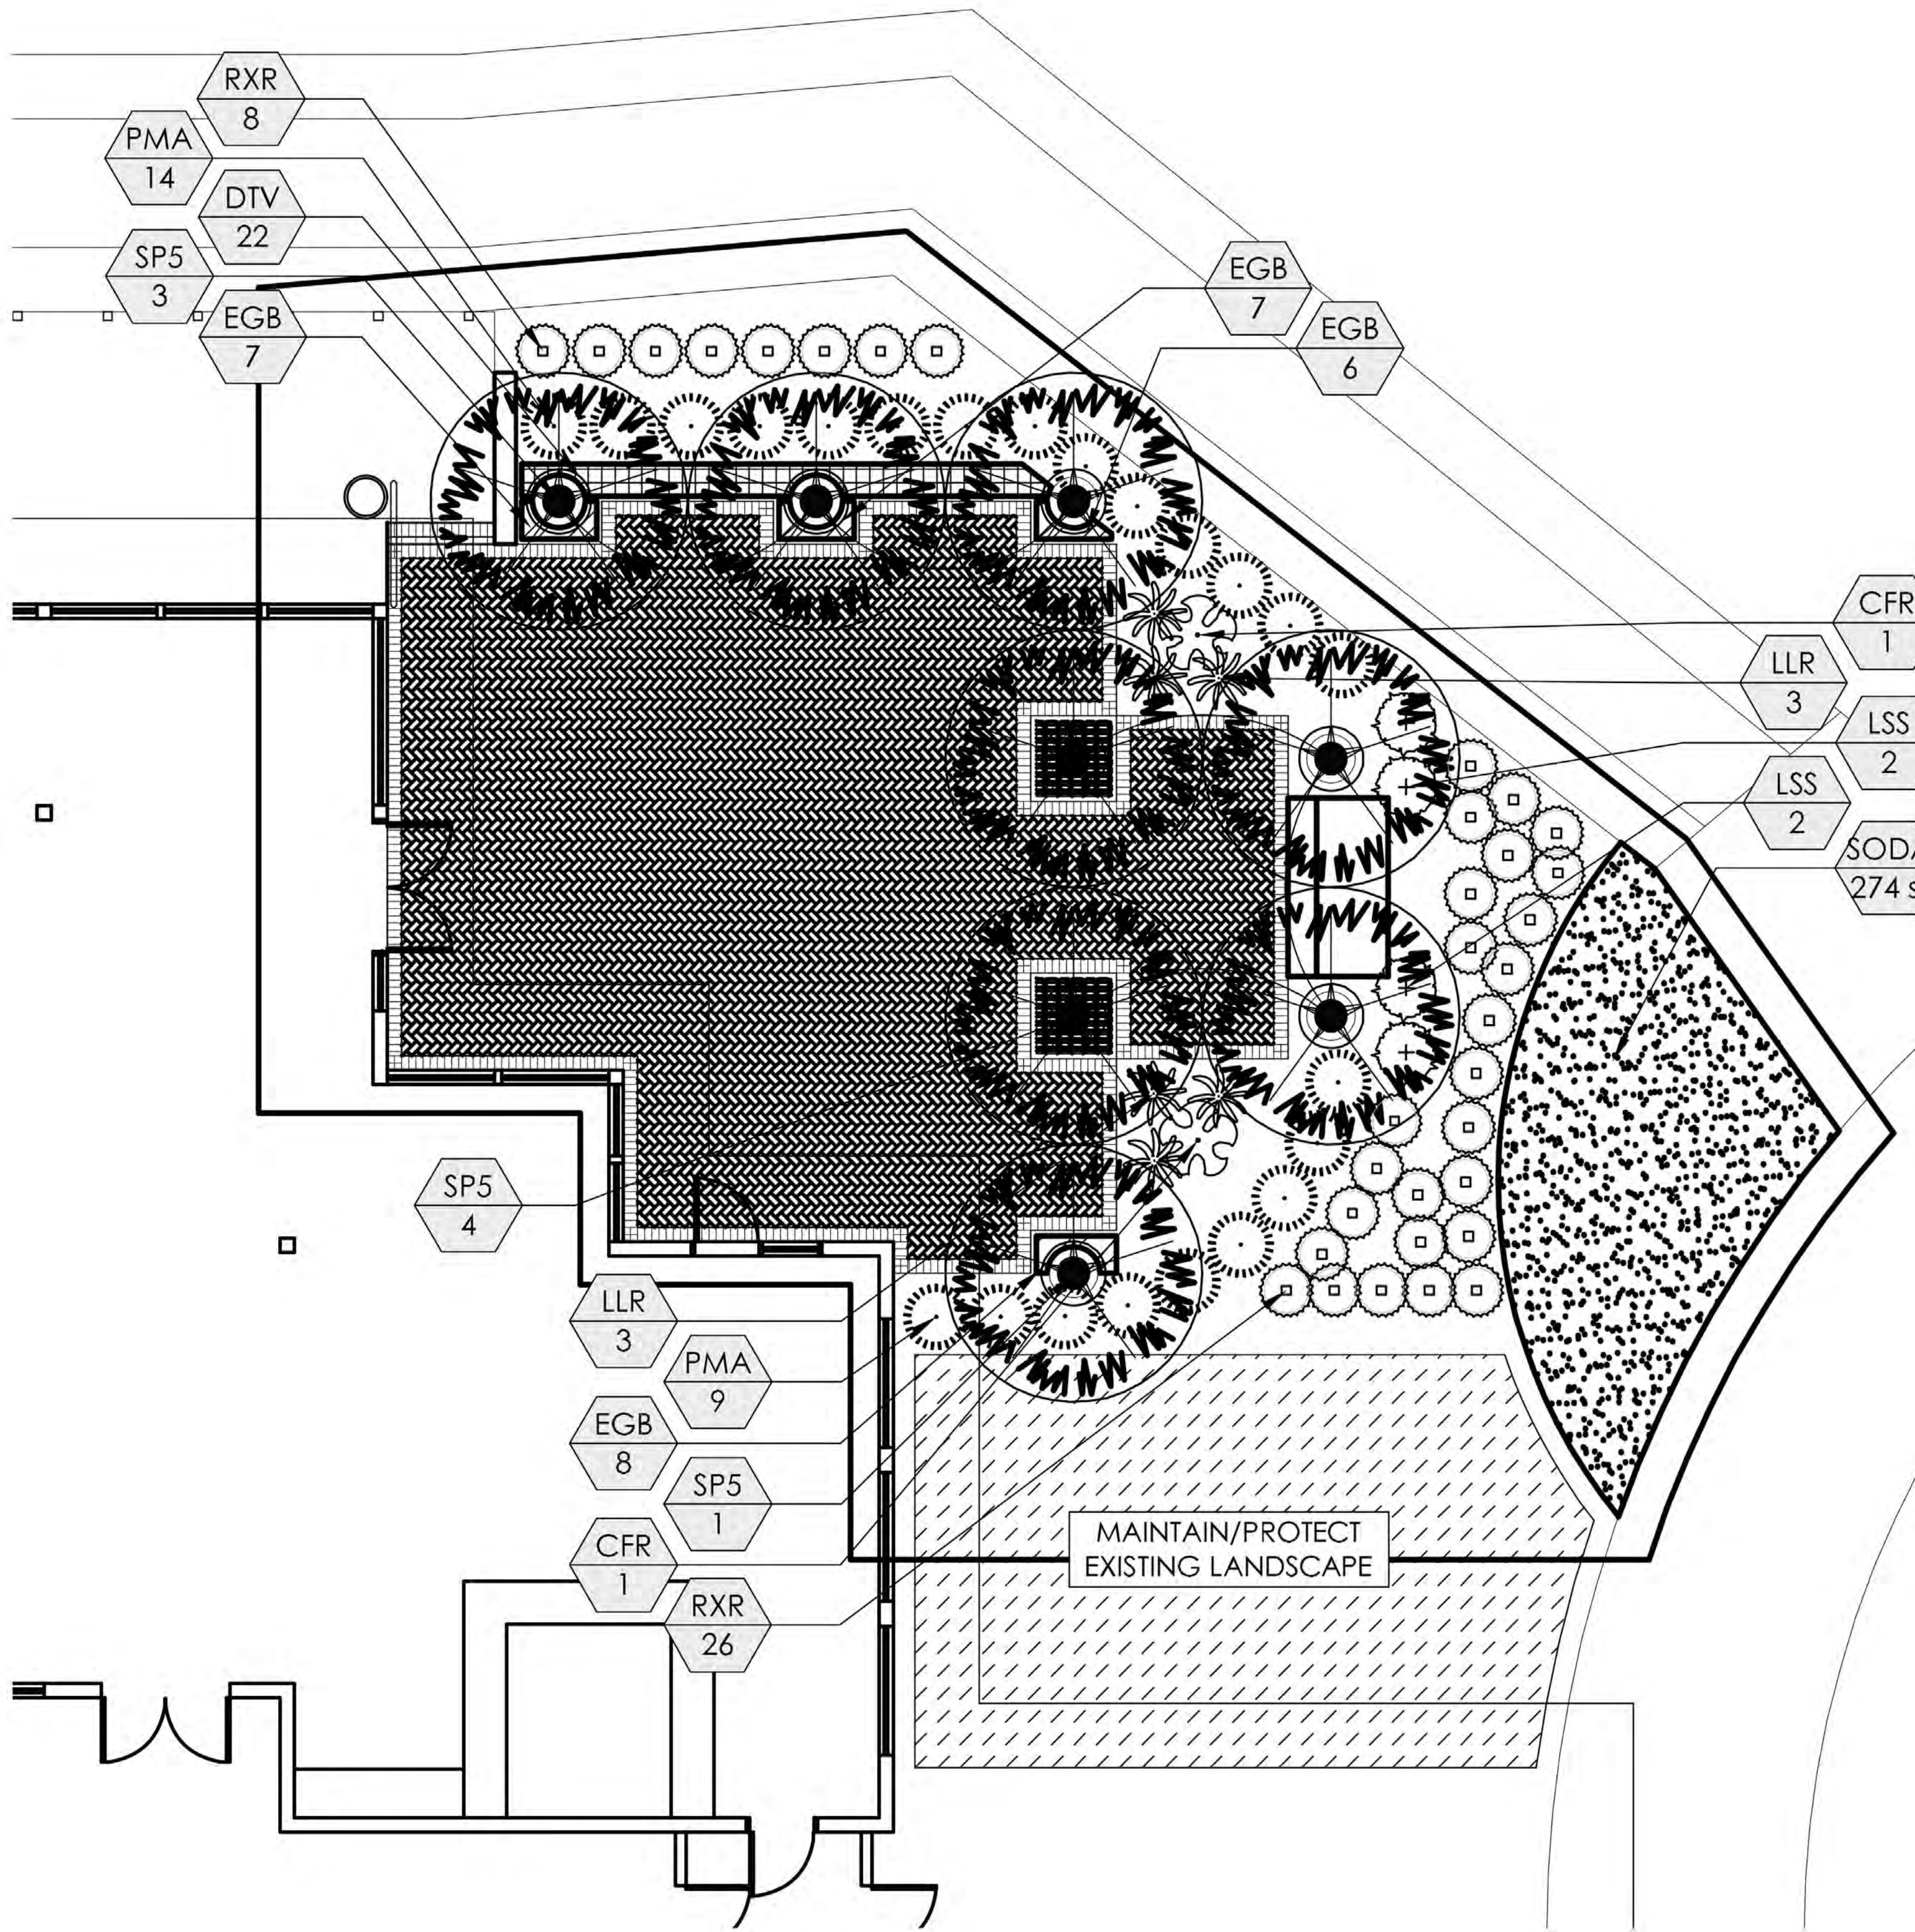


PLANT SCHEDULE								
SYMBOL	CODE	QTY	BOTANICAL NAME	COMMON NAME	NATIVE	SHADE	CANOPY	REMARKS
TREES								
	SP5	8	SABAL PALMETTO	SABAL PALM	YES	NO	11'	16' C.T. HEIGHT, ALL TRUNKS TO BE STRAIGHT, MATCHED HEADS
SHRUBS								
	CFR	2	CORDYLIN FRUITICOSA	TI PLANT	YES		42' o.c.	36" HEIGHT, 18"-24" SPREAD, 7 GAL, 42" OC
	LLR	6	LOMANDRA LONGIFOLIA 'ROMA 13'	PLATINUM BEAUTY VARIEGATED MAT RUSH	NO		36" o.c.	18"-21" HEIGHT AND SPREAD, 3 GAL, 36" OC
	LSS	4	LIGUSTRUM SINENSE 'SUNSHINE'	SUNSHINE CHINESE PRIVET	NO		36" o.c.	18"-24" HEIGHT AND SPREAD, 3 GAL, 36" OC
	PMA	23	PODOCARPUS MACROPHYLLUS	JAPANESE PODOCARPUS	A.S.		36" o.c.	30"-36" HEIGHT, 24" SPREAD MIN, 7 GAL, 36" OC
	RXR	34	RHODODENDRON X 'ROBLEZE'	AUTUMN STARBURST ENCORE AZALEA	YES		30" o.c.	18" X 18" HEIGHT AND SPREAD, 3 GAL, 30" OC. DWARF VARIETY OF REBLOOMING AZALEA, MATURE SIZE 3'-4' HEIGHT AND SPREAD
GROUND COVERS								
	DTV	22	DIANELLA TASMANICA 'VARIEGATA'	FLAX LILY	NO		18" o.c.	14"-18" HEIGHT, FULL PLANT, 1 GAL, 15" OC
	EGB	28	EVOLVULUS GLOMERATUS 'BLUE DAZE'	BRAZILIAN DWARF MORNING GLORY	NO		9" o.c.	4"-6" HEIGHT AND SPREAD, LINER, 9" OC
TURF GRASS								
	SODA	274 SF	STENOTAPHRUM SECUNDATUM 'FLORITAM'	FLORITAM ST. AUGUSTINE SOD	0			SOD - SEE SPECS

1 LANDSCAPE PLAN
1" = 10'-0"

GOLF CLUB OUTDOOR BAR RENOVATION


THIS MATERIAL REPRESENTS DEVELOPMENT CONCEPTS AND ARCHITECTURAL AND OTHER DESIGN CONCEPTS BEING CONSIDERED AT THE TIME IT WAS PRODUCED. THEY ARE NOT GUARANTEED TO BE ACCURATE AND ARE SUBJECT TO REVISIONS AND MODIFICATIONS WITHOUT NOTICE. ALL ORAL AND WRITTEN INFORMATION, DESCRIPTIONS, PLANS, COPIES, GRAPHICS, PHOTOGRAPHS, CHARTS, DRAWINGS AND REFERENCES MAY BE MODIFIED AT ANY TIME AND SHOULD NOT BE RELIED UPON AS FINAL.

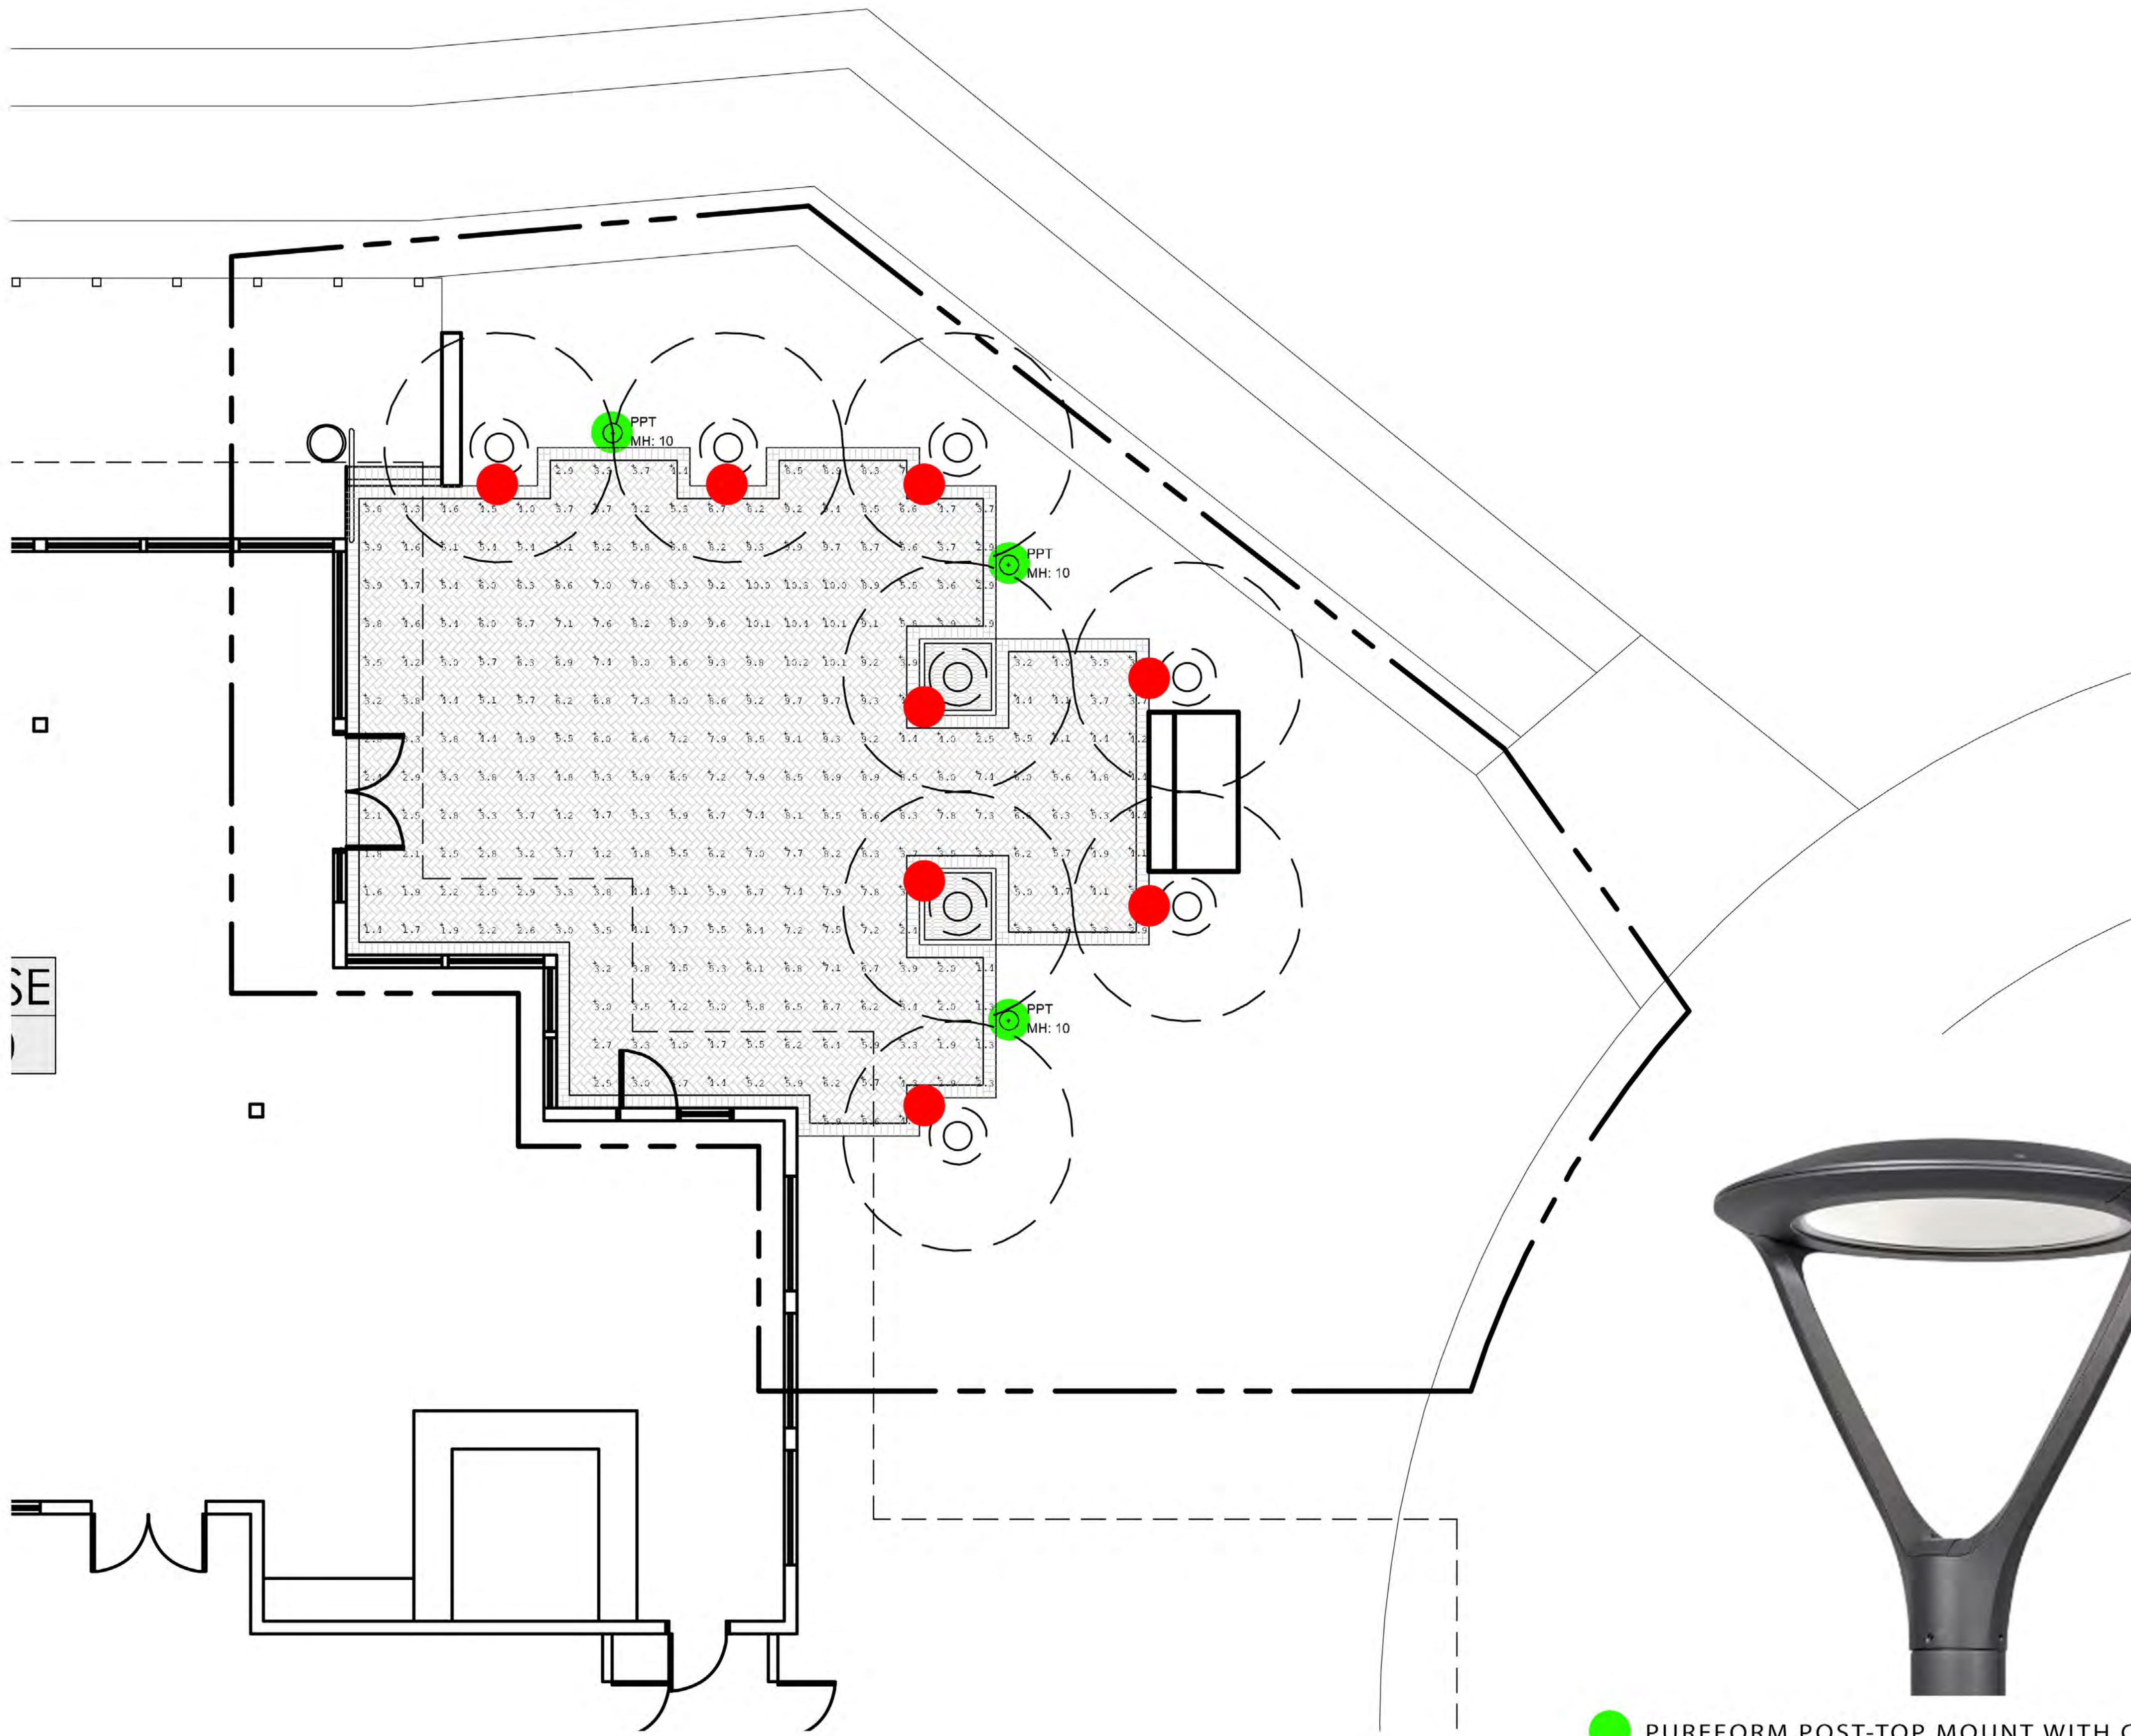

● BL9 FLEXSCAPE LED
BY HADCO
COLOR: BLACK



● PUREFORM POST-TOP MOUNT WITH COMFORT
OPTICS BY GARDCO
MOUNTING HEIGHT: 10'-0"
COLOR: BLACK

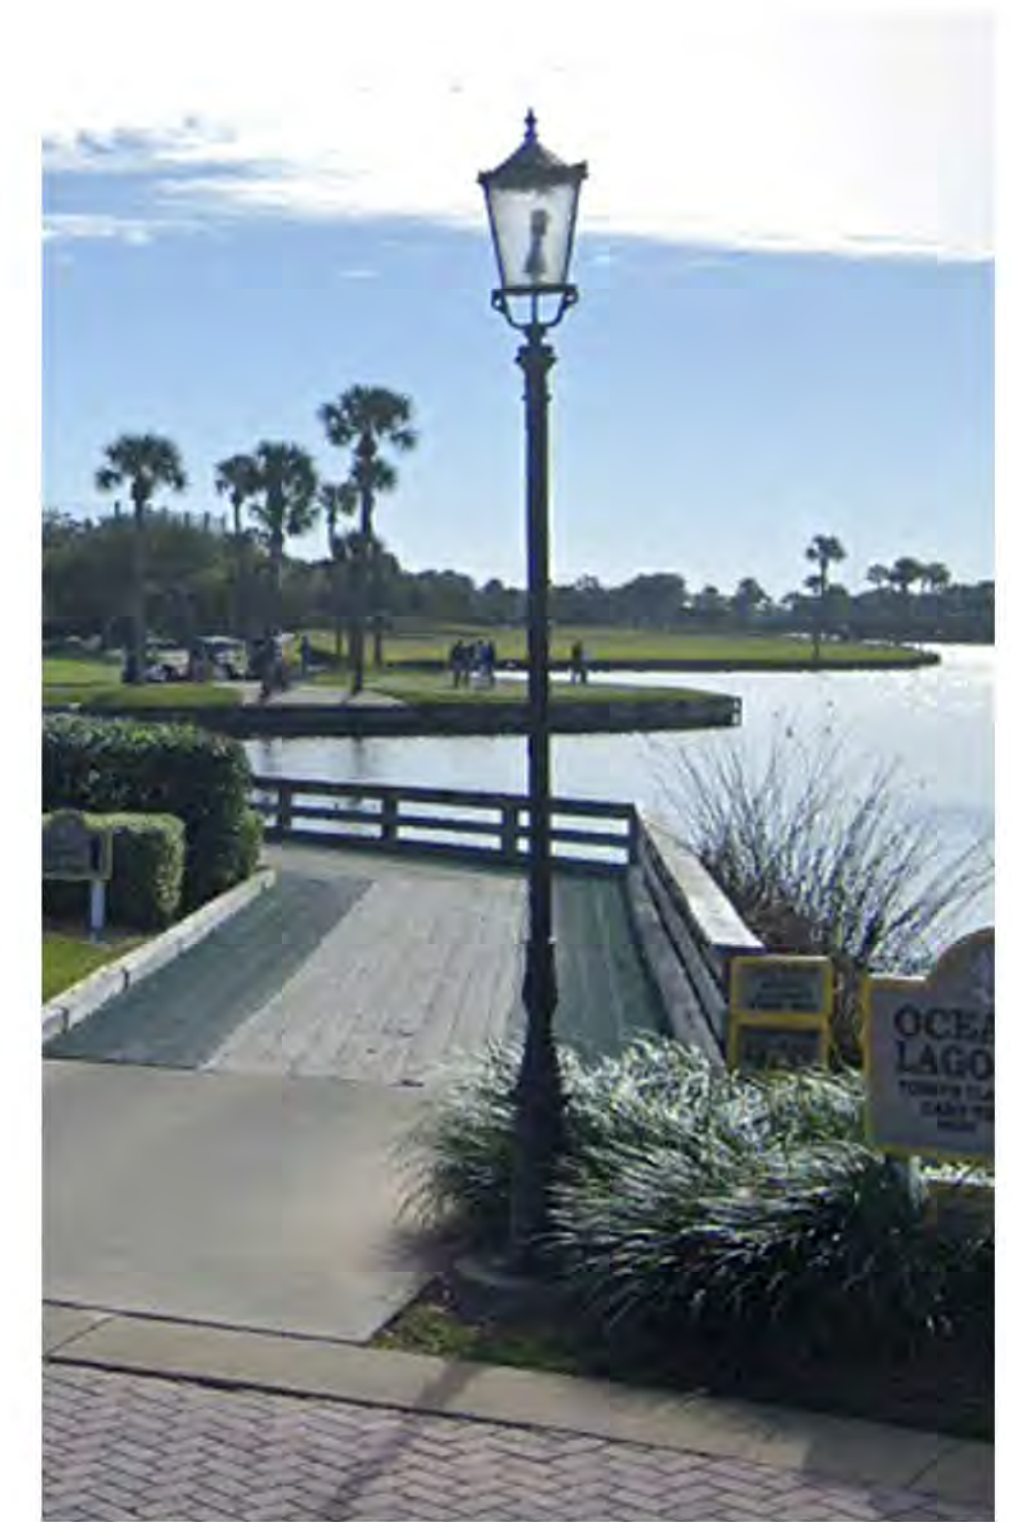

ALTERNATE FIXTURE
MATCH EXISTING ACORN-STYLE FIXTURE
MOUNTING HEIGHT: 10'-0"
COLOR: MATCH EXISTING

2 ELECTRICAL FIXTURE PLAN
1" = 10'-0"

GOLF CLUB OUTDOOR BAR RENOVATION

Proposed Materials

THIS MATERIAL REPRESENTS DEVELOPMENT CONCEPTS AND ARCHITECTURAL AND OTHER DESIGN CONCEPTS BEING CONSIDERED AT THE TIME IT WAS PRODUCED. THIS INFORMATION IS SUBJECT TO REVISIONS AND MODIFICATIONS WITHOUT NOTICE. ALL ORAL AND WRITTEN INFORMATION, DESCRIPTIONS, PLANS, COPY, GRAPHICS, PHOTOGRAPHY, CHARTS, GRAPHS AND RENDERINGS MAY BE MODIFIED AT ANY TIME AND SHOULD NOT BE RELIED UPON AS FINAL.



GOLF CLUB OUTDOOR BAR RENOVATION

PONTE VEDRA INN & CLUB

April 10, 2024

Proposed Materials

THIS MATERIAL REPRESENTS DEVELOPMENT CONCEPTS AND ARCHITECTURAL AND OTHER DESIGN CONCEPTS BEING CONSIDERED AT THE TIME IT WAS PRODUCED. THIS INFORMATION IS SUBJECT TO REVISIONS AND MODIFICATIONS WITHOUT NOTICE. ALL ORAL AND WRITTEN INFORMATION, DESCRIPTIONS, PLANS, COPY, GRAPHICS, PHOTOGRAPHY, CHARTS, GRAPHS AND RENDERINGS MAY BE MODIFIED AT ANY TIME AND SHOULD NOT BE RELIED UPON AS FINAL.

planning
architecture
landscape architecture
urban design
visual communication





GOLF CLUB OUTDOOR BAR RENOVATION

PONTE VEDRA INN & CLUB

April 10, 2024

Proposed Materials

THIS MATERIAL REPRESENTS DEVELOPMENT CONCEPTS AND ARCHITECTURAL AND OTHER DESIGN CONCEPTS BEING CONSIDERED AT THE TIME IT WAS PRODUCED. THIS INFORMATION IS SUBJECT TO REVISIONS AND MODIFICATIONS WITHOUT NOTICE. ALL ORAL AND WRITTEN INFORMATION, DESCRIPTIONS, PLANS, COPY, GRAPHICS, PHOTOGRAPHY, CHARTS, GRAPHS AND RENDERINGS MAY BE MODIFIED AT ANY TIME AND SHOULD NOT BE RELIED UPON AS FINAL.

planning
architecture
landscape architecture
urban design
visual communication

